


NAVAJO GALLUP WATER SUPPLY PROJECT REACH 26.3



Reach 26.3 To Torreon, NM September 2018 PROJECT DESCRIPTION

THE PROJECT CONSISTS OF CONSTRUCTION OF
3.06 MILES OF 10" PVC WATERLINE, 6.26 MILES OF 12" PVC WATERLINE,
(2x) 250K GALLON WATER STORAGE TANKS WITH CHLORINATOR

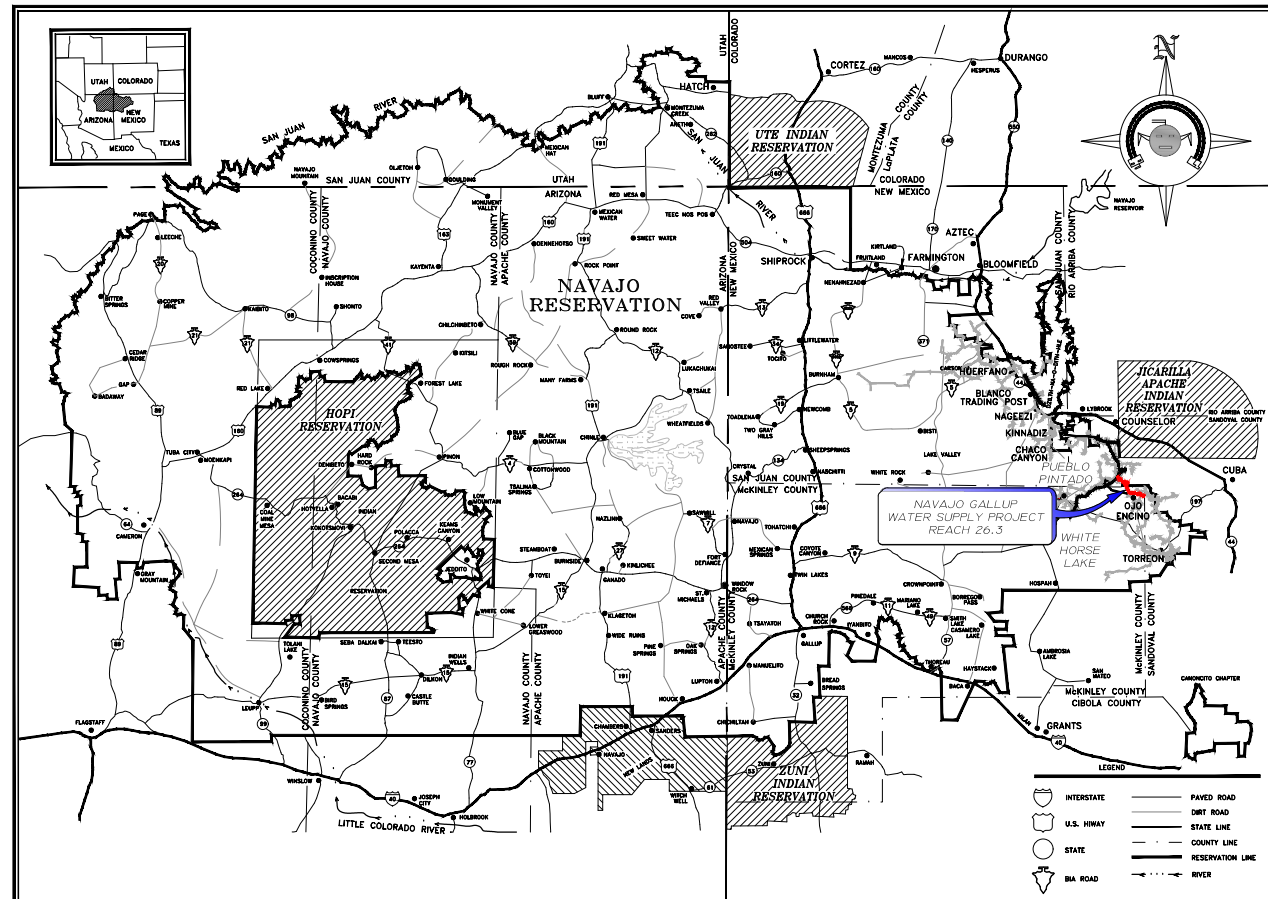


NAVAJO RESERVATION
PROJECT SITE MAP

90% DESIGN
DATE: September, 2018

DRAWING LIST

SHEET #	DESCRIPTION
G-1	COVER SHEET AND DRAWING LIST
G-2	GENERAL NOTES AND LEGEND
C-1	PROJECT SITE PLAN AND DRAWING KEY INDEX
C-2	SURVEY CONTROL PLAN (1 of 4)
C-3	SURVEY CONTROL PLAN (2 of 4)
C-4	SURVEY CONTROL PLAN (3 of 4)
C-5	SURVEY CONTROL PLAN (4 of 4)
C-6	PLAN & PROFILE STA 0+00 To STA 28+00
C-7	PLAN & PROFILE STA 28+00 To STA 56+00
C-8	PLAN & PROFILE STA 56+00 To STA 84+00
C-9	PLAN & PROFILE STA 84+00 To STA 112+00
C-10	PLAN & PROFILE STA 112+00 To STA 140+00
C-11	PLAN & PROFILE STA 140+00 To STA 165+00
C-12	PLAN & PROFILE STA 165+00 To STA 193+00
C-13	PLAN & PROFILE STA 193+00 To STA 221+00
C-14	PLAN & PROFILE STA 221+00 To STA 249+00
C-15	PLAN & PROFILE STA 249+00 To STA 277+00
C-16	PLAN & PROFILE STA 277+00 To STA 302+00
C-17	PLAN & PROFILE STA 302+00 To STA 323+00
C-18	PLAN & PROFILE STA 323+00 To STA 350+00
C-19	PLAN & PROFILE STA 350+00 To STA 374+00
C-20	PLAN & PROFILE STA 374+00 To STA 402+00
C-21	PLAN & PROFILE STA 402+00 To STA 430+00
C-22	PLAN & PROFILE STA 430+00 To STA 458+00
C-23	PLAN & PROFILE STA 458+00 To STA 486+00
C-24	PLAN & PROFILE STA 486+00 To STA 493+12.9
C-25	REACH 26.3 TANK SITE OVERALL PLAN
C-26	REACH 26.3 TANK SITE PLAN
C-27	REACH 26.3 TANK SITE GRADING
C-28	REACH 26.3 TANK SITE DRAIN PIPING AND ACCESS ROAD GRADING PLAN
C-29	REACH 26.3 TANK SITE PIPING PLAN
C-30	REACH 26.3 TANK SITE VALVE NUMBERING PLAN
C-31	REACH 26.3 CONTROL VALVE SITE PLAN
C-32	REACH 26.3 CONTROL VALVE SITE PIPING AND CONNECTION PLAN

NOTE: ALL NOTES IN RED ARE DESIGN NOTES ONLY AND WILL NOT BE INCLUDED IN THE FINAL PLAN SET. THESE ARE TO ASSIST IN INTERNAL DESIGN AND REVIEW ONLY.

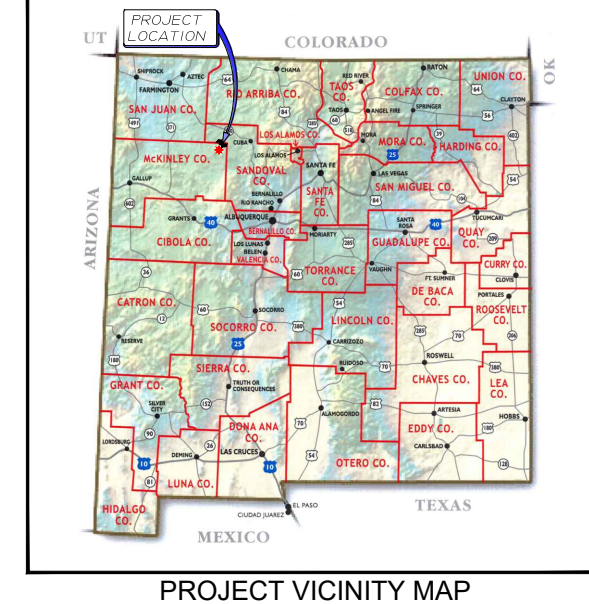

SHEET #	DESCRIPTION
DT-1	PIPELINE TRENCH DETAILS
DT-2	MISCELLANEOUS CONSTRUCTION DETAILS
DT-3	THRUST BLOCK AND MECHANICAL JOINT RESTRAINT DETAILS
DT-4	GAS LINE CROSSING DETAILS
DT-5	CASED ROAD CROSSING DETAIL
DT-6	PIPELINE AND SITE GATE VALVE DETAILS
DT-7	2 INCH VACUUM BREAKER WITH 1-INCH AIR RELEASE VALVE DETAIL
DT-8	2 INCH FLUSH WITH ORIFICE AND ABOVE-GRADE DISCHARGE DETAIL
DT-9	4 INCH FLUSH VALVE ABOVE-GRADE DISCHARGE DETAIL
DT-10	6 INCH CONTROL VALVE WITH PRESSURE RELIEF VAULT DETAIL (1 of 2)
DT-11	6 INCH CONTROL VALVE WITH PRESSURE RELIEF VAULT DETAIL (2 of 2)
DT-12	WASH CROSSING STA 49+00 PIPELINE HDD DETAIL
DT-13	WASH CROSSING STA 115+55 PIPELINE HDD DETAIL
DT-14	WASH CROSSING STA 435+97 PIPELINE HDD DETAIL
DT-15	TRANSDUCER VAULT DETAIL
DT-16	SENSOR LINE & YARD HYDRANT DETAILS
DT-17	NORTH TANK DETAILS (1 of 2)
DT-18	NORTH TANK DETAILS (2 of 2)
DT-19	SOUTH TANK DETAILS (1 of 2)
DT-20	SOUTH TANK DETAILS (2 of 2)
DT-21	TYPICAL WATER STORAGE TANK DETAILS (1 of 2)
DT-22	TYPICAL WATER STORAGE TANK DETAILS (2 of 2)
DT-23	CHLORINATION SYSTEM DETAILS (1 of 2)
DT-24	CHLORINATION SYSTEM DETAILS (2 of 2)
DT-25	PRECAST 2-ROOM CHLORINATION BUILDING AND PIPING
DT-26	PRECAST 2-ROOM CHLORINATION BUILDING DETAILS
DT-27	STANDARD FENCE DETAILS
DT-28	EROSION CONTROL DETAILS (1 of 3)
DT-29	EROSION CONTROL DETAILS (2 of 3)
DT-30	EROSION CONTROL DETAILS (3 of 3)
DT-31	TRAFFIC CONTROL (PAVED ROAD)
DT-32	TRAFFIC CONTROL (GRAVEL AND DIRT ROAD)
E001	GENERAL NOTES
E101	ELECTRICAL SITE PLAN
E102	CHLORINATION BUILDING ELECTRICAL PLANS
E103	CHLORINATION BUILDING SCADA SYSTEM AND CONTROL PLAN
E201	ELECTRICAL SCHEDULES AND DETAILS
E202	ELECTRICAL DIAGRAMS AND DETAILS
E203	ELECTRICAL DETAILS
E301	ELECTRICAL DETAILS
E302	ELECTRICAL DETAILS
E303	ELECTRICAL DETAILS

SOUDER, MILLER & ASSOCIATES
5454 VENCE AVENUE NE, SUITE D
ALBUQUERQUE, NM 87113
Phone (505) 299-0942 Toll-Free (877) 299-0942 Fax (505) 293-3430
www.soudermiller.com
Serving the Southwest & Rocky Mountains
Albuquerque, Carlsbad, Hobbs, Farmington, Las Cruces, Roswell, Santa Fe, NM
Cortez, Grand Junction, CO - Safford, AZ - Moab, UT - El Paso, TX



CLIENT: The Navajo Nation
TOWN: Reach 26.3 To Torreon, NM
COVER SHEET AND DRAWING LIST
NAVAJO GALLUP WATER SUPPLY
PROJECT - REACH 26.3
SANDOVAL & MCKINLEY COUNTIES, NEW MEXICO

Designed TTT Drawn MVA/AV Checked AGR

90% REVIEW
DRAFT

PRELIMINARY
NOT FOR CONSTRUCTION

THIS DRAWING IS INCOMPLETE
AND NOT TO BE USED FOR
CONSTRUCTION UNLESS IT IS
STAMPED, SIGNED AND DATED

NOTICE OF EXTENDED
PAYMENT PROVISION:
THIS CONTRACT ALLOWS THE
OWNER TO MAKE PAYMENT
WITHIN 45 DAYS AFTER
SUBMISSION OF
AN UNDISPUTED REQUEST
FOR PAYMENT.

811 Know what's
below.
Call before
you dig.

Date: September 27, 2018

Scale: Horiz: NONE
Vert: N/A

Project No: 6921307

Sheet: G-1

GENERAL NOTES

1. THE ENGINEER WAIVES ANY AND ALL RESPONSIBILITY AND IS NOT LIABLE FOR PROBLEMS THAT MAY ARISE FROM CONTRACTOR'S FAILURE TO FOLLOW THESE DRAWINGS, SPECIFICATIONS, AND THE DESIGN INTENT THEY CONVEY, OR FOR PROBLEMS ARISING FROM FAILURE TO OBTAIN AND/OR FOLLOW THE ENGINEER'S GUIDANCE WITH RESPECT TO ANY ERRORS, OMISSIONS, INCONSISTENCIES, AMBIGUITIES, OR CONFLICTS.
2. IF THERE IS A CONFLICT BETWEEN THE PLANS, SPECIFICATIONS AND/OR MANUFACTURER'S RECOMMENDATIONS FOR ANY DEVICE, PART, OR MATERIAL USED IN THE PROJECT, THE CONTRACTOR SHALL IMMEDIATELY NOTIFY THE ENGINEER, IN WRITING, FOR CLARIFICATION AT LEAST TWO WEEKS PRIOR TO CONSTRUCTION OF SAID DEVICE, PART, OR MATERIAL.
3. IT IS THE RESPONSIBILITY OF THE CONTRACTOR TO FAMILIARIZE HIMSELF WITH THE LOCATION OF ALL UTILITIES LOCATED WITHIN THE LIMITS OF CONSTRUCTION. THE GENERAL LOCATION OF KNOWN EXISTING UTILITIES HAS BEEN SHOWN ON THE CONSTRUCTION DRAWINGS TO INDICATE THAT CAUTION MUST BE EXERCISED WHEN WORKING IN THESE AREAS. IN MANY CASES THE EXACT LOCATION OF THE FACILITIES IS NOT KNOWN. THE CONTRACTOR SHALL BE RESPONSIBLE FOR LOCATING AND PROTECTING ALL OVERHEAD AND UNDERGROUND UTILITIES WITHIN THE VICINITY OF THE NEW CONSTRUCTION. PRIOR TO THE START OF CONSTRUCTION, THE CONTRACTOR, WORKING WITH THE RESPECTIVE UTILITY COMPANIES, SHALL ACCURATELY LOCATE AND MARK ALL BURIED FACILITIES, INCLUDING SERVICE LINES. ALL EQUIPMENT LABOR, ETC. NECESSARY TO PROPERLY LOCATE THE EXISTING UTILITIES SHALL BE FURNISHED BY THE CONTRACTOR, THE COST OF WHICH SHALL BE INCIDENTAL TO THE WORK.
4. CONTRACTOR SHALL REPAIR ANY EXISTING STRUCTURE OR UTILITY PIPELINE DAMAGED DURING THE EXECUTION OF THE PROJECT, AT NO ADDITIONAL COSTS TO THE OWNER.
5. CONTRACTOR IS SOLELY RESPONSIBLE FOR CONSTRUCTING THE PROJECT ACCORDING TO CURRENT NEW MEXICO STANDARD SPECIFICATIONS FOR PUBLIC WORKS CONSTRUCTION (NMSPWC) AWWA SPECS AND NAVAJO NATION / NTUA STANDARDS, INCLUDING WHERE PARTICULAR WORK ITEMS ARE NOT SPECIFIED HEREIN.
6. CONTRACTOR SHALL COMPLY WITH ALL REQUIREMENTS AS SET FORTH IN THE TECHNICAL SPECIFICATIONS AND CONTRACT DOCUMENTS. IT SHALL BE THE RESPONSIBILITY OF THE CONTRACTOR TO CONTACT THE ENGINEER REGARDING ANY QUESTION ARISING FROM ANY ASPECT OF THIS PROJECT NOT SPECIFICALLY COVERED IN THE PLANS AND TECHNICAL SPECIFICATIONS, OR ANY CHANGES OR CORRECTIONS TO THE PLANS AND SPECS.
7. THESE DRAWINGS DO NOT INCLUDE NECESSARY COMPONENTS FOR CONSTRUCTION SAFETY, WHICH SHALL REMAIN WHOLLY THE RESPONSIBILITY OF THE CONTRACTOR. ALL WORK ON THIS PROJECT SHALL BE PERFORMED IN ACCORDANCE WITH APPLICABLE FEDERAL (OSHA), STATE, TRIBAL AND LOCAL LAWS, RULES AND REGULATIONS CONCERNING SAFETY AND HEALTH. ALL EXCAVATION, TRENCHING AND SHORING ACTIVITIES MUST BE CARRIED OUT IN ACCORDANCE WITH OSHA 29 CFR 1926, SUBPART P - EXCAVATIONS.
8. CONTRACTOR SHALL PROVIDE INGRESS AND EGRESS TO ANY LOCAL BUSINESSES AND RESIDENTS AS REQUIRED FOR THE DURATION OF THE PROJECT. THE CONTRACTOR SHALL ADVISE OF AND SCHEDULE ACCESS CLOSURES AT LEAST 24 HOURS IN ADVANCE WITH PROPERTY OWNERS AND THE ENGINEER.
9. THE CONTRACTOR SHALL CONFINE HIS OPERATIONS TO THE CONSTRUCTION LIMITS OF THE PROJECT AND SHALL IN NO WAY ENCROACH ONTO ADJACENT PROPERTIES UNLESS LEGAL EASEMENTS ARE PROVIDED OR SECURED BY THE CONTRACTOR. THE CONTRACTOR WILL BE HELD RESPONSIBLE FOR ANY DAMAGE CAUSED BY CONSTRUCTION ACTIVITIES TO PUBLIC OR PRIVATE PROPERTY, INCLUDING UTILITIES.
10. THE DRAWINGS CONTAIN SPECIFIC EROSION CONTROL FEATURES DESIGNED BY THE ENGINEER TO PROTECT PROJECT FACILITIES FROM EROSION. THESE FEATURES ARE NOT DESIGNED TO PREVENT POLLUTION OF WATERWAYS DUE TO SEDIMENT. THE CONTRACTOR IS WHOLLY RESPONSIBLE TO PROVIDE A STORM WATER POLLUTION PREVENTION PLAN (SWPPP) AND IMPLEMENT THE BEST MANAGEMENT PRACTICES (BMPs) REQUIRED THEREIN, IN ADDITION TO THE FEATURES SHOWN ON THE DRAWINGS. ALL BID ITEMS REFERRING TO SPECIFIC EROSION CONTROL FEATURES, SUCH AS RIPRAP OR ROCK DAMS, ARE APPLICABLE ONLY TO FEATURES DESIGNED BY THE ENGINEER. A SEPARATE BID ITEM(S) IS PROVIDED FOR PREPARATION AND IMPLEMENTATION OF THE CONTRACTOR'S SWPPP.
11. ALL RIPRAP, ROCK CHECK DAMS AND OTHER EROSION CONTROL FEATURES SHOWN ON THE DRAWINGS ARE APPROXIMATE WITH REGARD TO QUANTITY, LOCATION, DIMENSIONS, SPACING, AND ORIENTATION. EXACT PLACEMENT WILL BE DETERMINED IN FIELD BY ENGINEER AFTER FINAL GRADING IS COMPLETE.
12. ALL AREAS DISTURBED BY THE CONSTRUCTION ACTIVITIES OF THIS PROJECT SHALL BE RESTORED AND RE-GRADED IN A MANNER ACCEPTABLE TO THE OWNER, ENGINEER, AND LAND OWNER. ALL DISTURBED AREAS SHALL BE RE-SEEDED PER THE CONTRACT DOCUMENTS.
13. FUSIBLE PVC PIPE SHALL BE USED IN LIEU OF ALL RESTRAINED JOINTS AND SHALL BE USED ON BOTH SIDES OF ALL ISOLATION VALVES, CASINGS, TEES, AND BENDS. REFER TO SPECIFICATIONS AND DETAIL, SHEET DT-3. IN ADDITION, THE PLAN AND PROFILE SHEETS INDICATE SPECIFIC ADDITIONAL LOCATIONS WHERE FUSIBLE PVC PIPE MUST BE USED IN LIEU OF BELL-AND-SPIGOT PIPE. IN THE ABSENCE OF ANY REQUIREMENT TO USE FUSIBLE PVC PIPE, CONTRACTOR HAS THE OPTION TO USE EITHER FUSIBLE OR BELL-AND-SPIGOT PIPE. IN THESE DRAWINGS, THE TERMS "BELL-AND-SPIGOT PIPE" AND "JOINTED PIPE" ARE USED SYNONYMOUSLY.
14. AT MOST LOCATIONS, THE PLAN AND PROFILE SHEETS SHOW HORIZONTAL BENDS WITHOUT SPECIFYING WHETHER THE HORIZONTAL BEND IS TO BE ACCOMPLISHED BY DI ELLS, FUSIBLE PVC SWEEPS, BENDING OF FUSIBLE PVC PIPE, OR JOINT DEFLECTION OF JOINTED PVC PIPE. AT SUCH LOCATIONS, THE METHOD OF BENDING IS AT CONTRACTOR'S OPTION, PROVIDED ALL DESIGN REQUIREMENTS SET FORTH IN THE DRAWINGS AND SPECIFICATIONS ARE MET. AT LOCATIONS WHERE FUSIBLE PVC SWEEPS ARE SHOWN, THEY MUST BE USED.
15. ALL PRESSURE RATINGS GIVEN HEREIN FOR PIPES, VALVES, FITTINGS AND OTHER COMPONENTS REFER TO COLD WATER WORKING PRESSURE RATING, UNLESS OTHERWISE NOTED.
16. VERTICAL CLEARANCES AT WATERLINE CROSSINGS ON PLAN AND PROFILE SHEETS CALLED OUT AS "MIN CLR TO CL" REFER TO MINIMUM CLEARANCE FROM BOTTOM OF EXISTING WATERLINE TO VERTICAL CENTERLINE OF PROPOSED WATERLINE. VERTICAL CLEARANCES FOR CASINGS CALLED OUT AS "MIN CLR TO CASING" REFER TO MINIMUM CLEARANCE FROM BOTTOM OF EXISTING PIPELINE OR FINISHED GRADE TO TOP OF PROPOSED CASING. VERTICAL CLEARANCES AT WASH CROSSINGS CALLED OUT AS "MIN TO CL" REFER TO MINIMUM PIPE DEPTH, MEASURED FROM BOTTOM OF WASH TO VERTICAL CENTERLINE OF PROPOSED WATERLINE.

17. REFER TO PROFESSIONAL REGISTRANTS IDENTIFIED ON INDIVIDUAL PLAN SHEETS AS THE RESPONSIBLE PARTY FOR THOSE DISCIPLINES. THE SEAL AND SIGNATURE OF THE PROFESSIONAL REGISTRANT IDENTIFIED ON THIS COVER SHEET DOES NOT INDICATE RESPONSIBLE CHARGE FOR ALL SHEETS CONTAINED WITHIN THIS PACKAGE OR ANY PLAN SHEETS NOT SIGNED AND SEALED.
18. ALL SCALES ARE BASED ON 11" x 17" SHEET SIZE.

CONTACT INFORMATION:

NAVAJO NATION WATER MANAGEMENT BRANCH (OWNER):

JASON JOHN (928) 729-4004

SOUDER, MILLER & ASSOCIATES (ENGINEER):

TORY TADANO, P.E (OFFICE) (505) 299-0942

NAVAJO TRIBAL UTILITY AUTHORITY (NTUA):









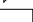

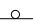









CROWNPOINT SUB-OFFICE (800) 528-5011 (ext. 4758)

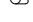ABBREVIATIONS








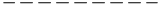


AASHTO	AMERICAN ASSOCIATION OF STATE HIGHWAY AND TRANSPORTATION OFFICIALS
A.C.	ASPHALTIC CONCRETE
ACI	AMERICAN CONCRETE INSTITUTE
AC.	ACRE
AC-FT.	ACRE FEET
AISC	AMERICAN INSTITUTE OF STEEL CONSTRUCTION
ALIGN.	ALIGNMENT
ALUM	ALUMINUM
AMSL	ABOVE MEAN SEA LEVEL
ANSI	AMERICAN NATIONAL STANDARDS INSTITUTE
APPROX.	APPROXIMATE
ARV	AIR RELEASE VALVE
ASTM	AMERICAN SOCIETY FOR TESTING AND MATERIALS
AWG	AMERICAN WIRE GAUGE
AWWA	AMERICAN WATER WORKS ASSOCIATION
BFV	BUTTERFLY VALVE
BIA	BUREAU OF INDIAN AFFAIRS
BLDG	BUILDING
BLM	BUREAU OF LAND MANAGEMENT
BV	BALL VALVE
BVCE	BEGIN VERTICAL CURVE ELEVATION
BVCS	BEGIN VERTICAL CURVE STATION
CL	CENTERLINE
CFS	CUBIC FEET PER SECOND
CI	CAST IRON
CLR.	CLEARANCE
CMP	CORRUGATED METAL PIPE
COMM.	COMMUNICATION
CONC.	CONCRETE
CONST.	CONSTRUCTION
CONT.	CONTINUOUS
CONT.	CONTINUED
COR.	CORNER
COUP.	COUPLING
CP	CONTROL POINT
CTR	CENTER
CU	CUBIC
CY	CUBIC YARD
DI	DUCTILE IRON
DIA	DIAMETER
DIMS	DIMENSIONS
DR	DIMENSION RATIO
DW	DRIVEWAY
E	EAST
E	EASTING
EA.	EACH
ED.	EDITION
EG	EXISTING GRADE
ELEC.	ELECTRICAL
EL., ELEV.	ELEVATION
EOP	EDGE OF PAVEMENT
EQ.	EQUAL
ESMT.	EASEMENT
EVCE	END VERTICAL CURVE ELEVATION
EVCS	END VERTICAL CURVE STATION
EX. EXIST.	EXISTING
FBE	FUSION BONDED EPOXY
FF	FINISHED FLOOR
FFE	FINISHED FLOOR ELEVATION
FG	FINISHED GRADE
FIG.	FIGURE
FL	FLANGE
FND.	FOUND
FNPT	FEMALE NATIONAL PIPE THREAD
FRP	FIBER REINFORCED PLASTIC
FT.	FEET
FV	FLUSH VALVE
GA.	GAUGE
GALV.	GALVANIZED
GI	GALVANIZED IRON
GPM	GALLONS PER MINUTE
GV	GATE VALVE
HDD	HORIZONTAL DIRECTIONAL DRILLING
HDPE	HIGH DENSITY POLYETHYLENE
HORIZ.	HORIZONTAL
HP	HORSE POWER
HT	HEIGHT
HWY	HIGHWAY
IA.	INDIAN ALLOTMENT
ID.	INNER DIAMETER
IE.	THAT IS, FOR EXAMPLE
IN.	INCH
INV	INVERT
IPS	IRON PIPE SIZE
KSI	KILO POUNDS PER SQUARE INCH
LAT	LATITUDE
L, LEN	LENGTH

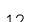LF	LINEAR FEET
LT	LEFT
LONG	LONGITUDE
LVC	LENGTH VERTICAL CURVE
MANUF	MANUFACTURER
MAX.	MAXIMUM
MIL	ONE THOUSANDTHS OF AN INCH
MIN.	MINIMUM
M.J.	MECHANICAL JOINT
MNPT	MALE NATIONAL PIPE THREAD
M.S.L.	MEAN SEA LEVEL
N	NORTH
N	NORTHING
N.C.	NATIONAL ELECTRICAL CODE
NEC	NORMALLY CLOSED
NG	NATURAL GAS
NGWSP	NAVAJO GALLUP WATER SUPPLY PROJECT
NM	NEW MEXICO
NMDOT	NEW MEXICO DEPARTMENT OF TRANSPORTATION
NMED	NEW MEXICO ENVIRONMENT DEPARTMENT
NN	NAVAJO NATION
NO.	NUMBER
N.O.	NORMALLY OPEN
NPT	NATIONAL PIPE THREAD
NTS	NOT TO SCALE
OAE	OR APPROVED EQUAL
O.C.	ON CENTER
O.C.E.W.	ON CENTER EACH WAY
O.D.	OUTER DIAMETER
OHE	OVERHEAD ELECTRICAL
PE	PLAIN END
P.G.P.	PER GRADING PLAN
PI	POINT OF INFLECTION
PROP	PROPOSED
PRV	PRESSURE REDUCING VALVE
PSF	POUNDS PER SQUARE FOOT
PSI	POUNDS PER SQUARE INCH
PVC	POLY VINYL CHLORIDE
PVI	POINT VERTICAL INFLECTION
PVT	PRIVATE
Q	FLOW
QTY.	QUANTITY
R	RADIUS
R-	RANGE
REF	REFERENCE
RO	ROUGH OPENING
ROW	RIGHT OF WAY
RT	RIGHT
S	SOUTH
SCH	SCHEDULE
SCO	SANDOVAL COUNTY
SDR	STANDARD DIMENSION RATIO
SEC.	SECTION
SF	SAFETY FACTOR
SHT	SHEET
SPECS.	SPECIFICATIONS
SS	STAINLESS STEEL
STA	STATION
STD.	STANDARD
SW	SIDEWALK
T	TOWNSHIP
TBD	TO BE DETERMINED
TBR	TO BE REMOVED
TCE	TEMPORARY CONSTRUCTION EASEMENT
TDH	TOTAL DYNAMIC HEAD
TELE.	TELEPHONE
TEMP.	TEMPORARY
THK	THICK
TNT	NAVAJO TRIBAL TRUST
T.O.	TOP OF
TRANS	TRANSFORMER
TW	TOP OF WALL
TYP	TYPICAL
UGE	UNDERGROUND ELECTRIC
USGS	UNITED STATES GEOLOGICAL SURVEY
V	VOLUME
V.	VACUUM BREAKER
VERT.	VERTICAL
VLV	VALVE
VR	VACUUM RELIEF
W	WATER
W	WEST
W/	WITH
WL	WATERLINE
WP	WORKING PRESSURE
WT	WALL THICKNESS
WV	WATER VALVE
YDS	YARDS
Z	ZENITH

LEGEND

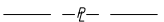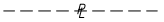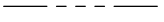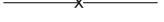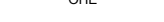



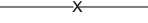











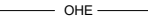




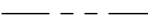


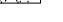


	EXISTING BUTTERFLY VALVE
	GATE VALVE
	WATER METER
	HYDRANT
	POWER POLE
	GUY ANCHOR
	ELECTRICAL J-BOX
	TELEPHONE PEDESTAL
	STORM DRAIN INLET / OUTLET
	BUILDING
	CATTLE GUARD
	ROAD SIGN
	EXISTING DRAINAGE WASH
	GUARD RAIL
	ROAD EDGE
	ROAD CENTER
	CONTOUR MAJOR
	CONTOUR MINOR
	SECTION CORNER
	CULTURALLY / BIOLOGICALLY SENSITIVE AREA DO NOT ENCROACH
12	SECTION NUMBER

Tribal Trust/I.A./BLM CURRENT LAND STATUS (OWNER)

	SECTION LINE
	QUARTER SECTION LINE
	TOWNSHIP / RANGE LINE
	FENCE
	OVERHEAD POWER LINE
	UNDERGROUND POWER LINE
	OVERHEAD TELEPHONE LINE
	UNDERGROUND TELEPHONE LINE
	WATER LINE
	GAS LINE

LEGEND

PROPOSED

	WATER LINE		CONTOUR MAJOR
	POWER LINE		CONTOUR MINOR
	FENCE		40' WATERLINE EASEMENT
	CABLE BARRIER		TEMPORARY CONSTRUCTION EASEMENT
	PIPE CASING		ACCESS DRIVE / ROAD
	GATE VALVE		RIP RAP OR CABLE CRETE
	BALL VALVE		GRAVEL OVER BASE COURSE
	VACUUM BREAKER		BERM
	AIR RELEASE VALVE COMBO		DRAIN PIPE
	FLUSH VALVE		SWALE
	POWER POLE		DIRECTION OF FLOW
	GUY ANCHOR		MATCH LINE
	STORM DRAIN INLET / OUTLET		
	DOUBLE SWING GATE		
	BOULDER		

CLIENT: The Navajo Nation

TOWN: Reach 26.3 To Tontoon, NM

DESIGNED
TTT

DRAWN
MVA/AG

CHECKED
AGR

90% REVIEW
DRAFT

PRELIMINARY
NOT FOR CONSTRUCTION

THIS DRAWING IS INCOMPLETE
AND NOT TO BE USED FOR
CONSTRUCTION UNLESS IT IS
STAMPED, SIGNED AND DATED

NOTICE OF EXTENDED
PAYMENT PROVISION:
THIS CONTRACT ALLOWS THE
OWNER TO MAKE PAYMENT
WITHIN 45 DAYS AFTER
SUBMISSION OF
AN UNDISPUTED REQUEST
FOR PAYMENT.

811 Know what's
below.
Call before
you dig.

Date: September 27, 2018

Scale: Horiz:
Vert:

Project No: 6921307


Sheet: G-2

SOUDER, MILLER & ASSOCIATES
5454 VENCE AVENUE NE, SUITE D
ALBUQUERQUE, NM 87113
Phone (505) 299-0942 Toll-Free (877) 299-0942 Fax (505) 293-3430
www.soudermiller.com
Serving the Southwest & Rocky Mountains
Albuquerque, Carlsbad, Hobbs, Farmington, Las Cruces, Roswell, Santa Fe, NM
Cortez, Grand Junction, CO - Safford, AZ - Moab, UT - El Paso, TX
(505) 299-0942

By: [Signature]
Description: [Blank]
Date: [Blank]

Revision: [Blank]

Printed Reach 26.3 Cover-Gen Notes.dwg
9/27/2018 4:47:28PM awr

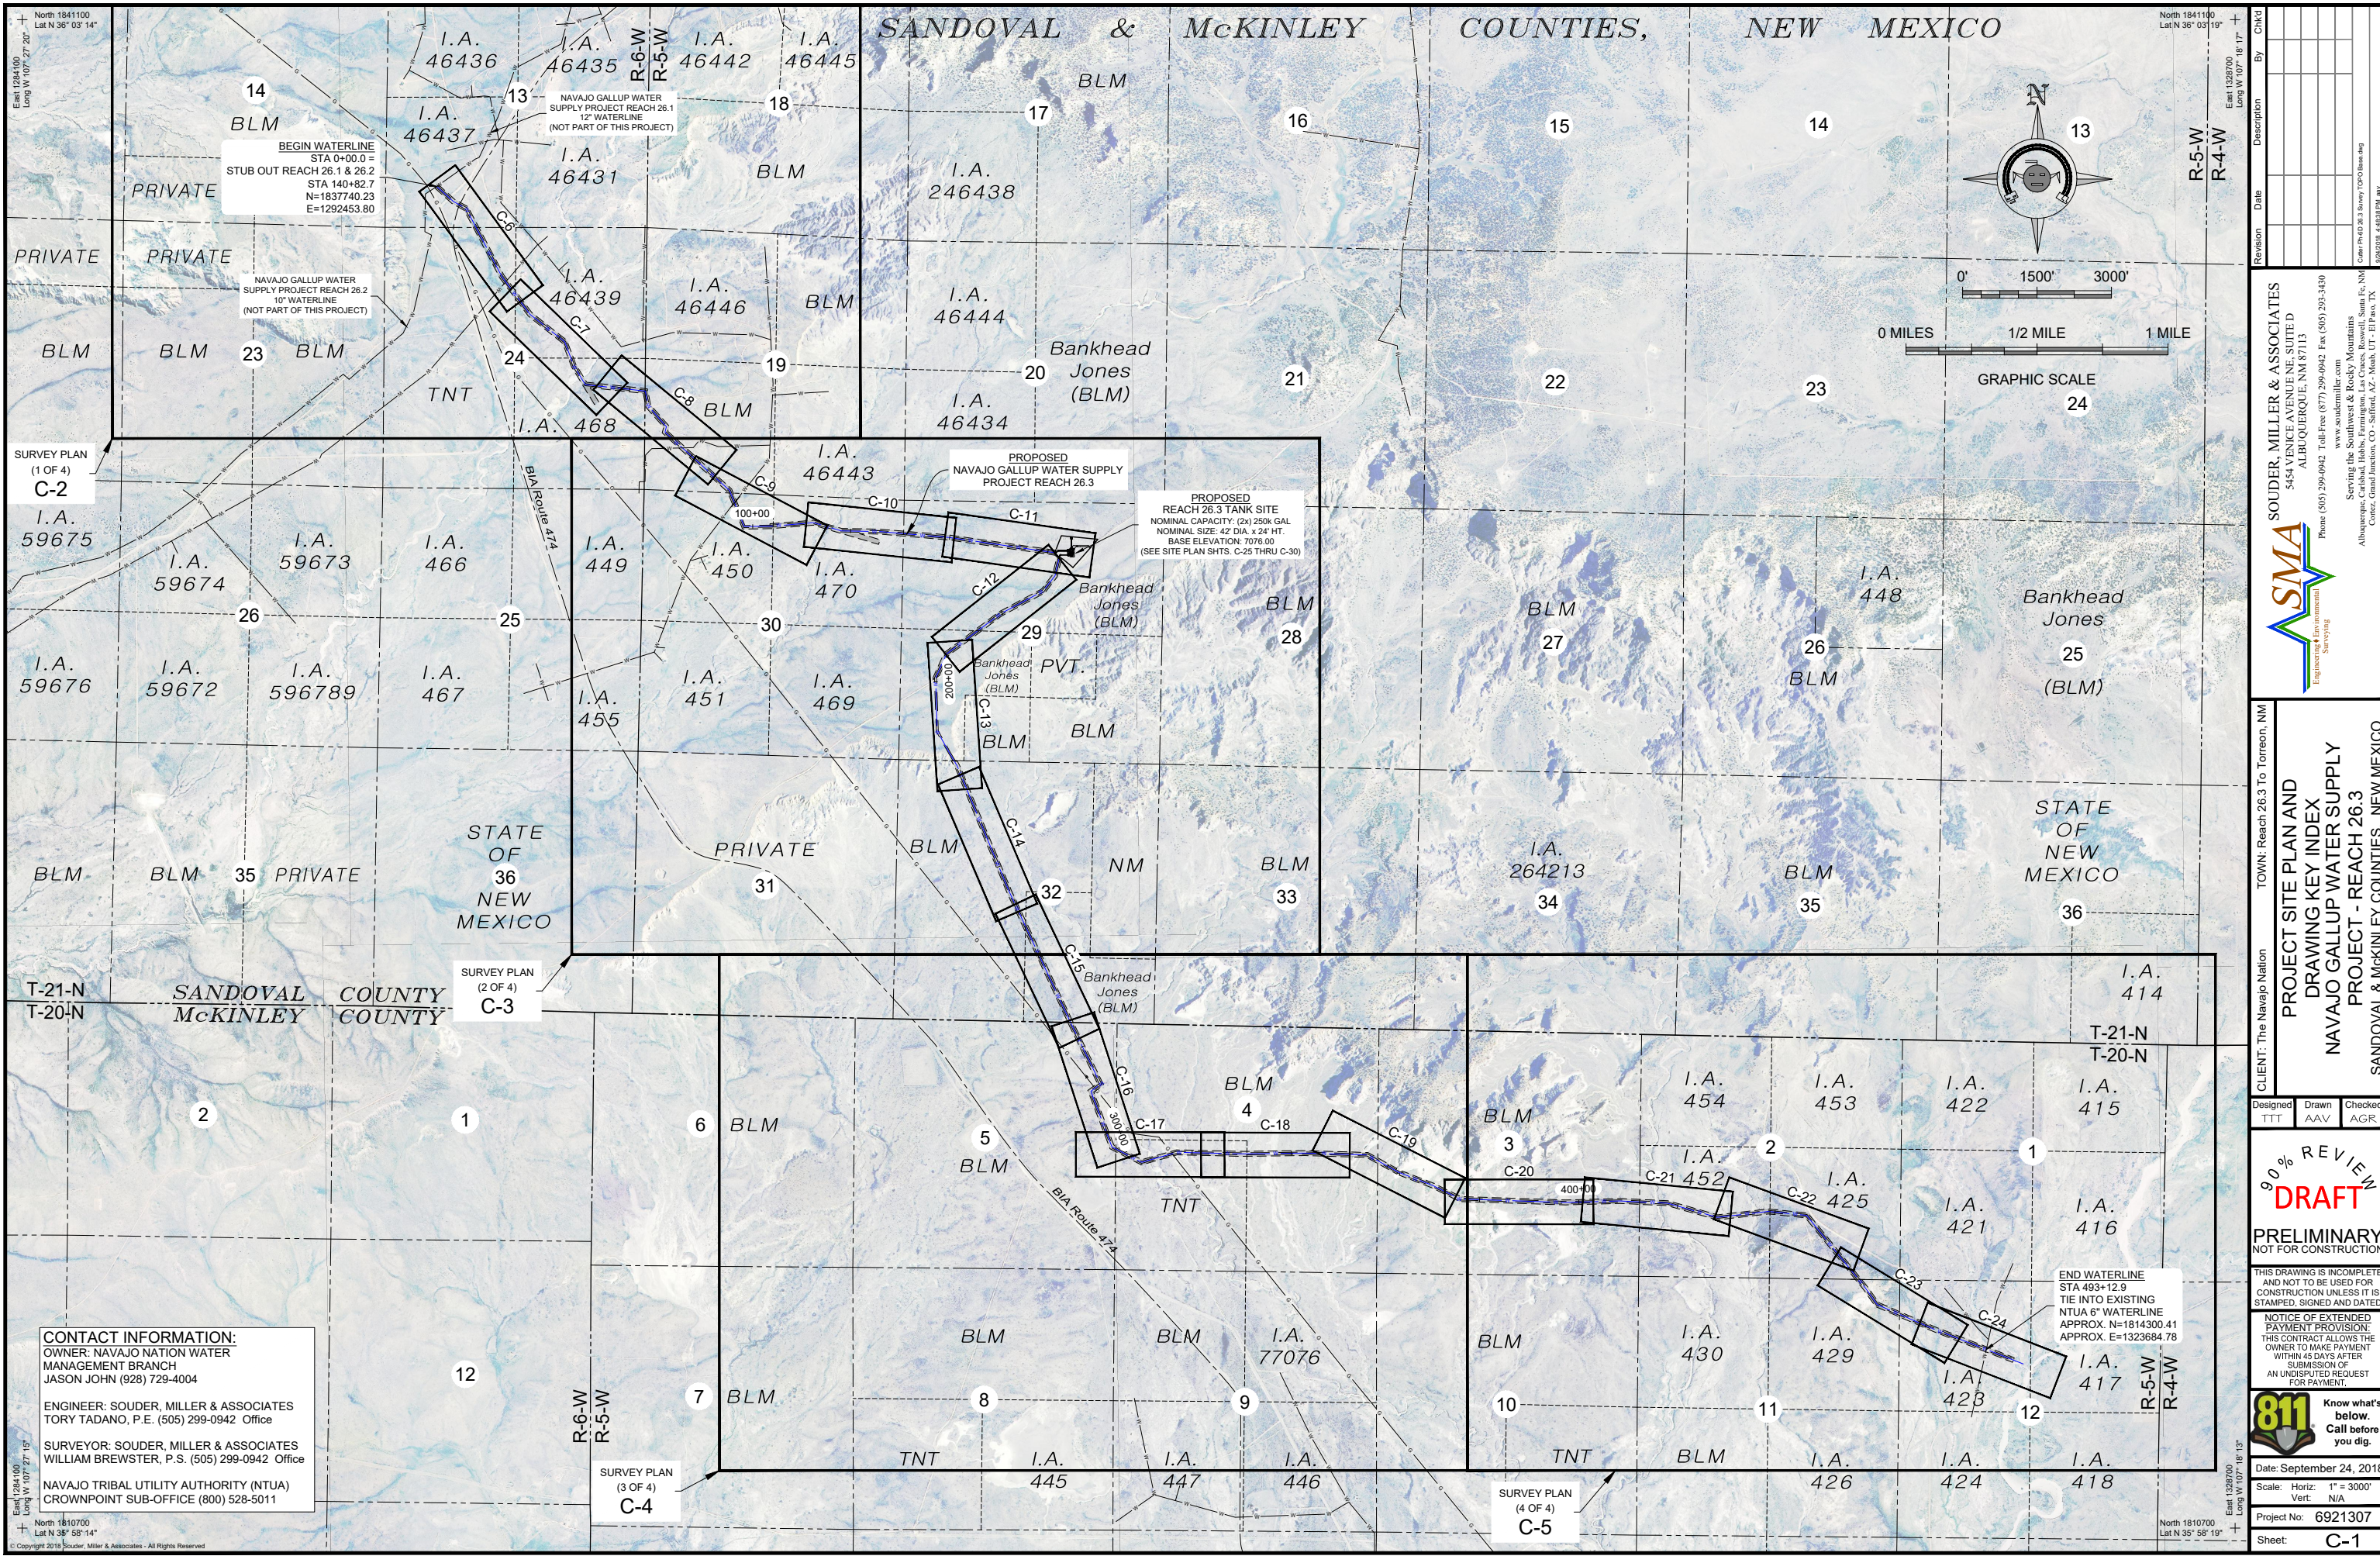

BEGIN WATERLINE
STA 0+00.0 =
STUB OUT REACH 26.1 & 26.2
STA 140+82.7
N=1837740.23
E=1292453.80

NAVAJO GALLUP WATER
SUPPLY PROJECT REACH 26.2
10" WATERLINE
(NOT PART OF THIS PROJECT)

NAVAJO GALLUP WATER
SUPPLY PROJECT REACH 26.1
12" WATERLINE
(NOT PART OF THIS PROJECT)

PROPOSED
NAVAJO GALLUP WATER SUPPLY
PROJECT REACH 26.3

PROPOSED
REACH 26.3 TANK SITE
NOMINAL CAPACITY: (2x) 250k GAL
NOMINAL SIZE: 42" DIA. x 24' HT.
BASE ELEVATION: 7076.00
(SEE SITE PLAN SHTS. C-25 THRU C-30)


END WATERLINE
STA 493+12.9
TIE INTO EXISTING
NTUA 6" WATERLINE
APPROX. N=1814300.41
APPROX. E=1323684.78

CONTACT INFORMATION:
OWNER: NAVAJO NATION WATER
MANAGEMENT BRANCH
JASON JOHN (928) 729-4004

ENGINEER: SOUDER, MILLER & ASSOCIATES
TORY TADANO, P.E. (505) 299-0942 Office

SURVEYOR: SOUDER, MILLER & ASSOCIATES
WILLIAM BREWSTER, P.S. (505) 299-0942 Office

NAVAJO TRIBAL UTILITY AUTHORITY (NTUA)
CROWNPOINT SUB-OFFICE (800) 528-5011

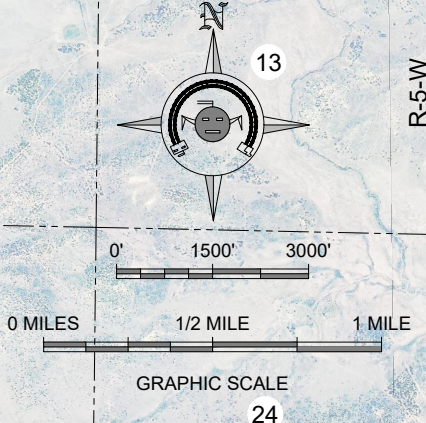

Revision	Date	Description

SOUDER, MILLER & ASSOCIATES
5454 VINCE AVENUE, SUITE D
ALBUQUERQUE, NM 87113
Phone (505) 299-0942 Toll-Free (877) 299-0942 Fax (505) 293-3430
www.soudermiller.com
Serving the Southwest & Rocky Mountains
Albuquerque, Carlsbad, Hobbs, Farmington, Las Cruces, Roswell, Santa Fe, NM
Cortez, Grand Junction, CO - Safford, AZ - Moab, UT - El Paso, TX

CLIENT: The Navajo Nation
TOWN: Reach 26.3 To Tropic, NM
**PROJECT SITE PLAN AND
DRAWING KEY INDEX**
**NAVAJO GALLUP WATER SUPPLY
PROJECT - REACH 26.3**
SANDOVAL & MCKINLEY COUNTIES, NEW MEXICO

Designed TTT	Drawn AAV	Checked AGR
-----------------	--------------	----------------

90% REVIEW
DRAFT


PRELIMINARY
NOT FOR CONSTRUCTION


THIS DRAWING IS INCOMPLETE
AND NOT TO BE USED FOR
CONSTRUCTION UNLESS IT IS
STAMPED, SIGNED AND DATED


**NOTICE OF EXTENDED
PAYMENT PROVISION:**
THIS CONTRACT ALLOWS THE
OWNER TO MAKE PAYMENT
WITHIN 45 DAYS AFTER
SUBMISSION OF
AN UNDISPUTED REQUEST
FOR PAYMENT.


811 Know what's
below.
Call before
you dig.

Date: September 24, 2018
Scale: Horiz: 1" = 3000'
Vert: N/A
Project No: 6921307
Sheet: C-1

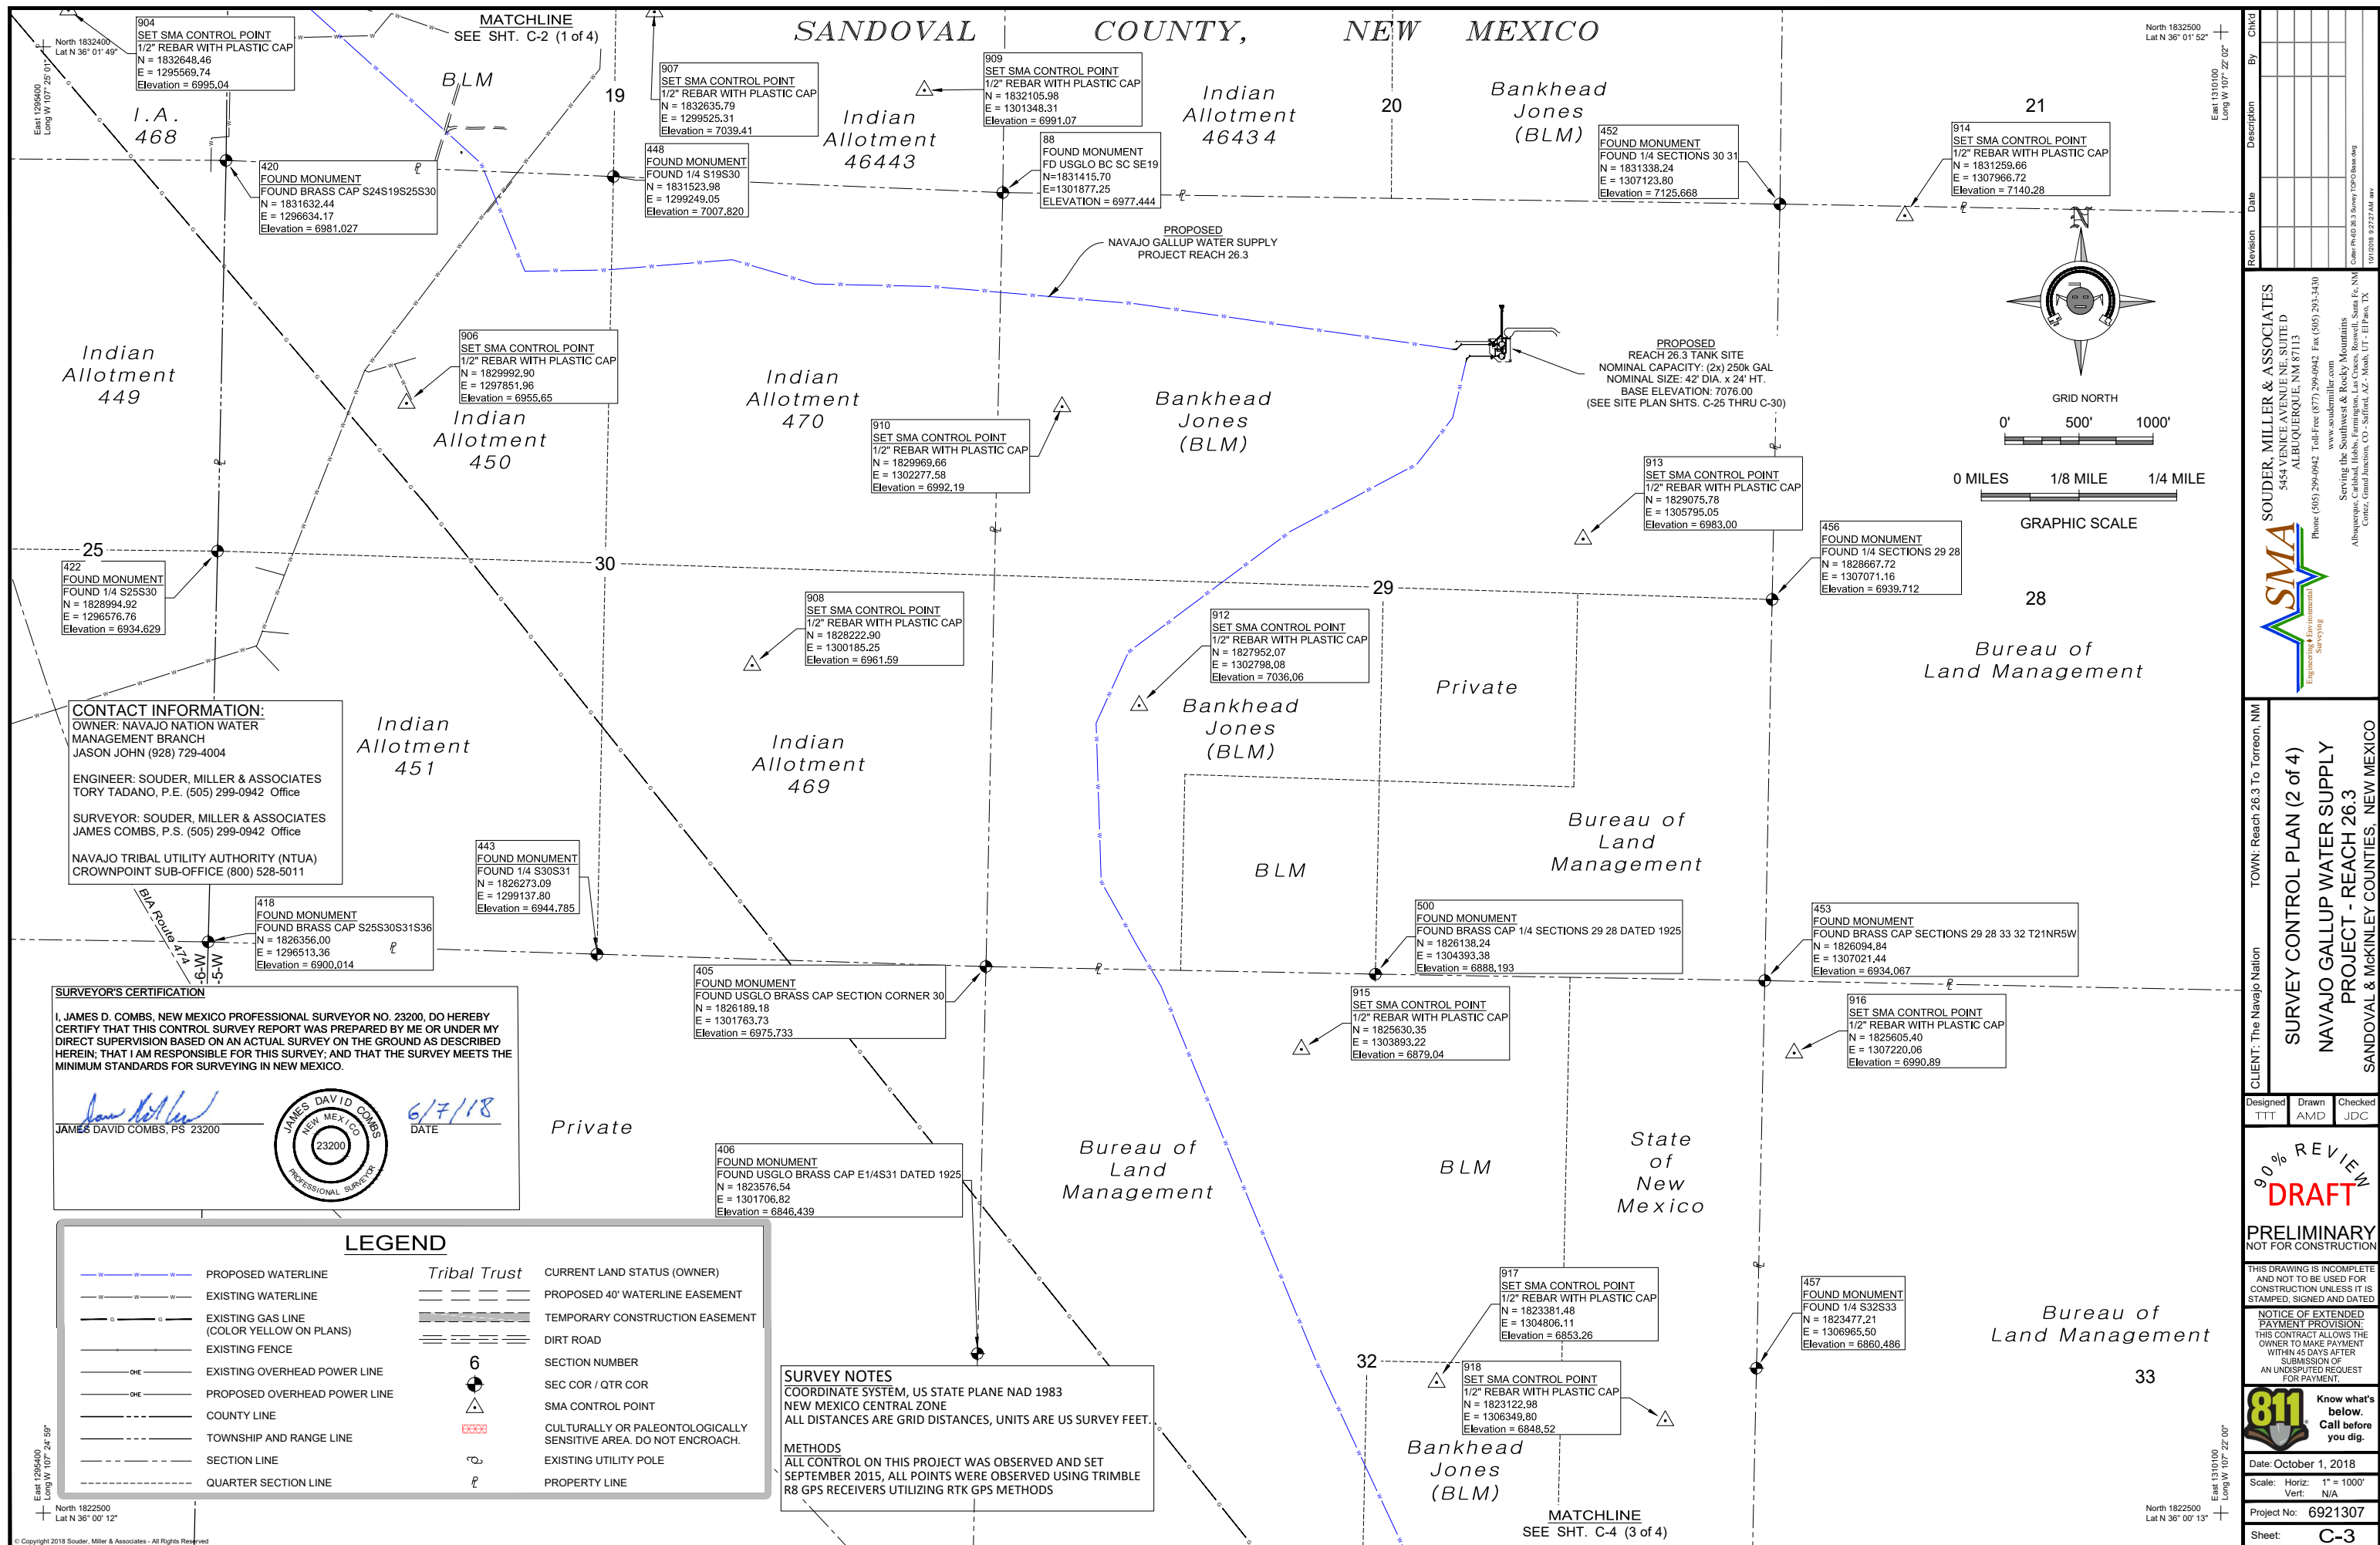


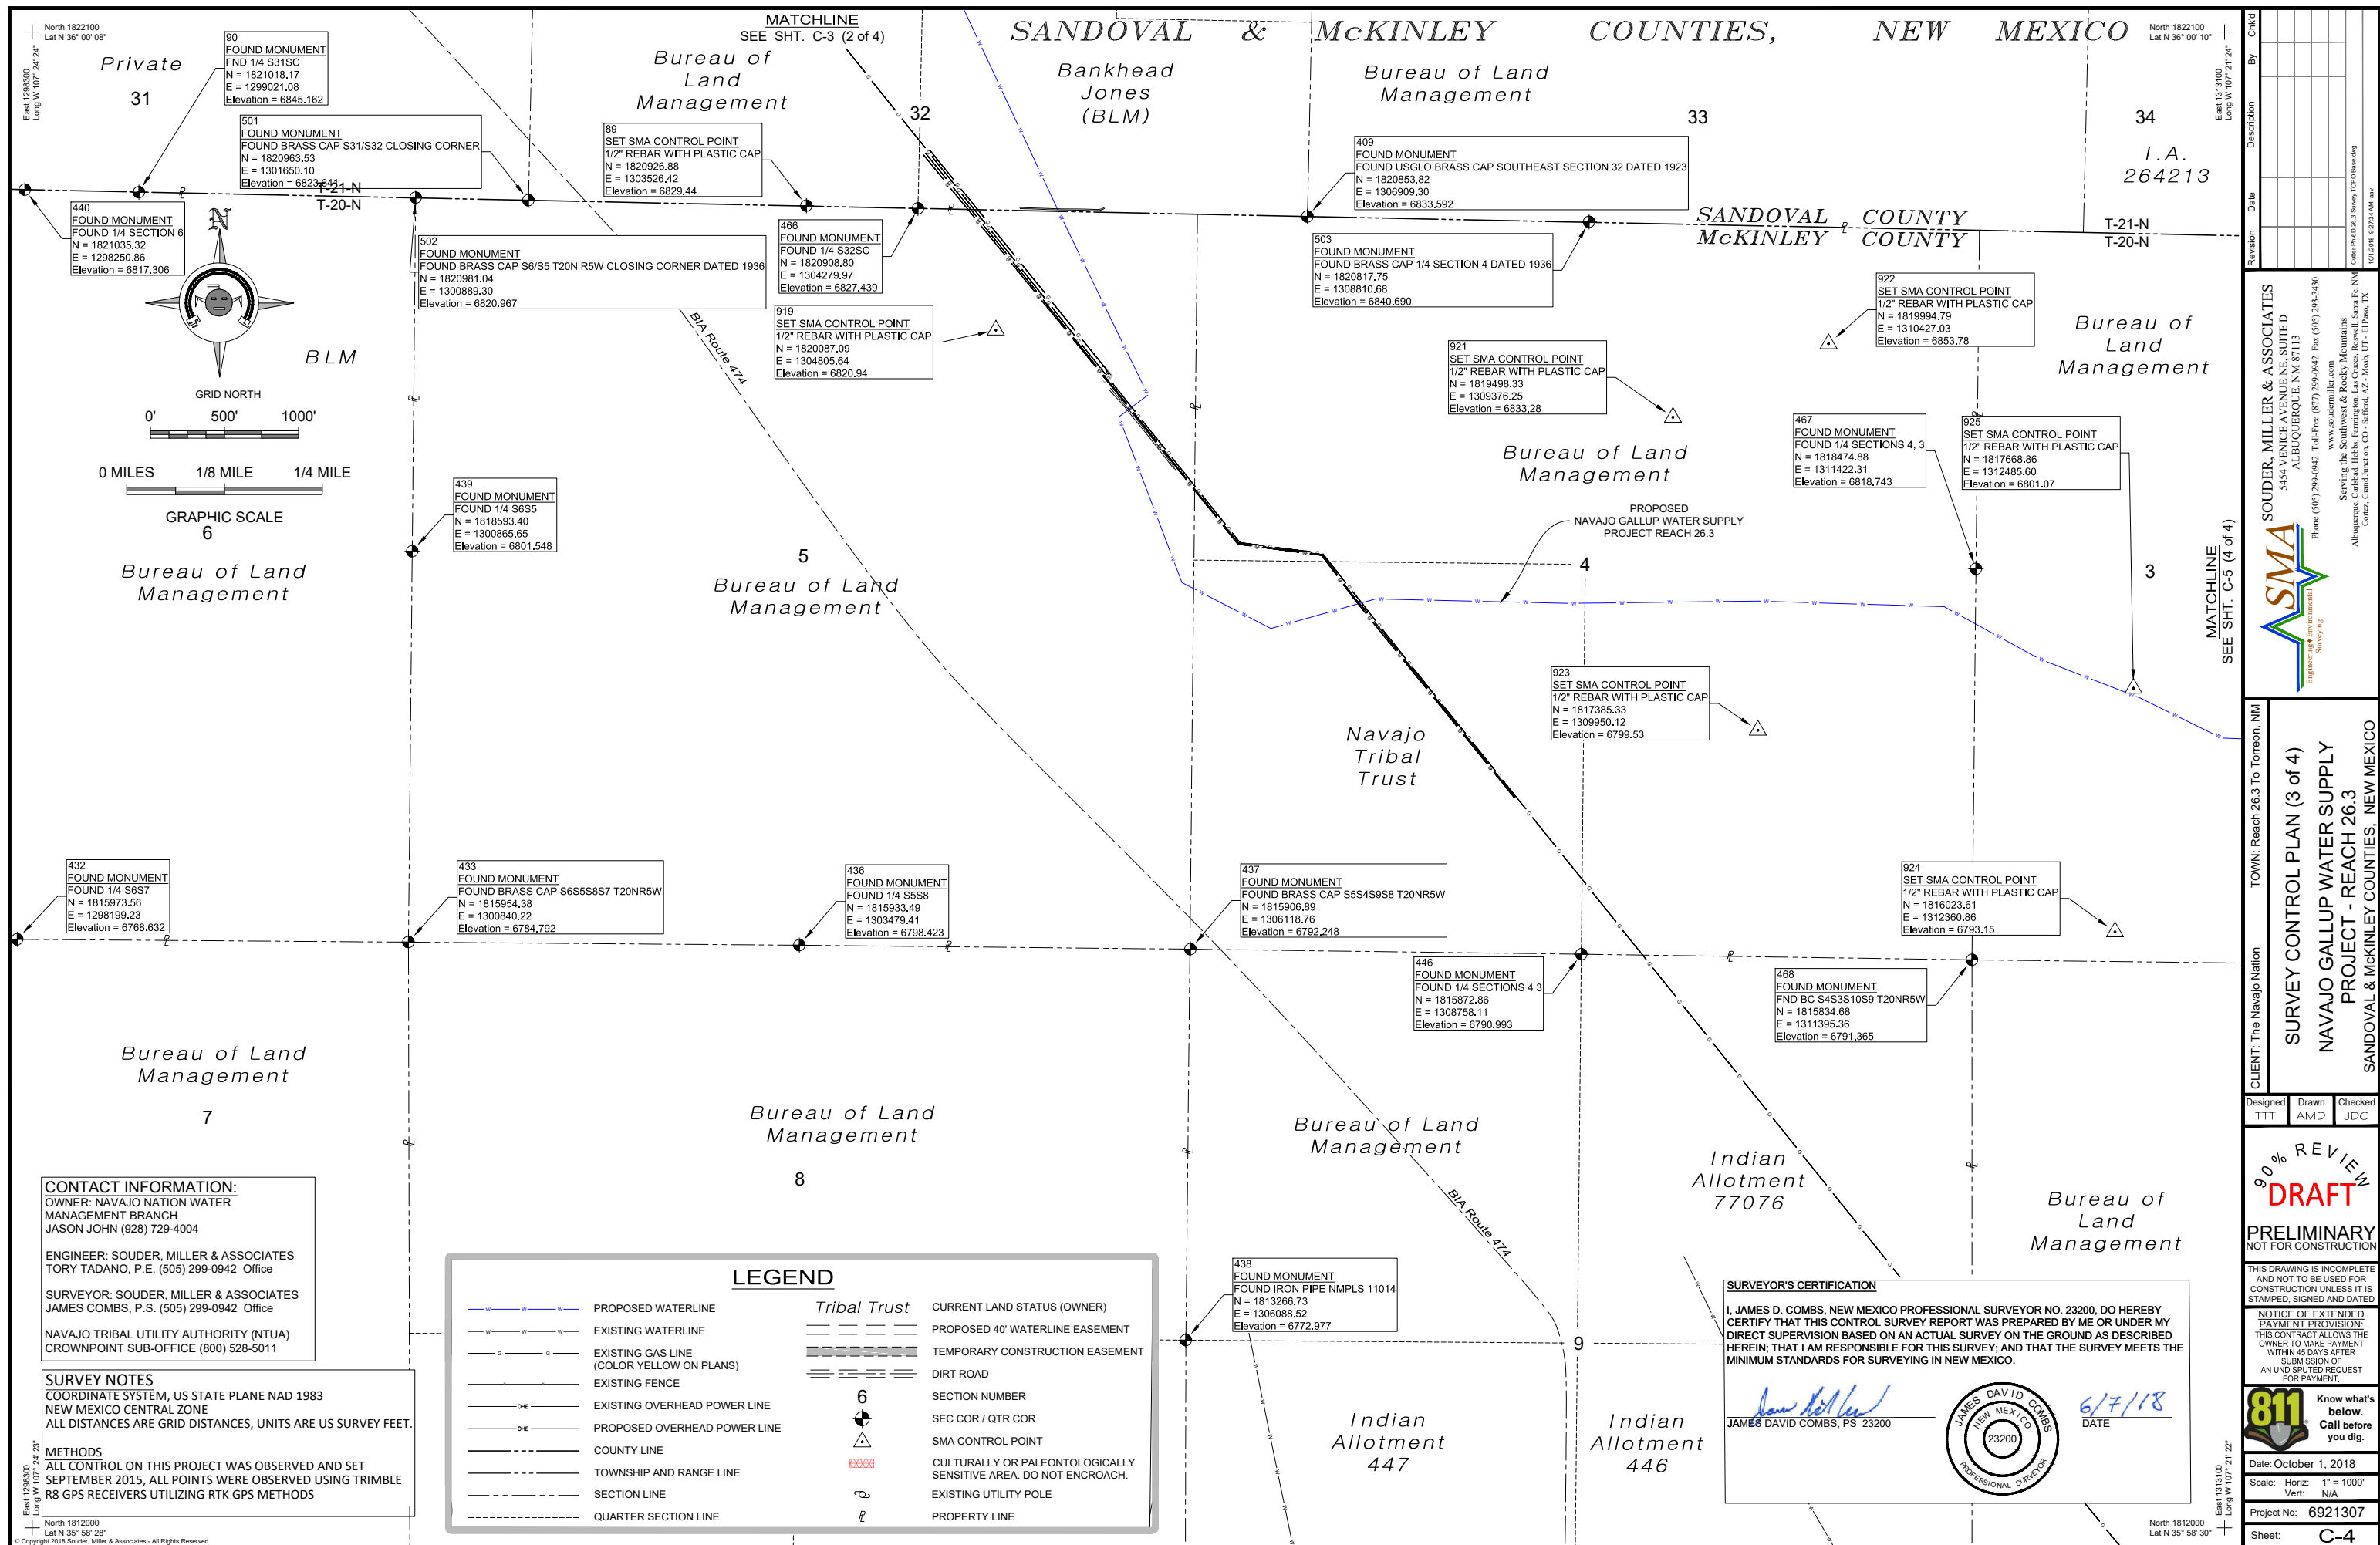

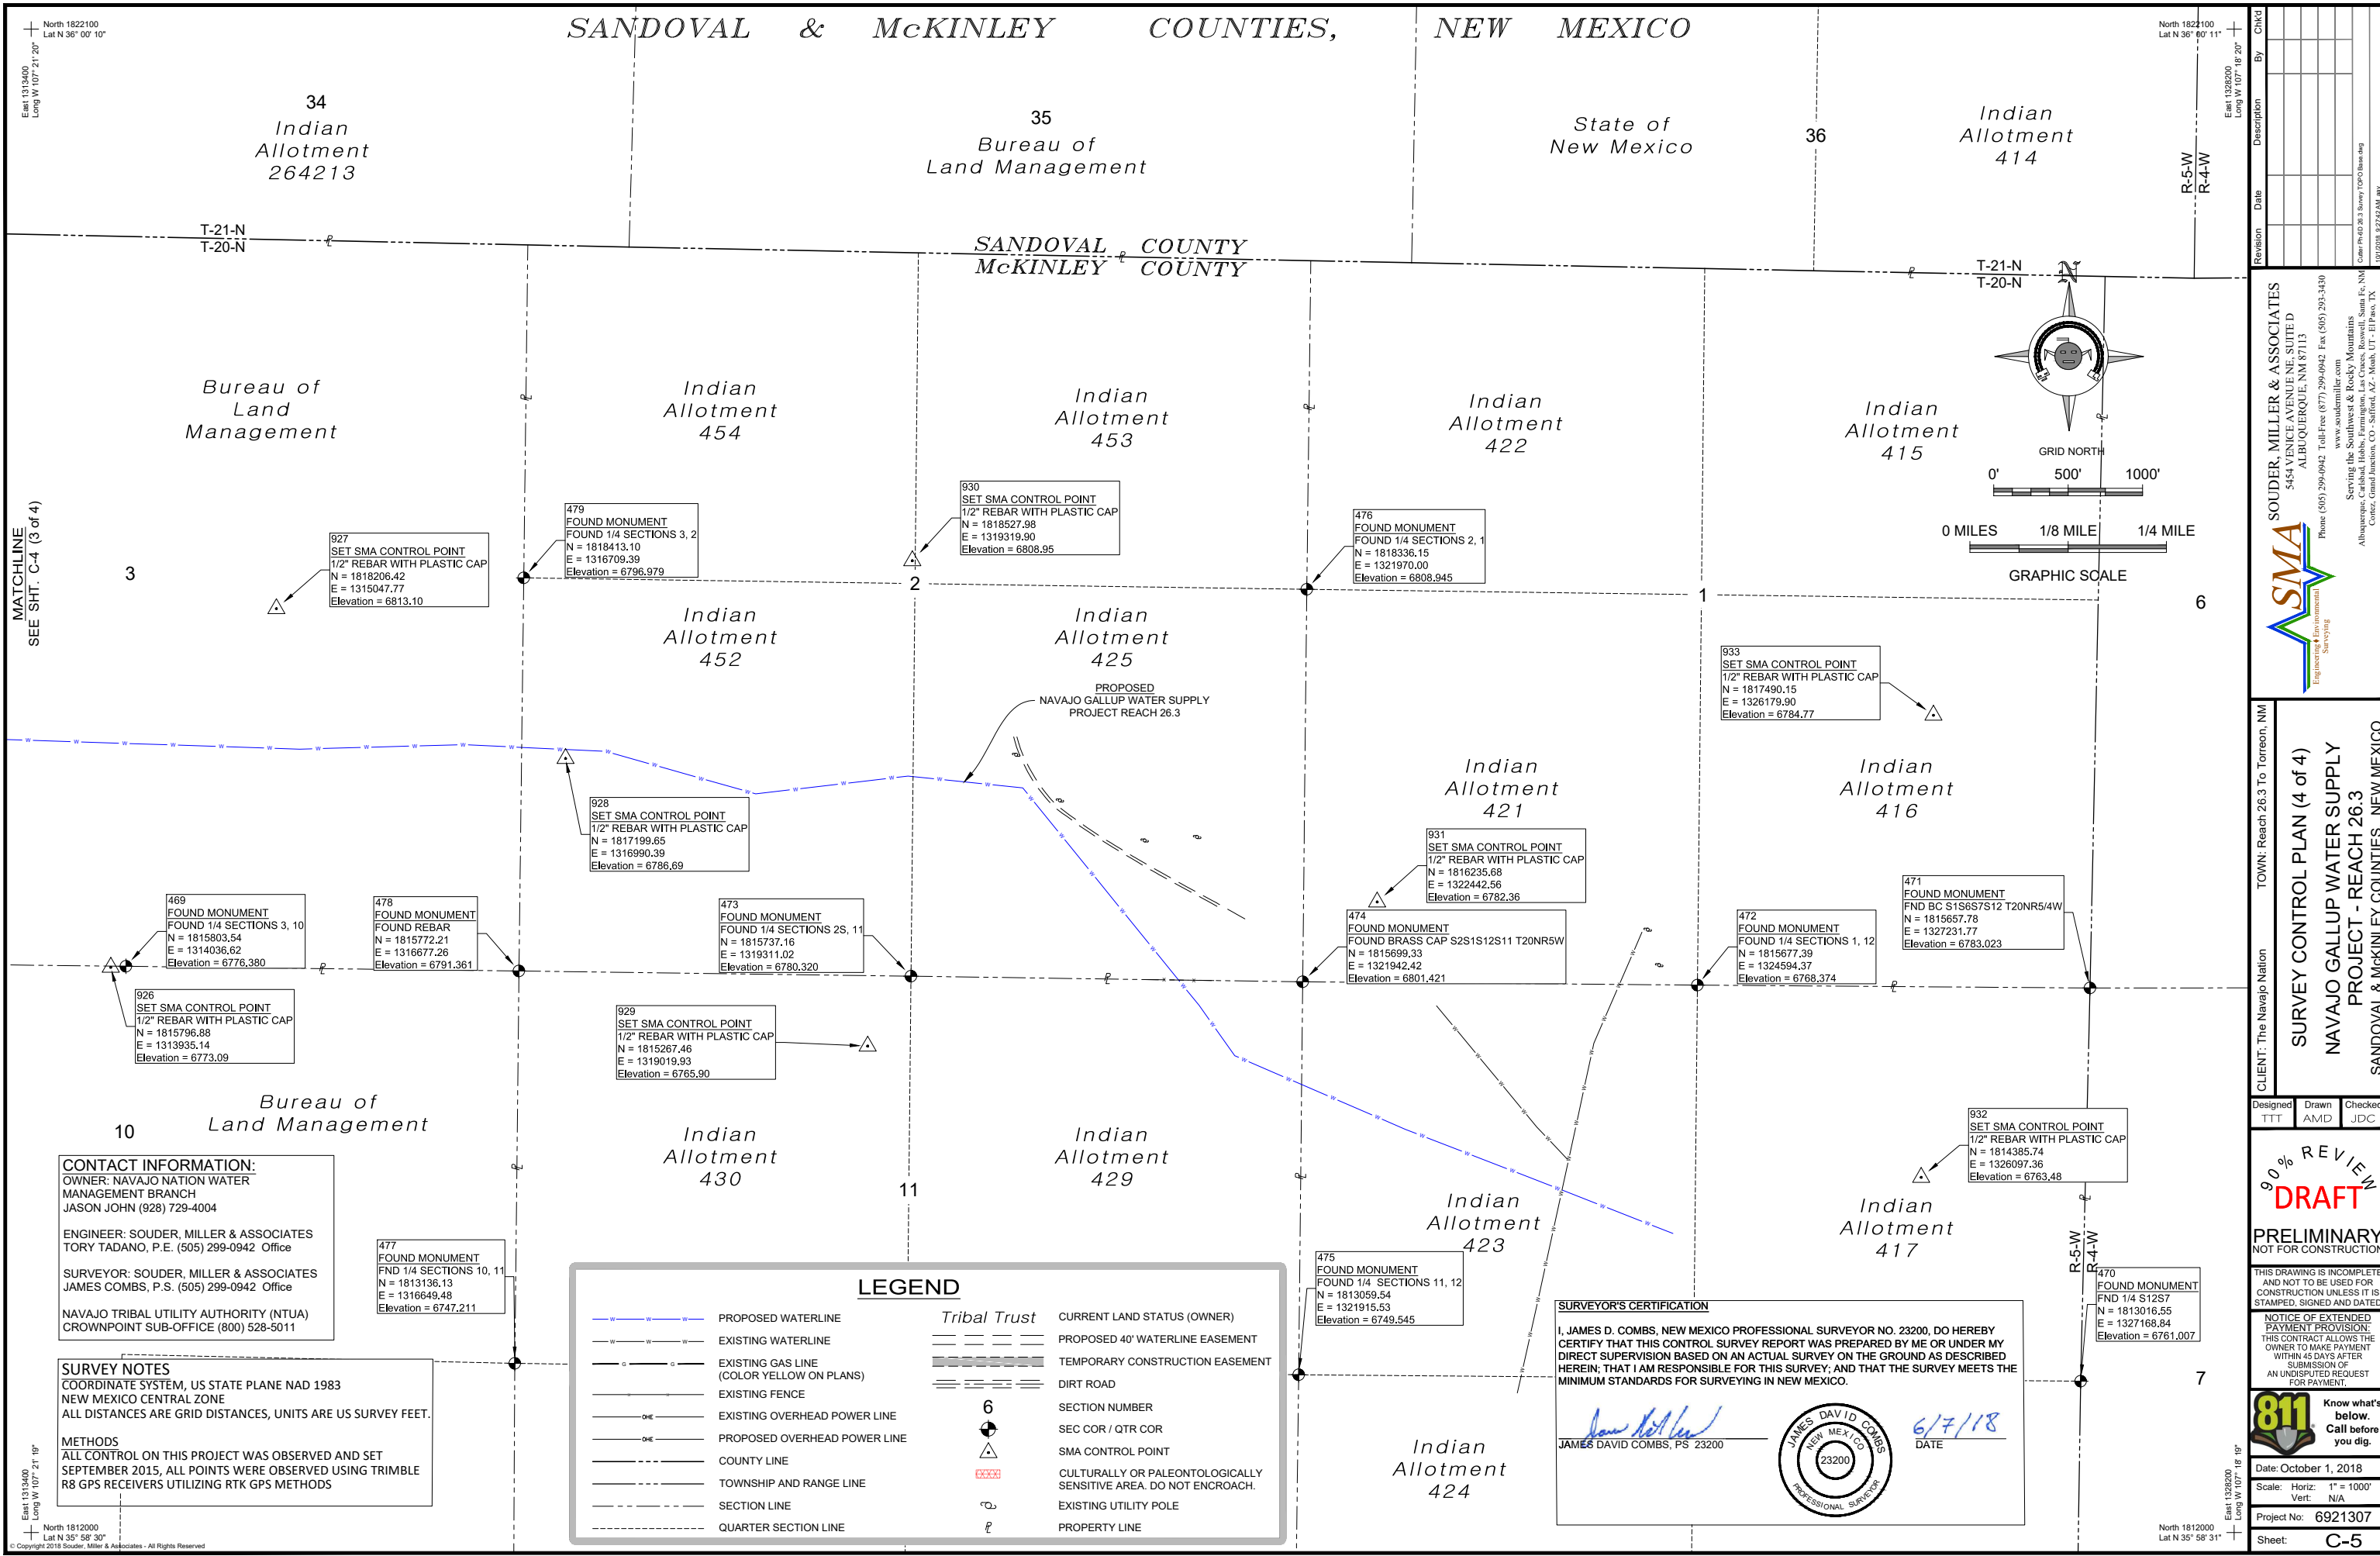

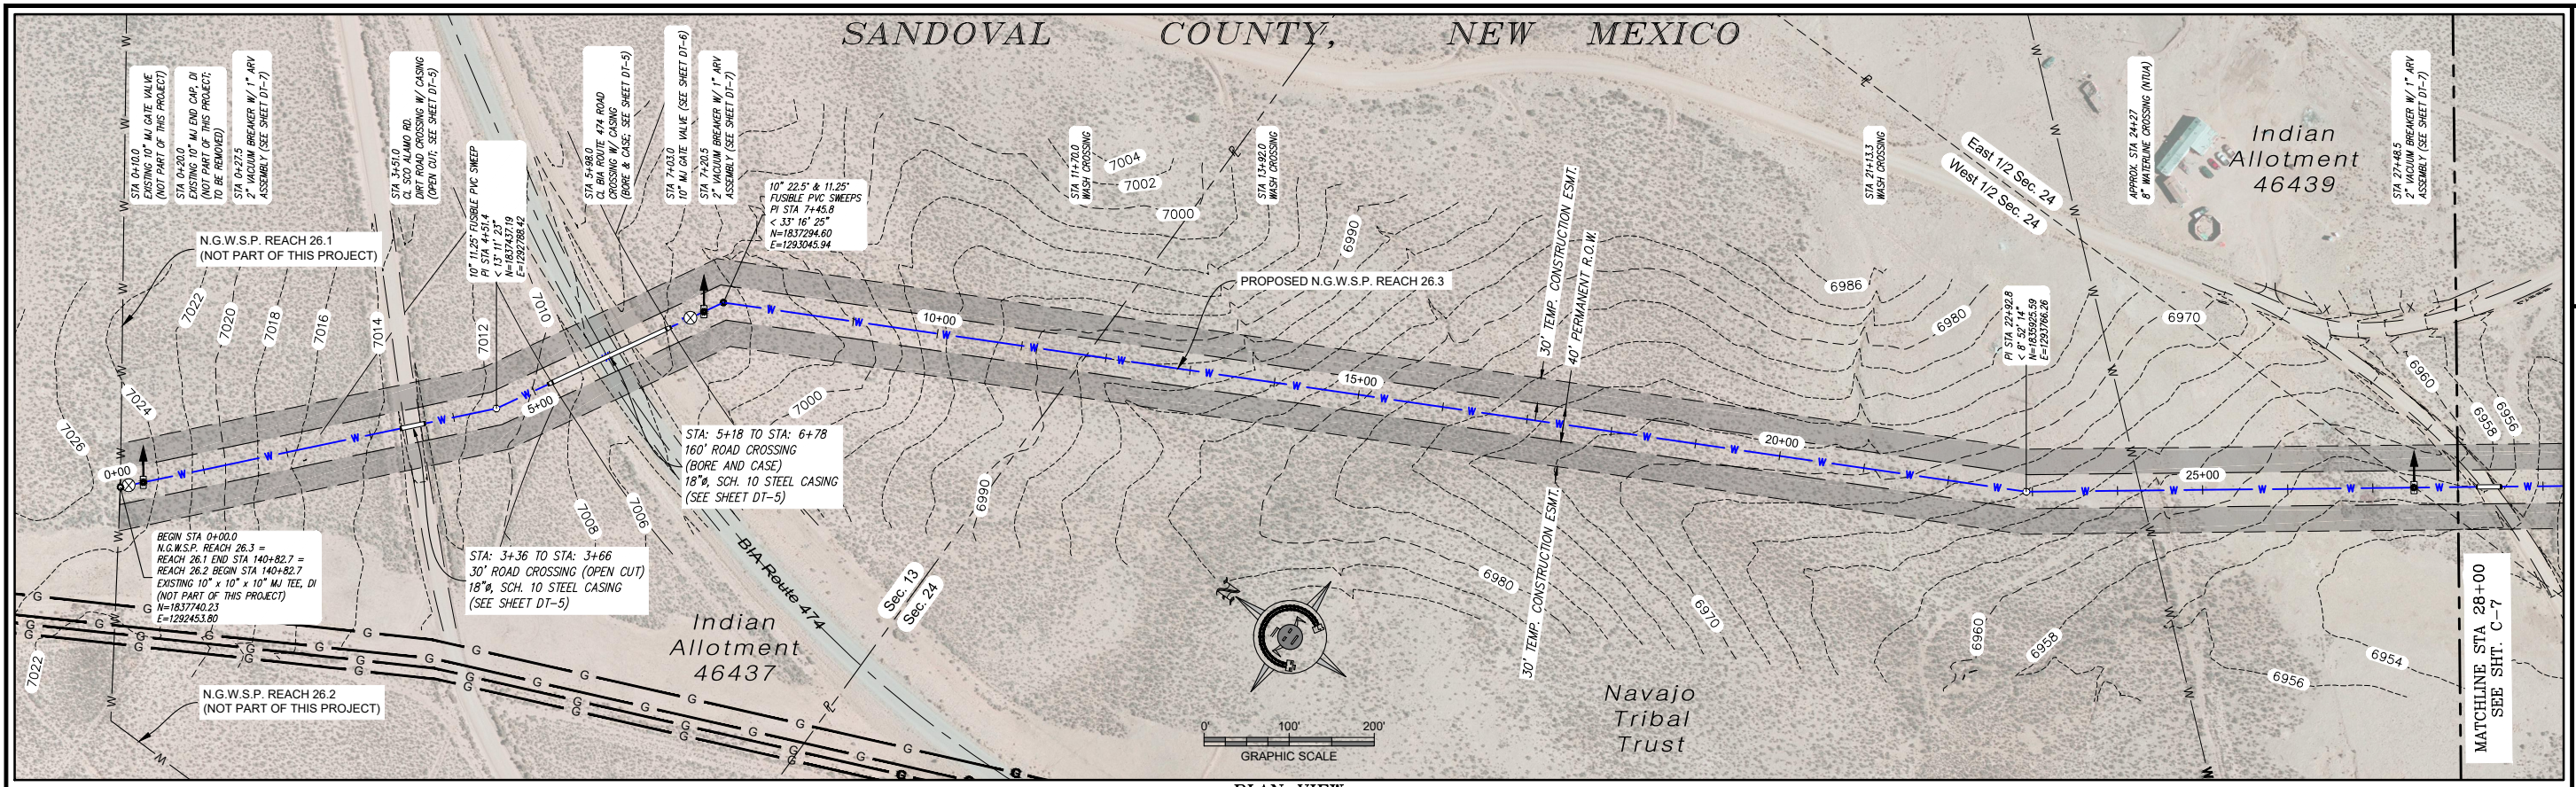

PLAN VIEW
10" WATERLINE

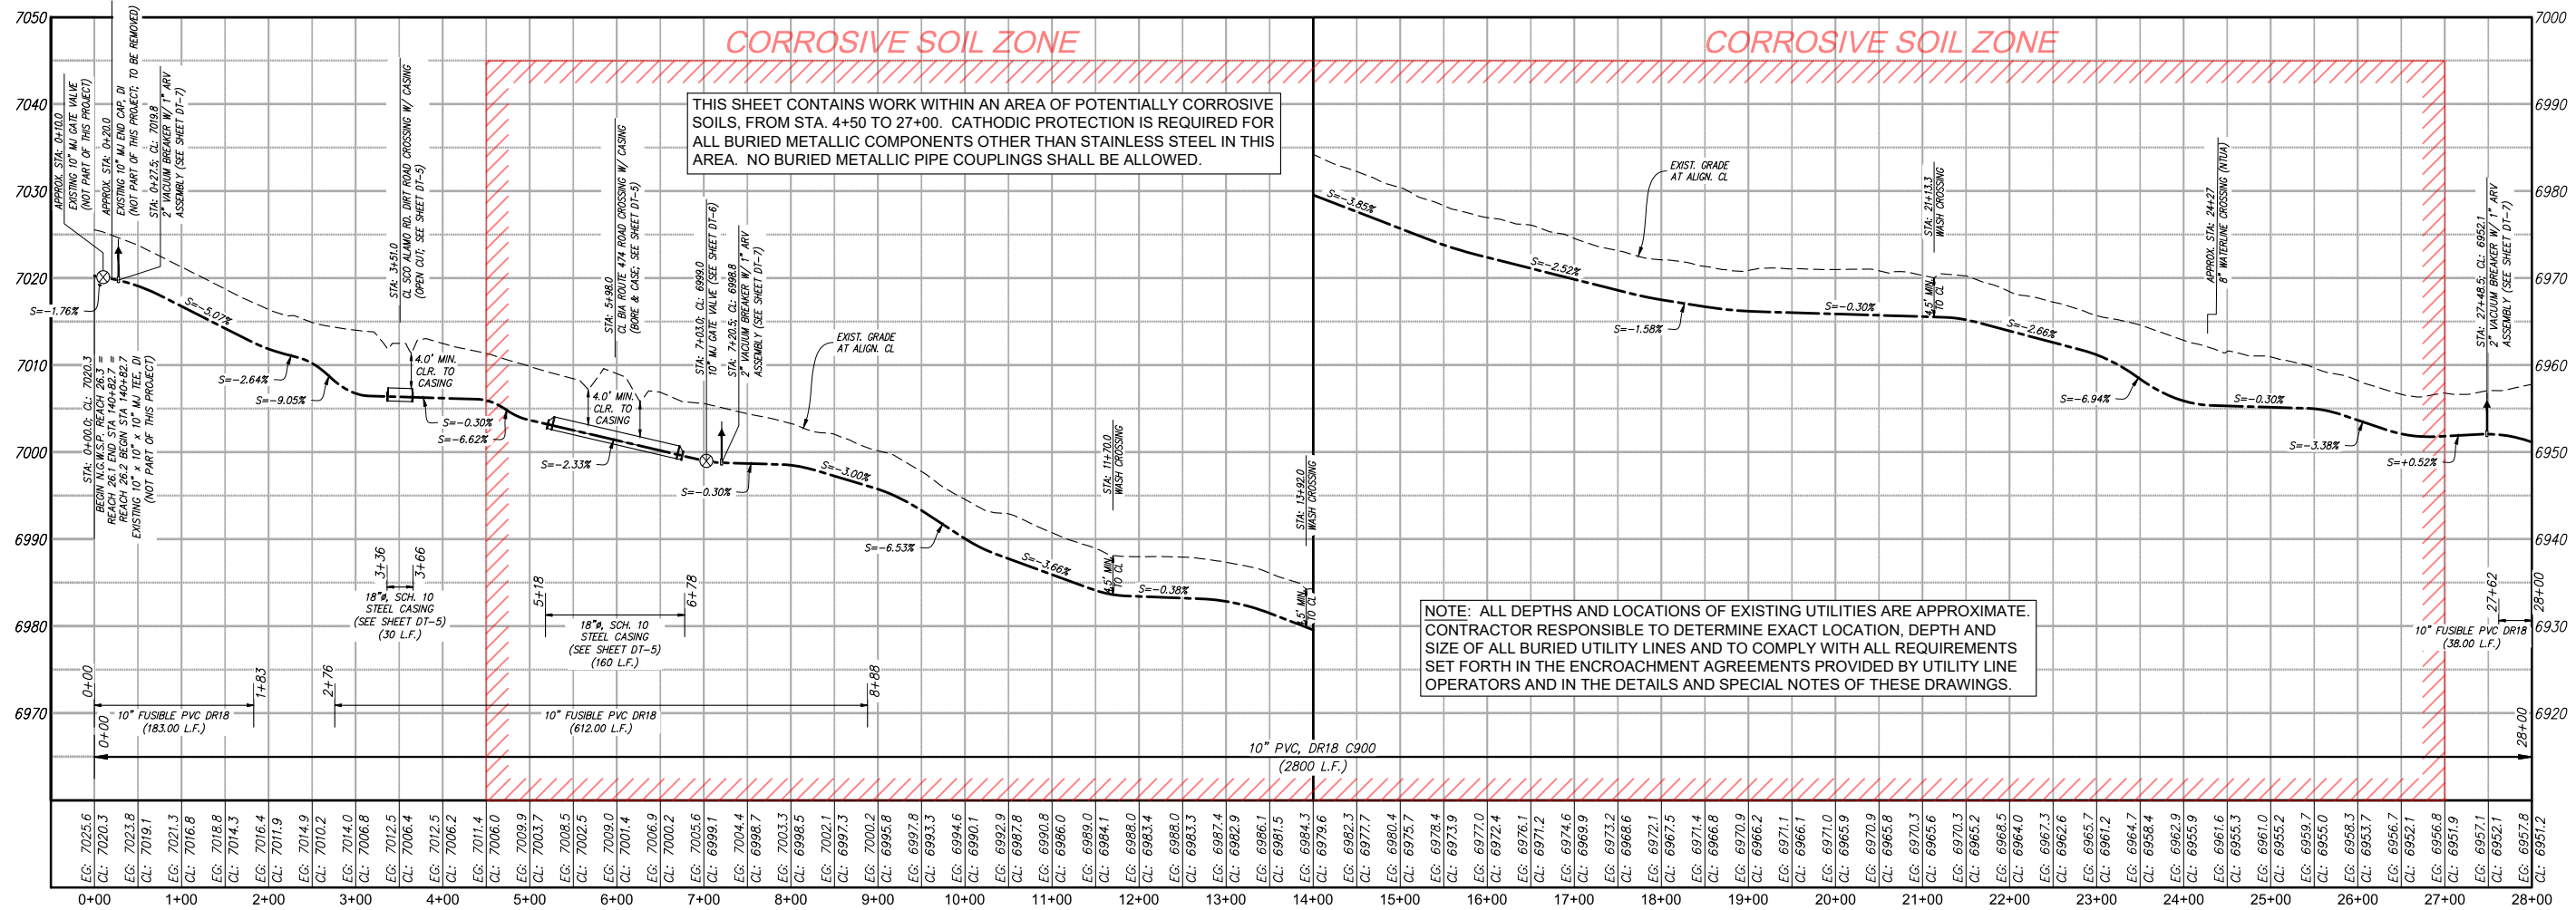

PROFILE VIEW
10" WATERLINE

Revision

Date

By

CHK'd

SOUDER, MILLER & ASSOCIATES

5454 VENCE AVENUE NE, SUITE D

ALBUQUERQUE, NM 87113

Phone (505) 299-0942 Toll-Free (877) 299-0942 Fax (505) 293-3430

www.soudermiller.com

Serving the Southwest & Rocky Mountains

Albuquerque, Carlsbad, Hobbs, Farmington, Las Cruces, Roswell, Santa Fe, NM

Conter, Grand Junction, CO - Safford, AZ - Moab, UT - El Paso, TX

CLIENT: The Navajo Nation

TOWN: Reach 26.3 To Tarron, NM

DESIGNED

DRAWN

CHECKED

TTT

MVA/AV

AGR

90% REVIEW

DRAFT

PRELIMINARY

NOT FOR CONSTRUCTION

THIS DRAWING IS INCOMPLETE AND NOT TO BE USED FOR CONSTRUCTION UNLESS IT IS STAMPED, SIGNED AND DATED

NOTICE OF EXTENDED PAYMENT PROVISION: THIS CONTRACT PROVIDES THAT THE OWNER SHALL MAKE PAYMENT WITHIN 45 DAYS AFTER SUBMISSION OF AN UNDISPUTED REQUEST FOR PAYMENT.

811

Know what's below. Call before you dig.



Date: September 27, 2018



Scale: Horiz: 1" = 200'

Vert: 1" = 20'

Project No: 6921307

Sheet: C-6

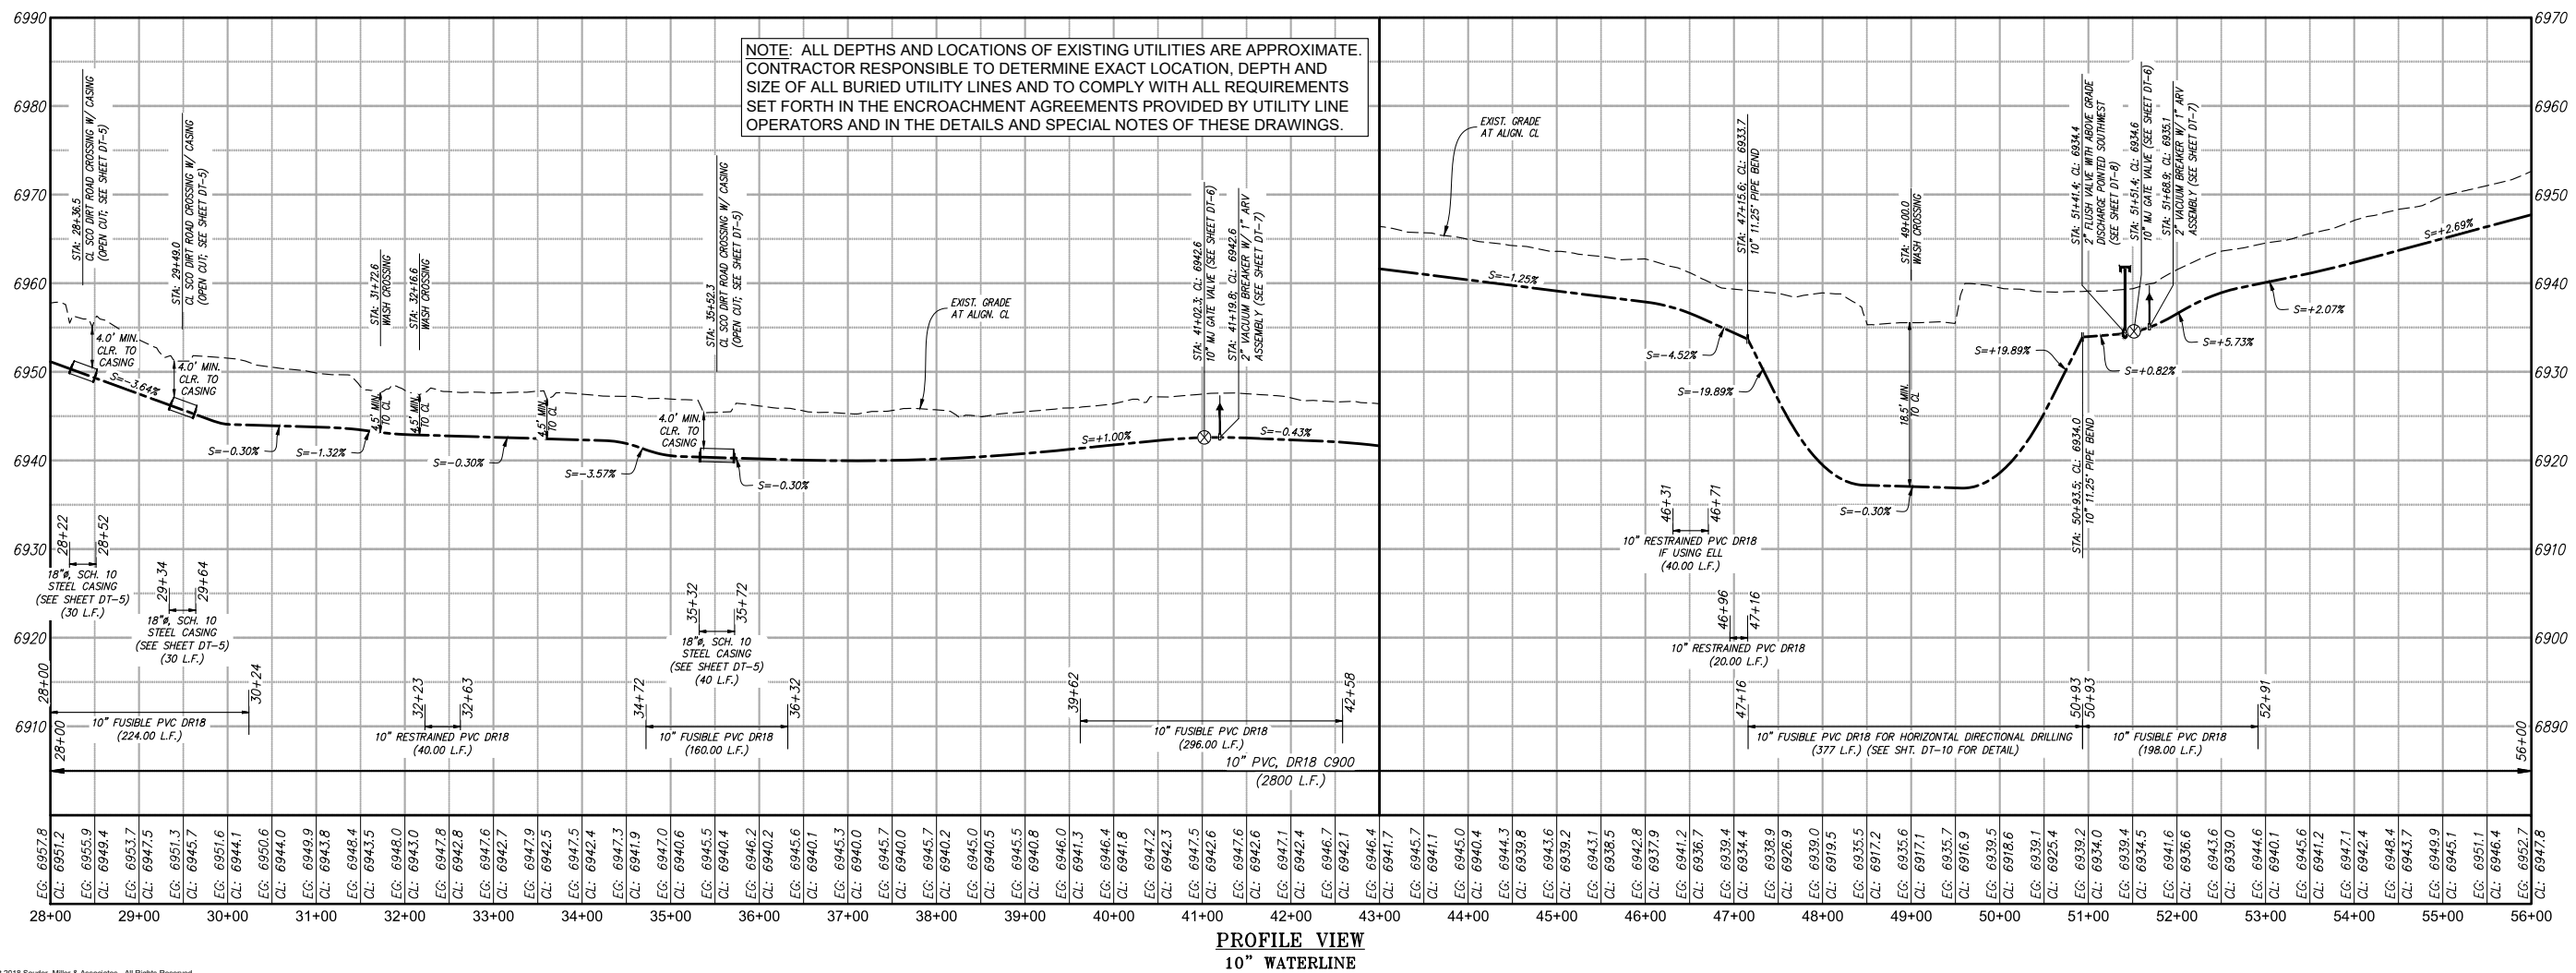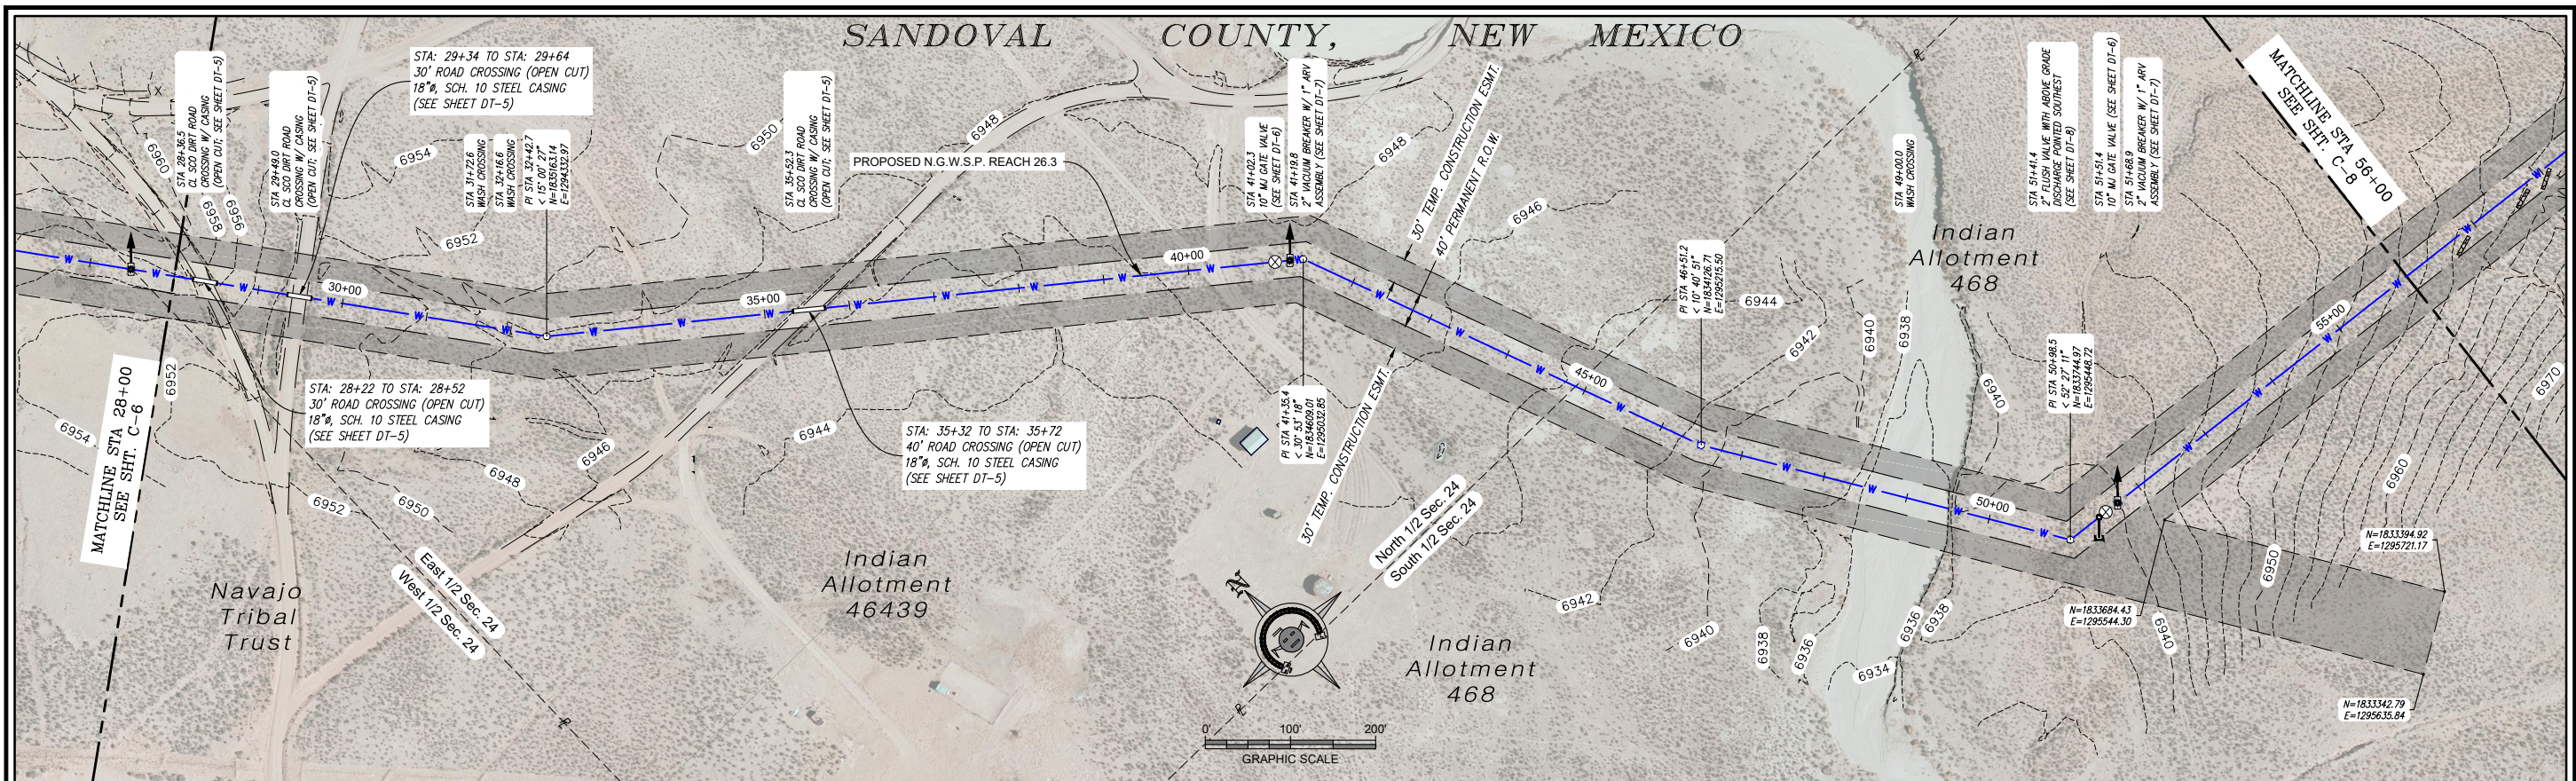

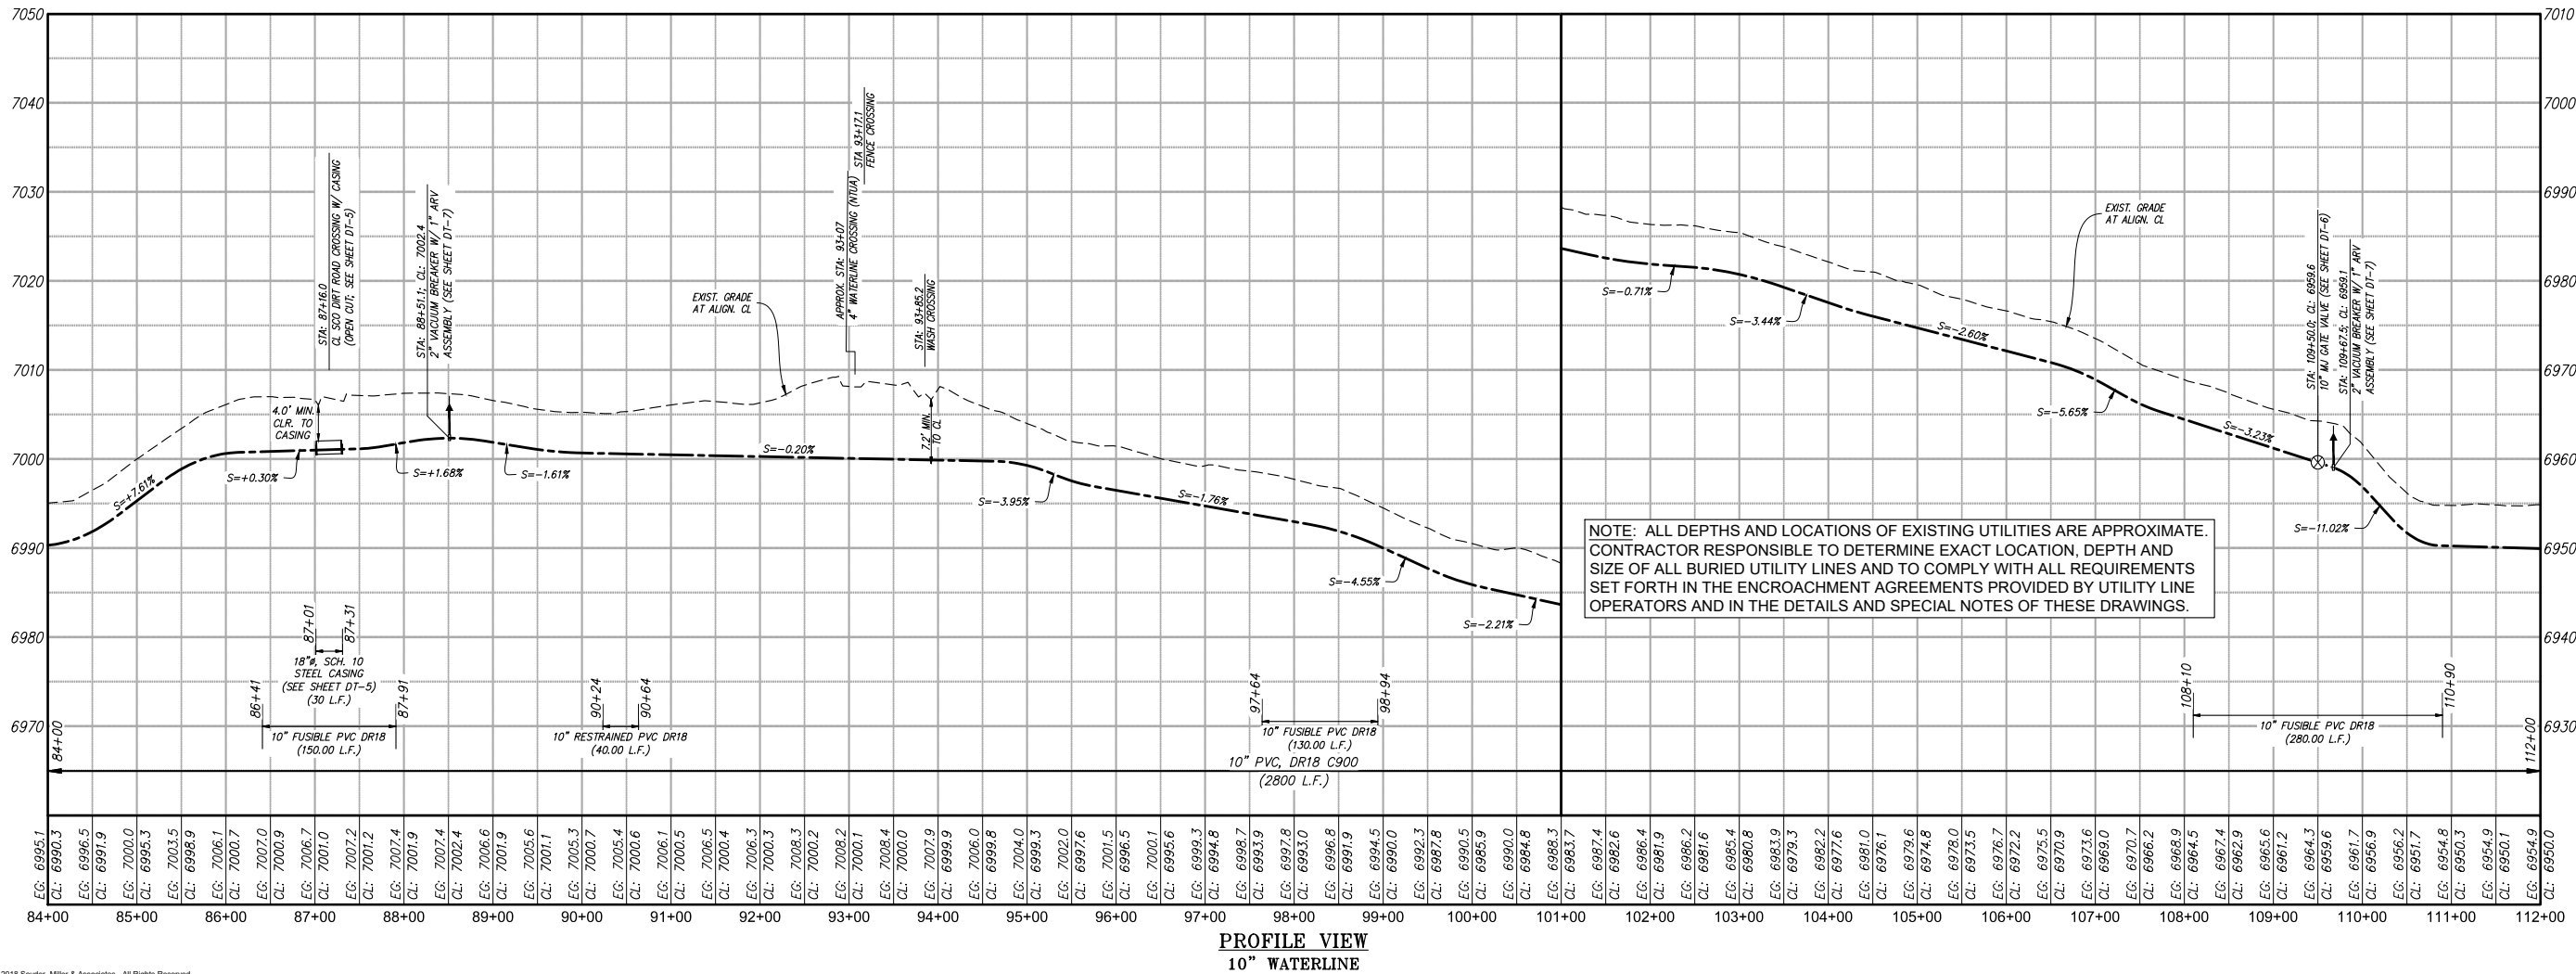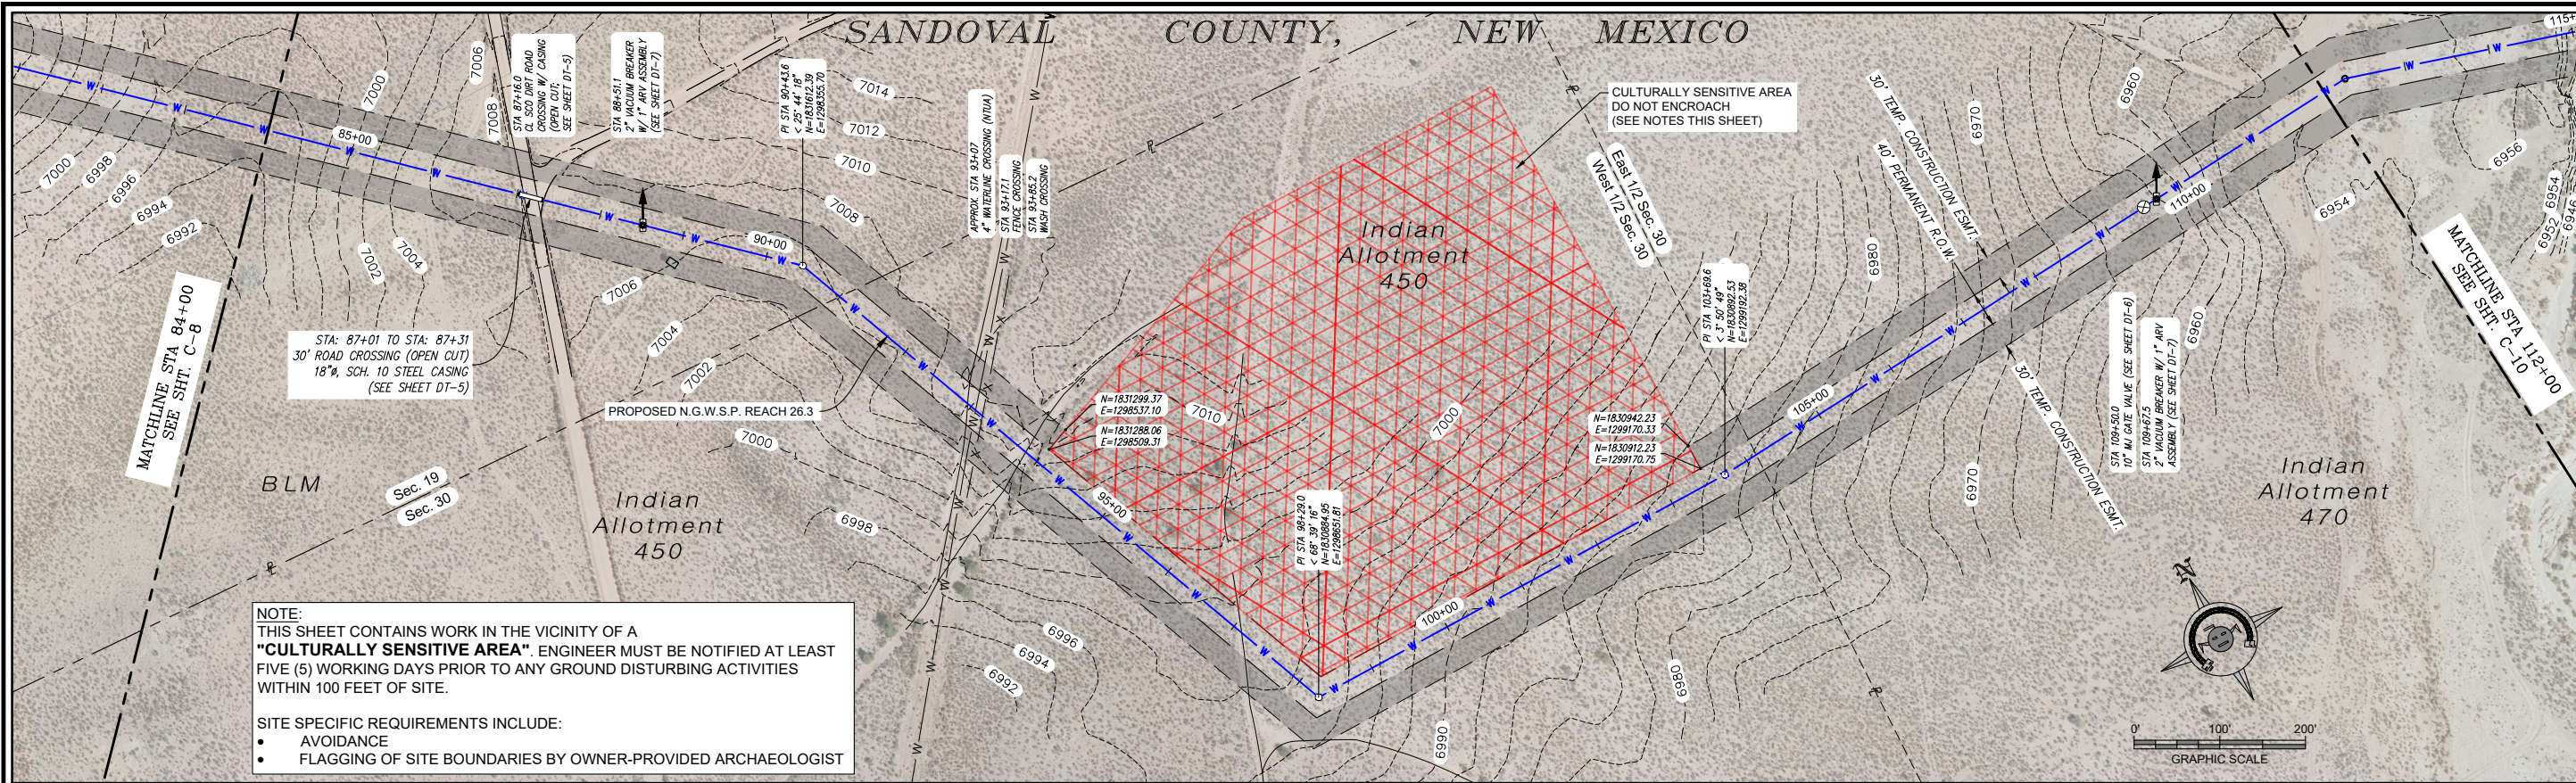

CLIENT: The Navajo Nation TOWN: Reach 26.3 To Torreon, NM

PLAN & PROFILE STA 84+00 TO STA 112+00
SECTIONS 19 & 30, T. 21 N., R. 5 W.
NAVAJO GALLUP WATER SUPPLY
PROJECT - REACH 26.3
SANDOVAL & MCKINLEY COUNTIES, NEW MEXICO

Designed TTT Drawn MVA/AG Checked AGR

90% REVIEW
DRAFT

PRELIMINARY
NOT FOR CONSTRUCTION

THIS DRAWING IS INCOMPLETE AND NOT TO BE USED FOR CONSTRUCTION UNLESS IT IS STAMPED, SIGNED AND DATED.

NOTICE OF EXTENDED PAYMENT PROVISION:
THIS CONTRACT ALLOWS THE OWNER TO MAKE PAYMENT WITHIN 45 DAYS AFTER SUBMISSION OF AN UNDISPUTED REQUEST FOR PAYMENT.


811 Know what's below. Call before you dig.

Date: September 27, 2018
Scale: Horiz: 1" = 200'
Vert: 1" = 20'


Project No: 6921307
Sheet: C-9

SOUDER, MILLER & ASSOCIATES
5454 VINCE AVENUE NE, SUITE D
ALBUQUERQUE, NM 87113
Phone (505) 299-0942 Toll-Free (877) 299-0942 Fax (505) 293-3430
www.soudermiller.com
Serving the Southwest & Rocky Mountains
Albuquerque, Carlsbad, Hobbs, Farmington, Las Cruces, Roswell, Santa Fe, NM
Concepcion, Grand Junction, CO - Safford, AZ - Momb, UT - El Paso, TX

SANDOVAL COUNTY, NEW MEXICO

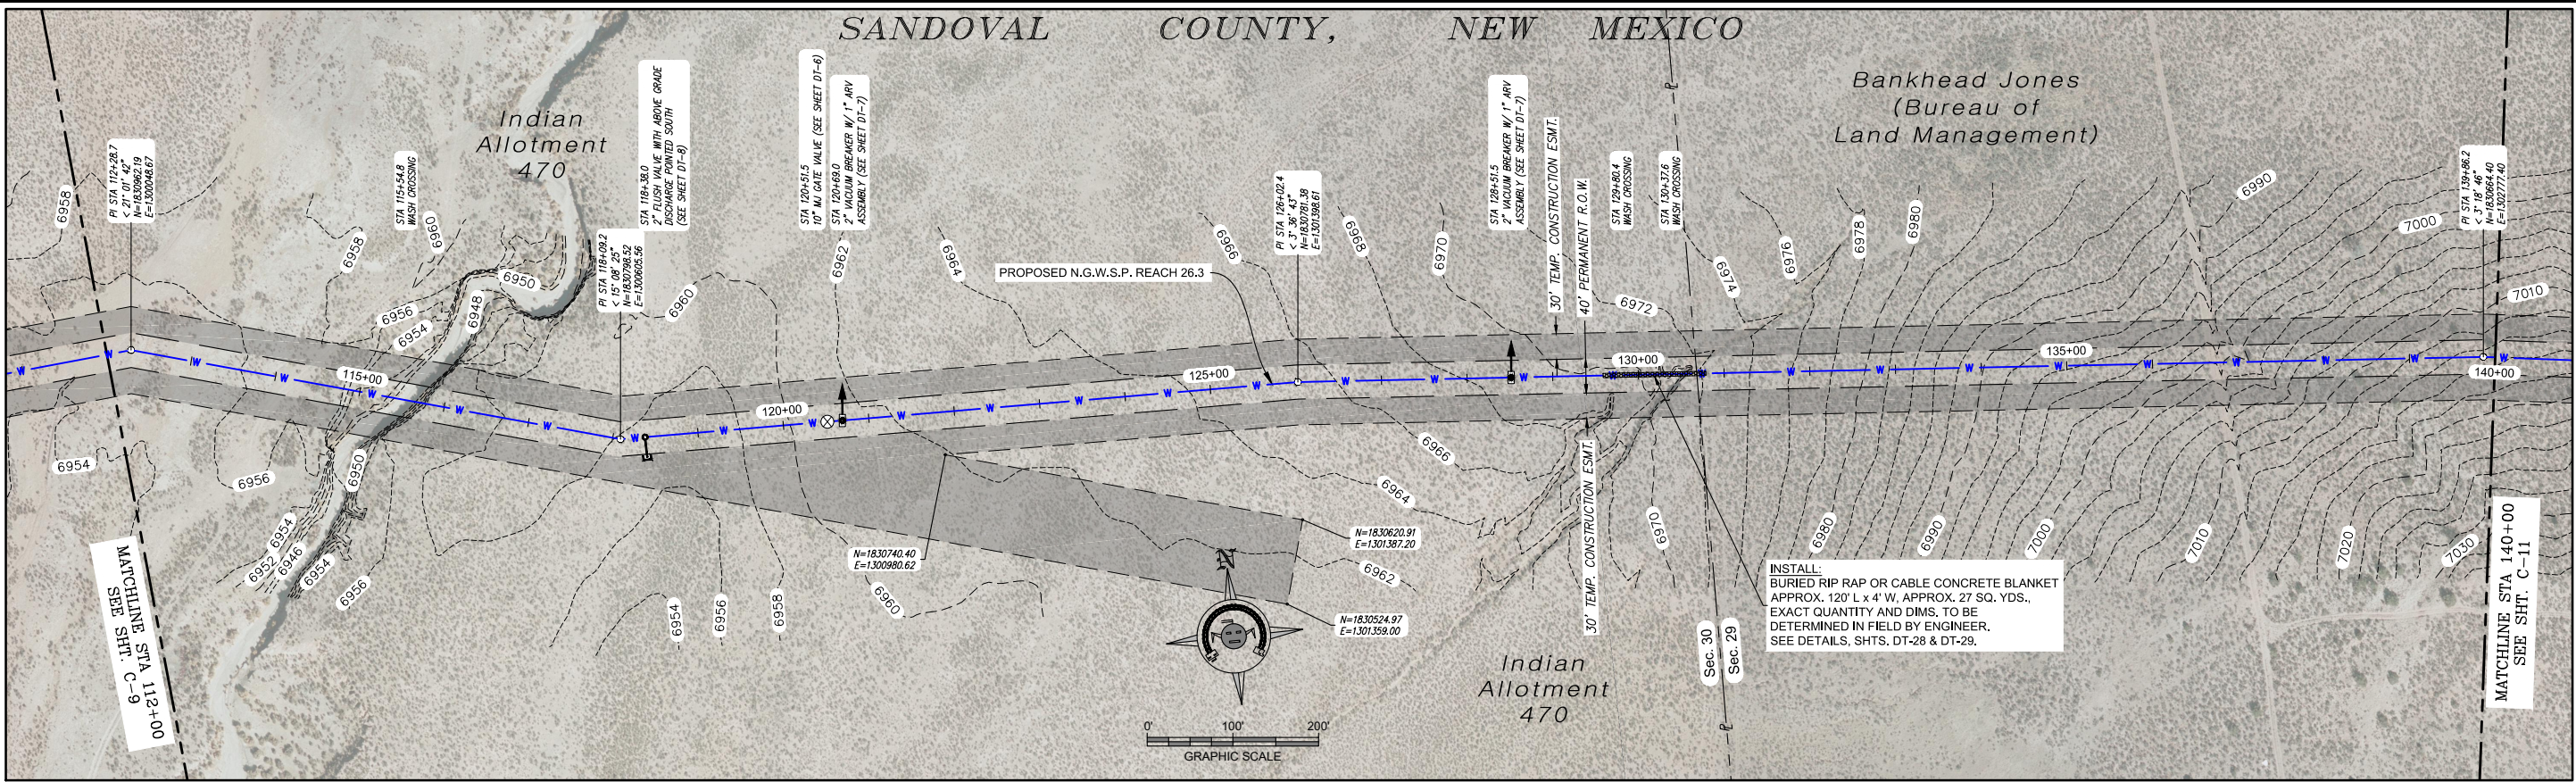

PLAN VIEW
10" WATERLINE

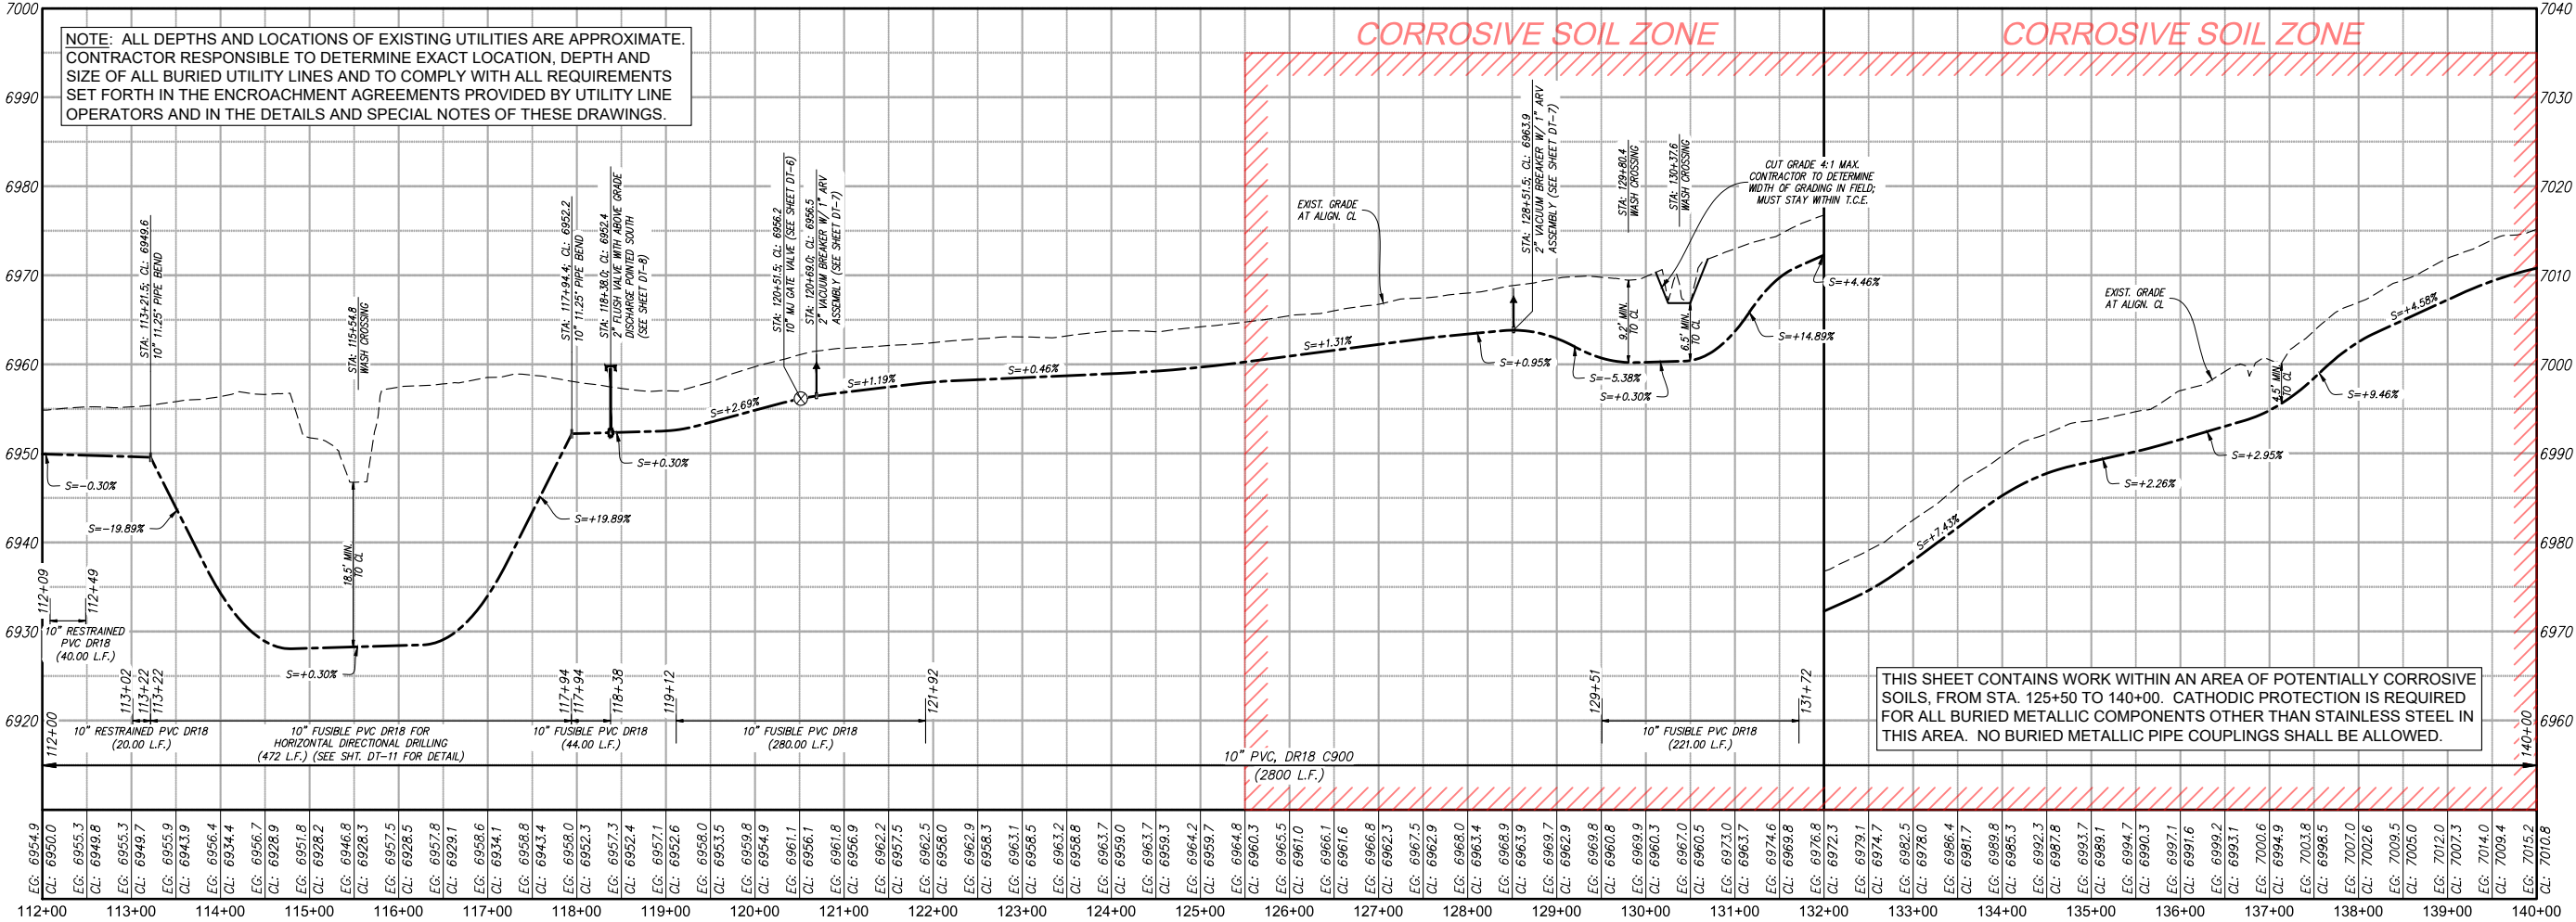

PROFILE VIEW
10" WATERLINE

Revision	Date	Description	By	CHK'd

SMA
Souder, Miller & Associates
5454 VANCE AVENUE NE, SUITE D
ALBUQUERQUE, NM 87113
Phone (505) 299-0942 Toll-Free (877) 299-0942 Fax (505) 293-3430
www.soudermiller.com
Serving the Southwest & Rocky Mountains
Albuquerque, Carlsbad, Hobbs, Farmington, Las Cruces, Roswell, Santa Fe, NM
Conter, Grand Junction, CO - Safford, AZ - Moab, UT - El Paso, TX

CLIENT: The Navajo Nation
TOWN: Reach 26.3 To Tarron, NM
PLAN & PROFILE STA 112+00 TO STA 140+00
SECTIONS 29 & 30, T. 21 N., R. 5 W.
NAVAJO GALLUP WATER SUPPLY
PROJECT - REACH 26.3
SANDOVAL & MCKINLEY COUNTIES, NEW MEXICO

Designed	Drawn	Checked
TTT	MW/AAV	AGR

90% REVIEW
DRAFT
PRELIMINARY
NOT FOR CONSTRUCTION


THIS DRAWING IS INCOMPLETE
AND NOT TO BE USED FOR
CONSTRUCTION UNLESS IT IS
STAMPED, SIGNED AND DATED

NOTICE OF EXTENDED
PAYMENT PROVISION:
THIS CONTRACT ALLOWS THE
OWNER TO MAKE PAYMENT
WITHIN 45 DAYS AFTER
SUBMISSION OF
AN UNDISPUTED REQUEST
FOR PAYMENT.


811 Know what's
below.
Call before
you dig.

Date: September 27, 2018
Scale: Horiz: 1" = 200'
Vert: 1" = 20'
Project No: 6921307
Sheet: C-10

SANDOVAL COUNTY, NEW MEXICO

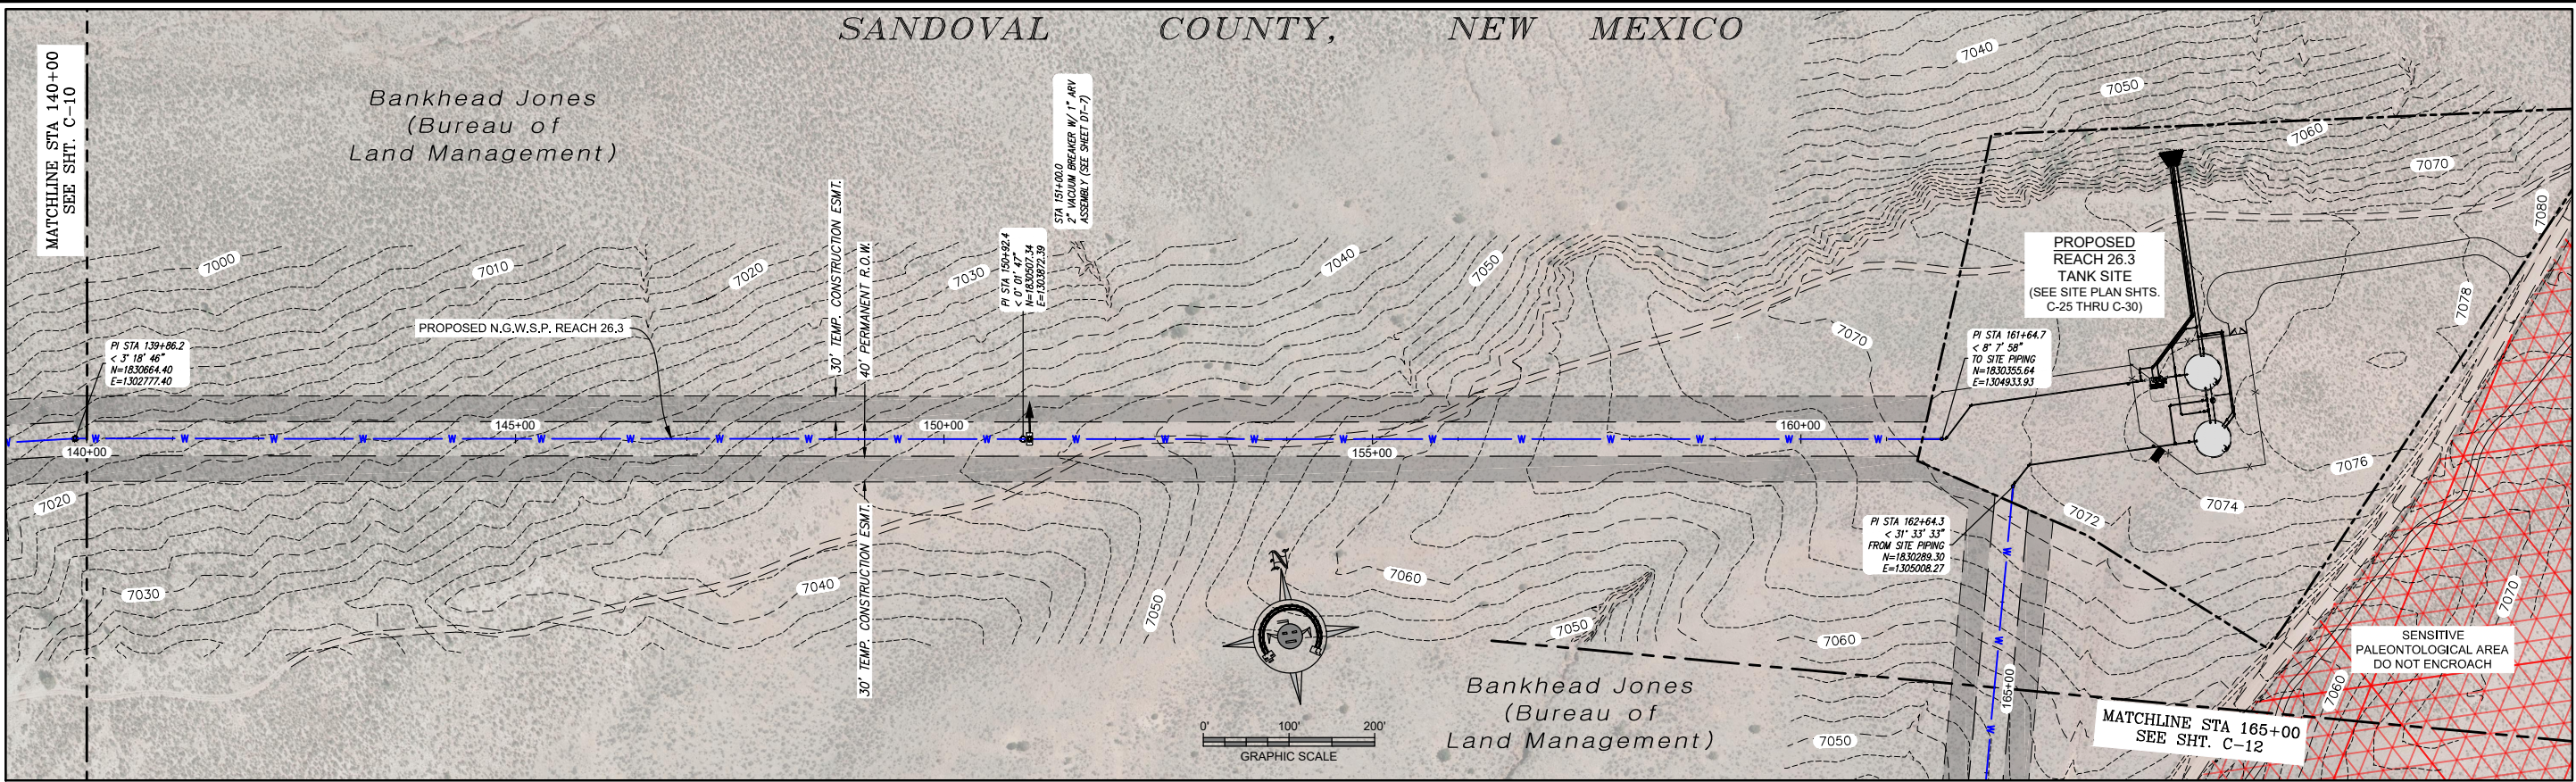

PLAN VIEW
10" & 12" WATERLINE

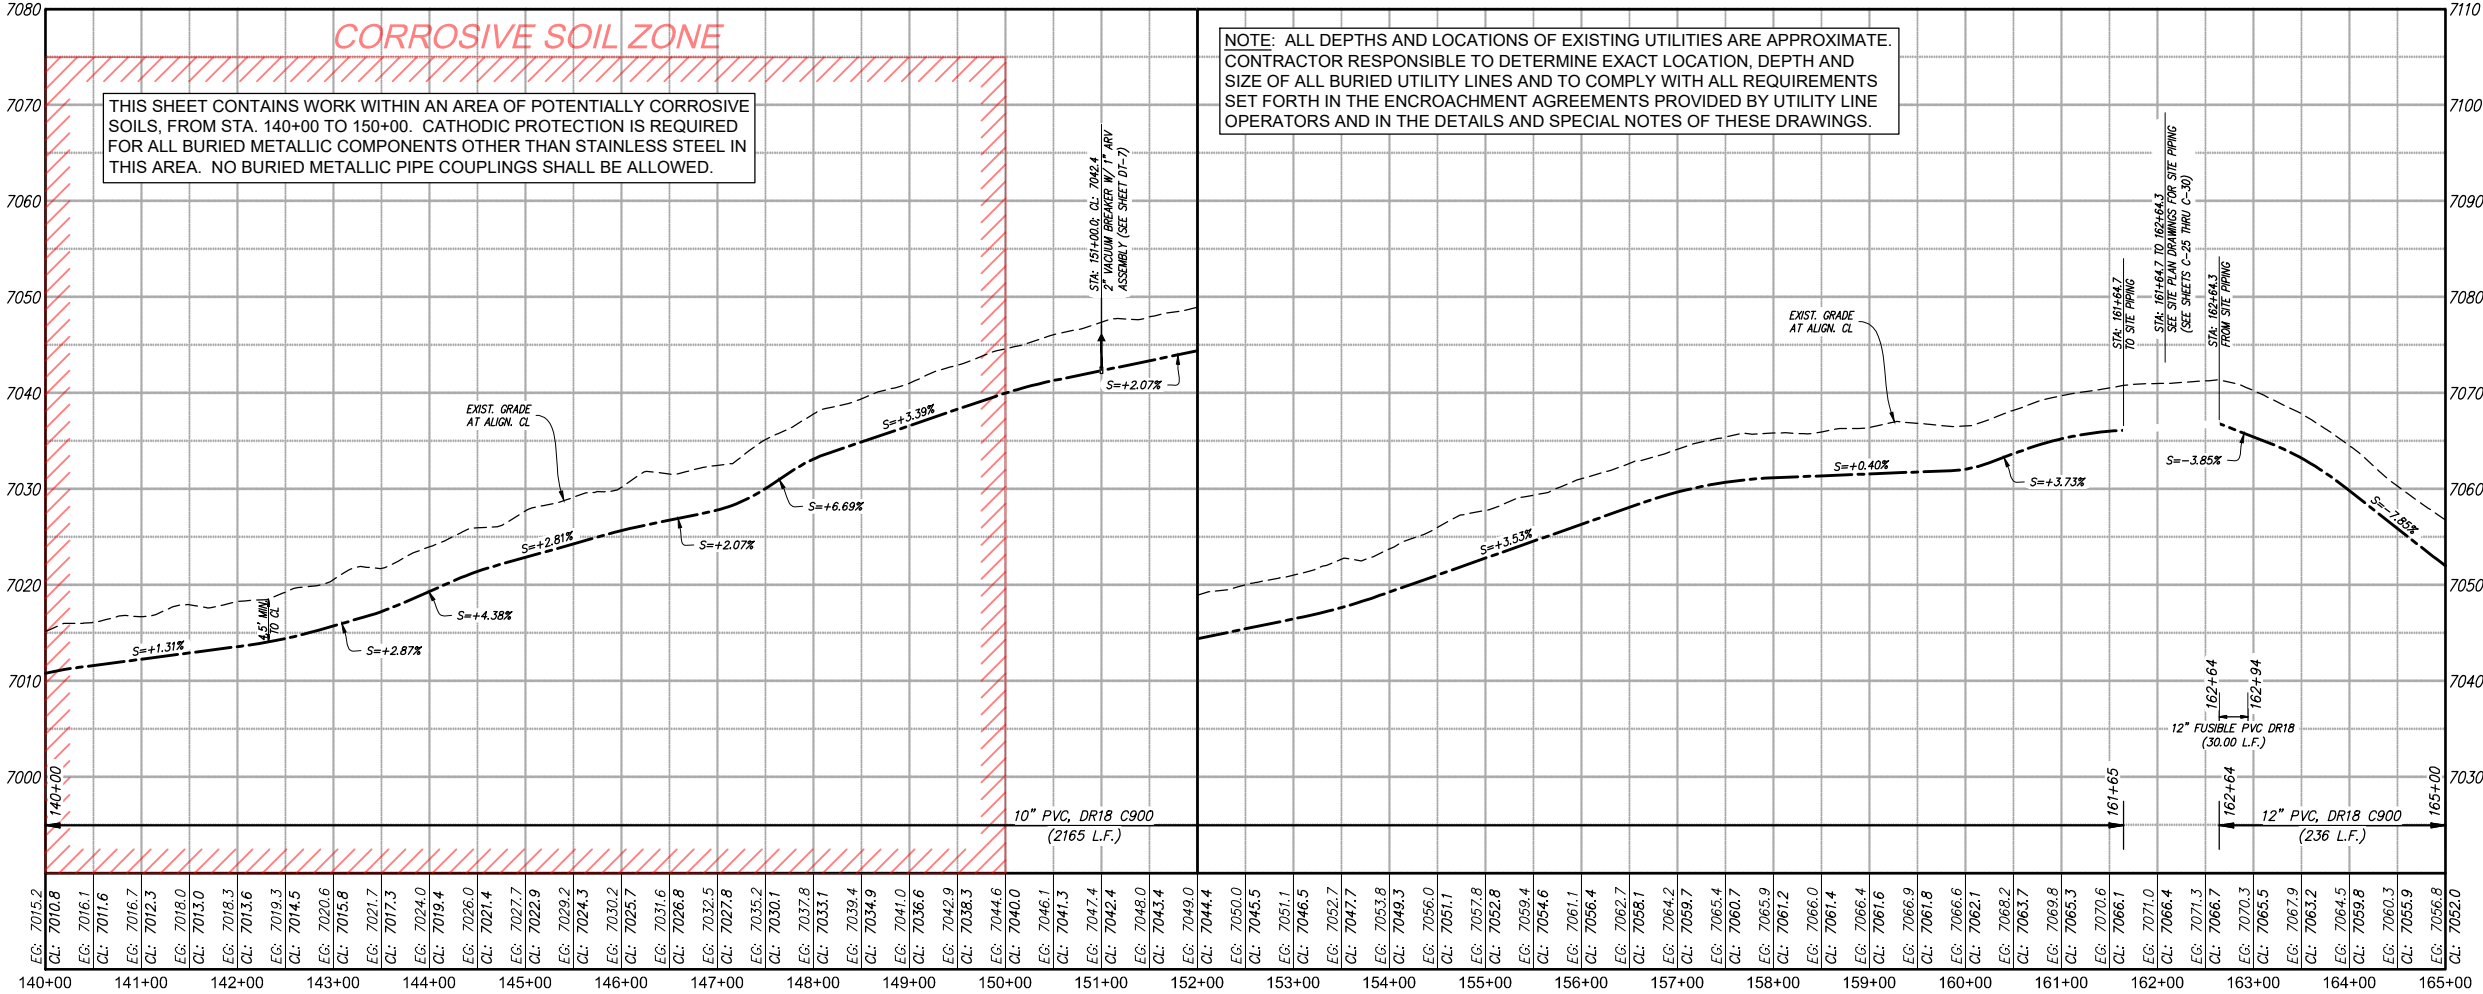

PROFILE VIEW
10" & 12" WATERLINE

Revision	Date	Description	By	CHK'd

SMA
SOUDER, MILLER & ASSOCIATES
5454 VENCE AVENUE NE, SUITE D
ALBUQUERQUE, NM 87113
Phone (505) 299-0942 Toll-Free (877) 999-0942 Fax (505) 293-3430
www.soudermiller.com
Serving the Southwest & Rocky Mountains
Albuquerque, Carlsbad, Hobbs, Farmington, Las Cruces, Roswell, Santa Fe, NM
Concepcion, Grand Junction, CO - Safford, AZ - Moab, UT - El Paso, TX

CLIENT: The Navajo Nation TOWN: Reach 26.3 To Tarron, NM
PLAN & PROFILE STA 140+00 To STA 165+00
SECTION 29, T. 21 N., R. 5 W.
NAVAJO GALLUP WATER SUPPLY
PROJECT - REACH 26.3
SANDOVAL & MCKINLEY COUNTIES, NEW MEXICO

Designed TTT Drawn MTH/AAV Checked AGR

90% REVIEW
DRAFT

PRELIMINARY
NOT FOR CONSTRUCTION


THIS DRAWING IS INCOMPLETE AND NOT TO BE USED FOR CONSTRUCTION UNLESS IT IS STAMPED, SIGNED AND DATED

NOTICE OF EXTENDED PAYMENT PROVISION:
THIS CONTRACT ALLOWS THE OWNER TO MAKE PAYMENT WITHIN 45 DAYS AFTER SUBMISSION OF AN UNDISPUTED REQUEST FOR PAYMENT.


811 Know what's below. Call before you dig.

Date: October 1, 2018
Scale: Horiz: 1" = 200'
Vert: 1" = 20'

Project No: 6921307
Sheet: C-11

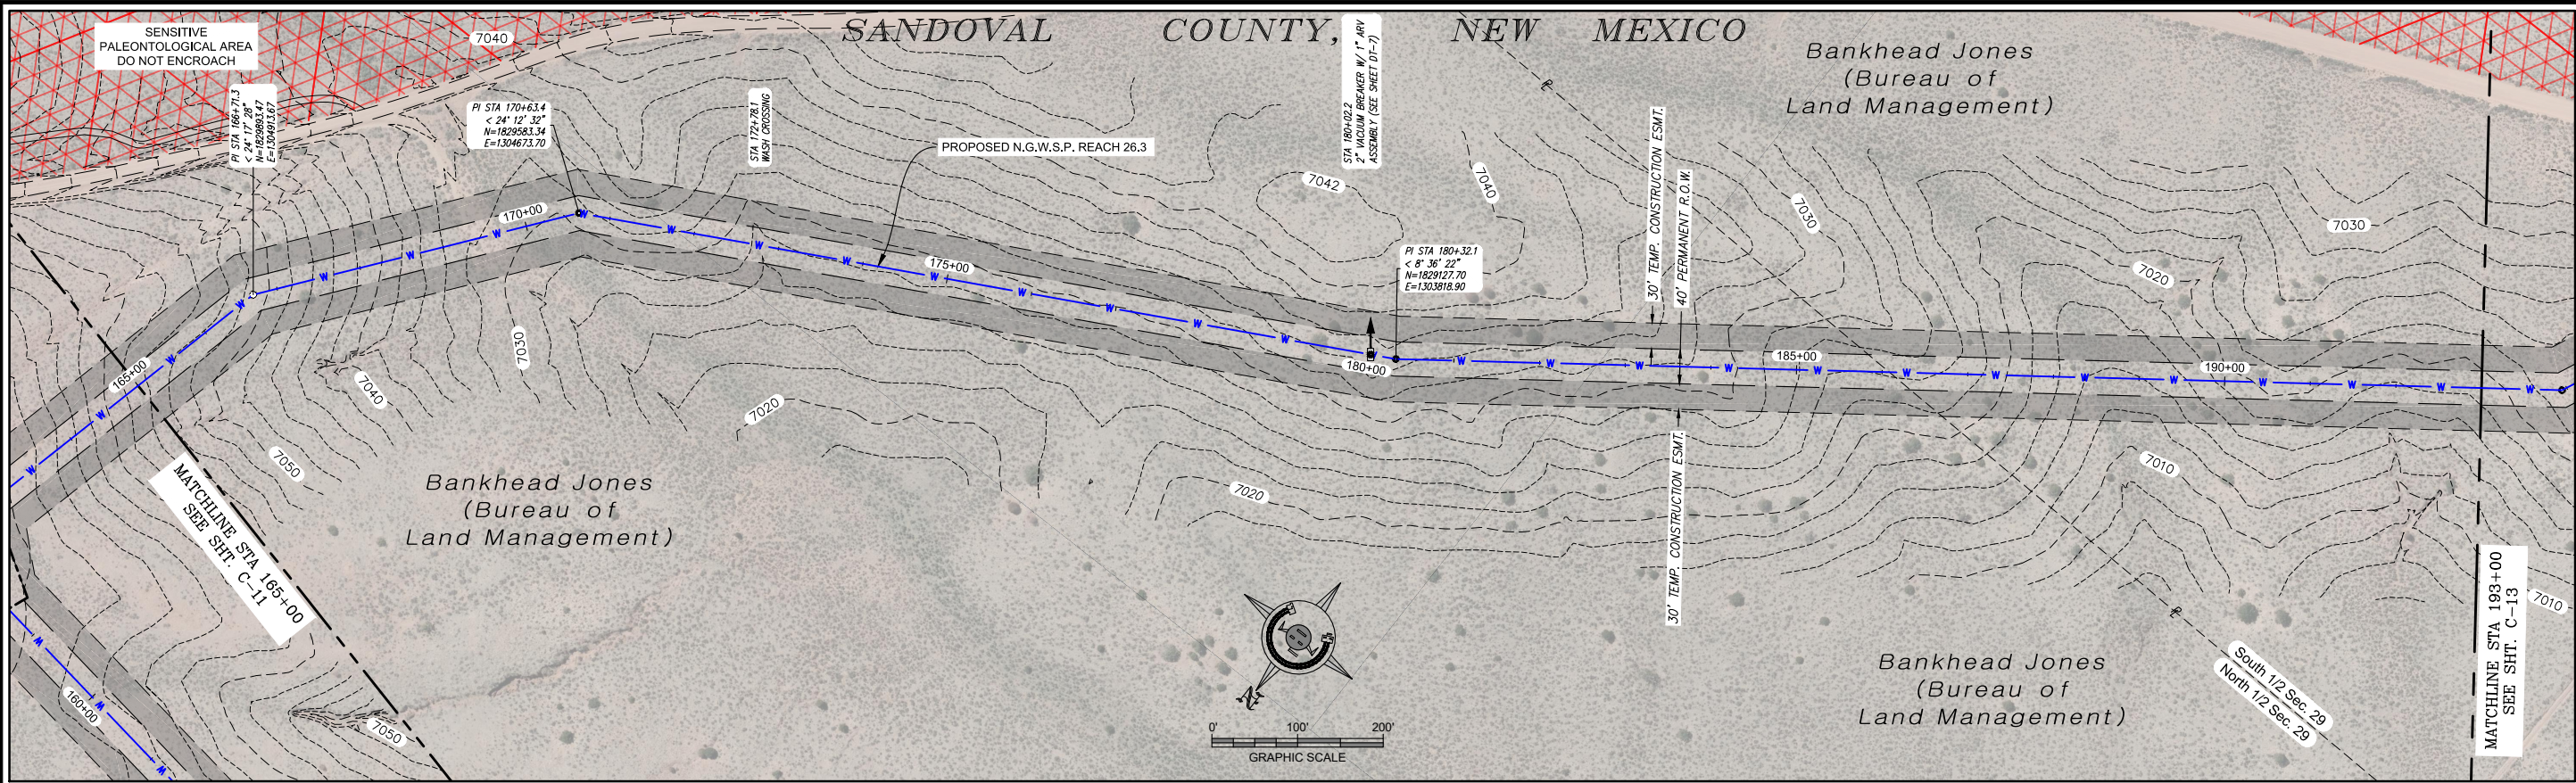

PLAN VIEW
12" WATERLINE

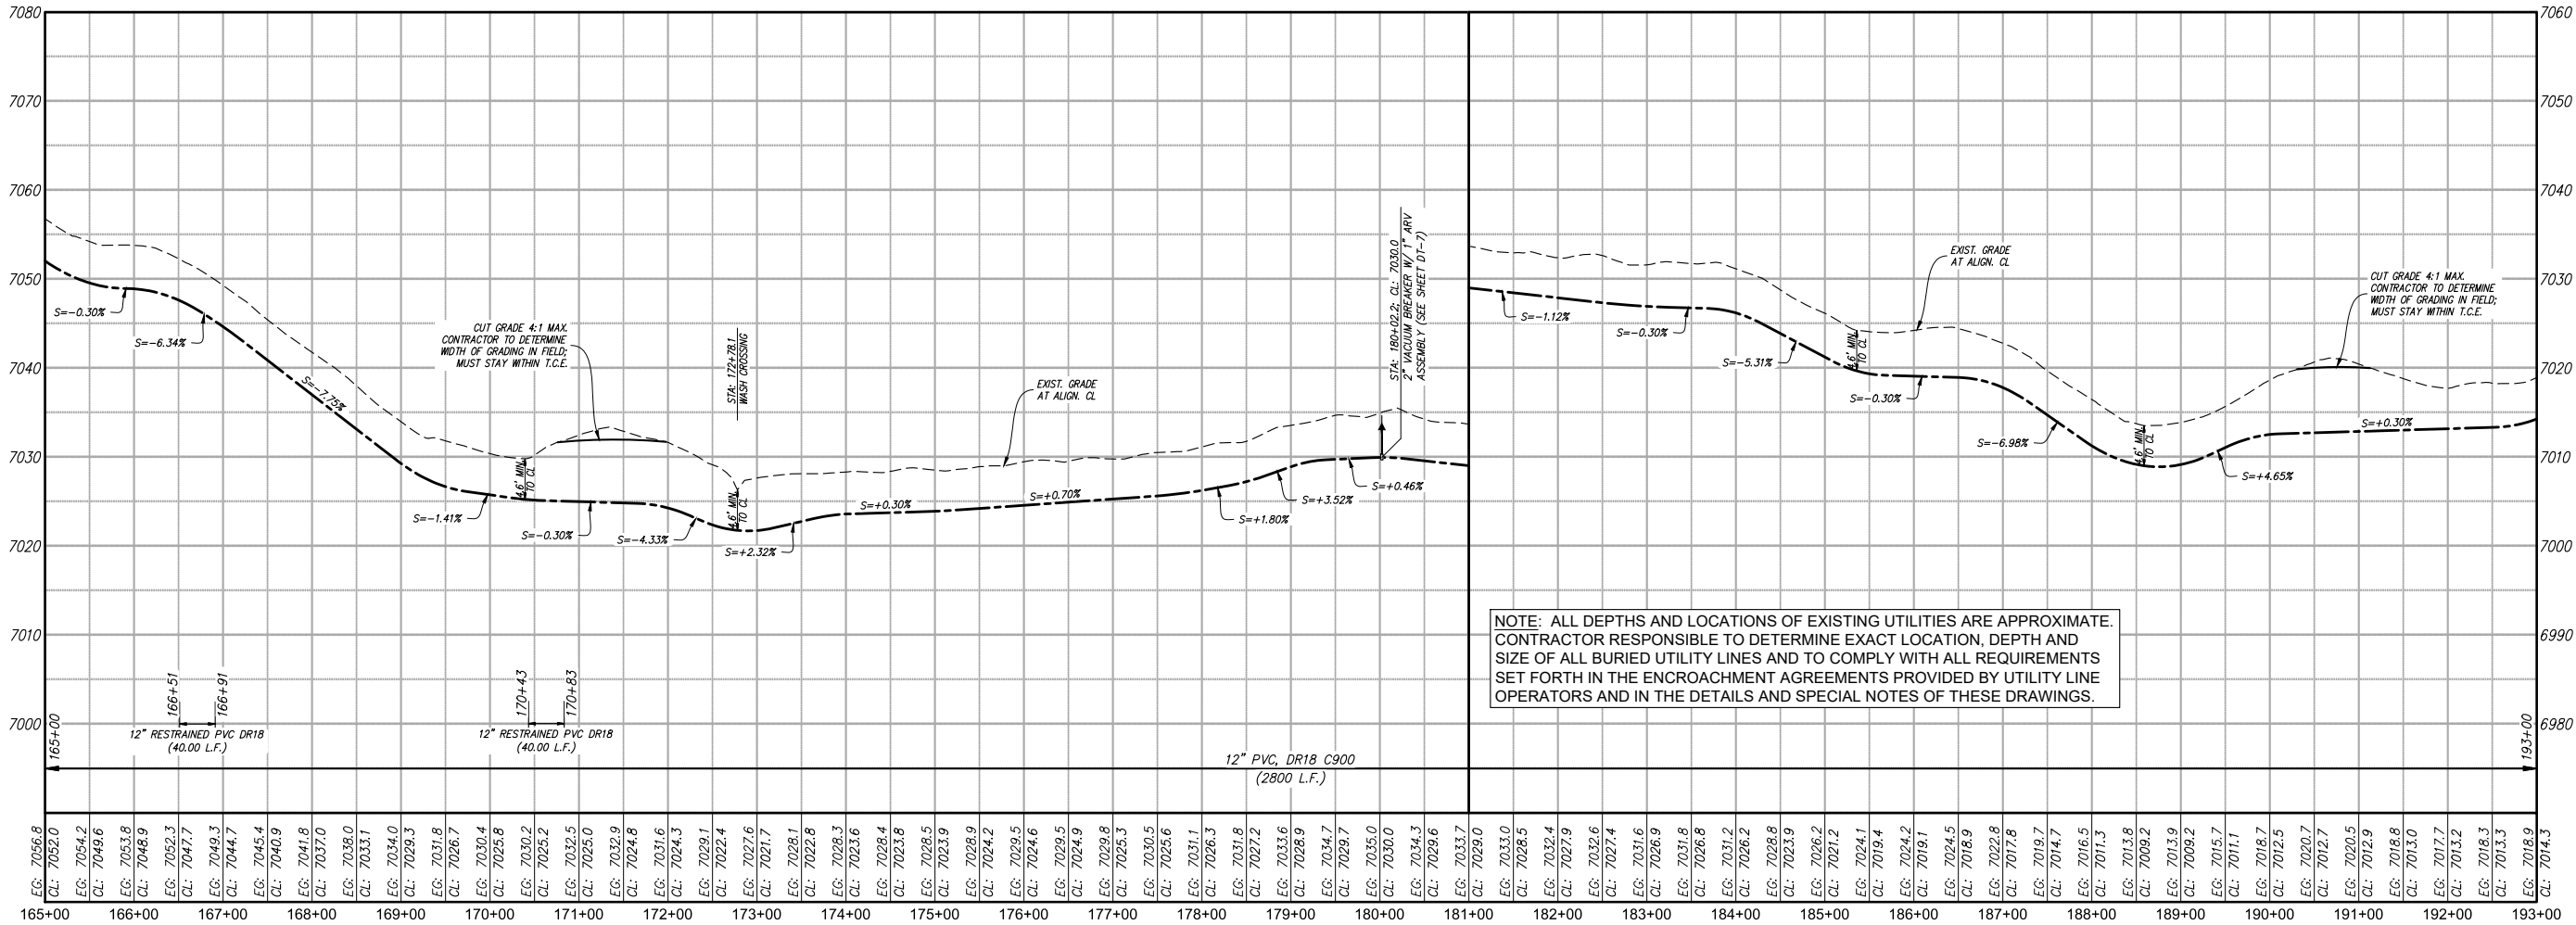

PROFILE VIEW
12" WATERLINE

Revision	Date	Description	By	CHK'd

SOUDER, MILLER & ASSOCIATES
5454 VENCE AVENUE NE, SUITE D
ALBUQUERQUE, NM 87113
Phone (505) 299-0942 Toll-Free (877) 299-0942 Fax (505) 293-3430
www.soudermiller.com
Serving the Southwest & Rocky Mountains
Albuquerque, Carlsbad, Hobbs, Farmington, Las Cruces, Roswell, Santa Fe, NM
Cortez, Grand Junction, CO - Safford, AZ - Moab, UT - El Paso, TX
10/27/2018 4:57:08PM aw

CLIENT: The Navajo Nation TOWN: Reach 26.3 To Tarron, NM
PLAN & PROFILE STA 165+00 To STA 193+00
SECTION 29, T. 21 N., R. 5 W.
NAVAJO GALLUP WATER SUPPLY
PROJECT - REACH 26.3
SANDOVAL & MCKINLEY COUNTIES, NEW MEXICO

Designed	Drawn	Checked
TTT	MW/AAV	AGR

90% REVIEW
DRAFT

PRELIMINARY
NOT FOR CONSTRUCTION

THIS DRAWING IS INCOMPLETE AND NOT TO BE USED FOR CONSTRUCTION UNLESS IT IS STAMPED, SIGNED AND DATED.

NOTICE OF EXTENDED PAYMENT PROVISION:
THIS CONTRACT ALLOWS THE OWNER TO MAKE PAYMENT WITHIN 45 DAYS AFTER SUBMISSION OF AN UNDERSIGNED REQUEST FOR PAYMENT.

811 Know what's below. Call before you dig.

Date: September 27, 2018
Scale: Horiz: 1" = 200'
Vert: 1" = 20'


Project No: 6921307
Sheet: C-12

SANDOVAL COUNTY, NEW MEXICO


Bureau of
Land Management

Bureau of
Land Management

Bureau of
Land Management

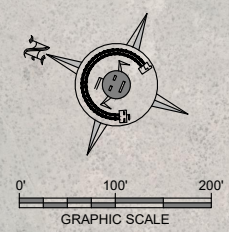

PLAN VIEW
12" WATERLINE

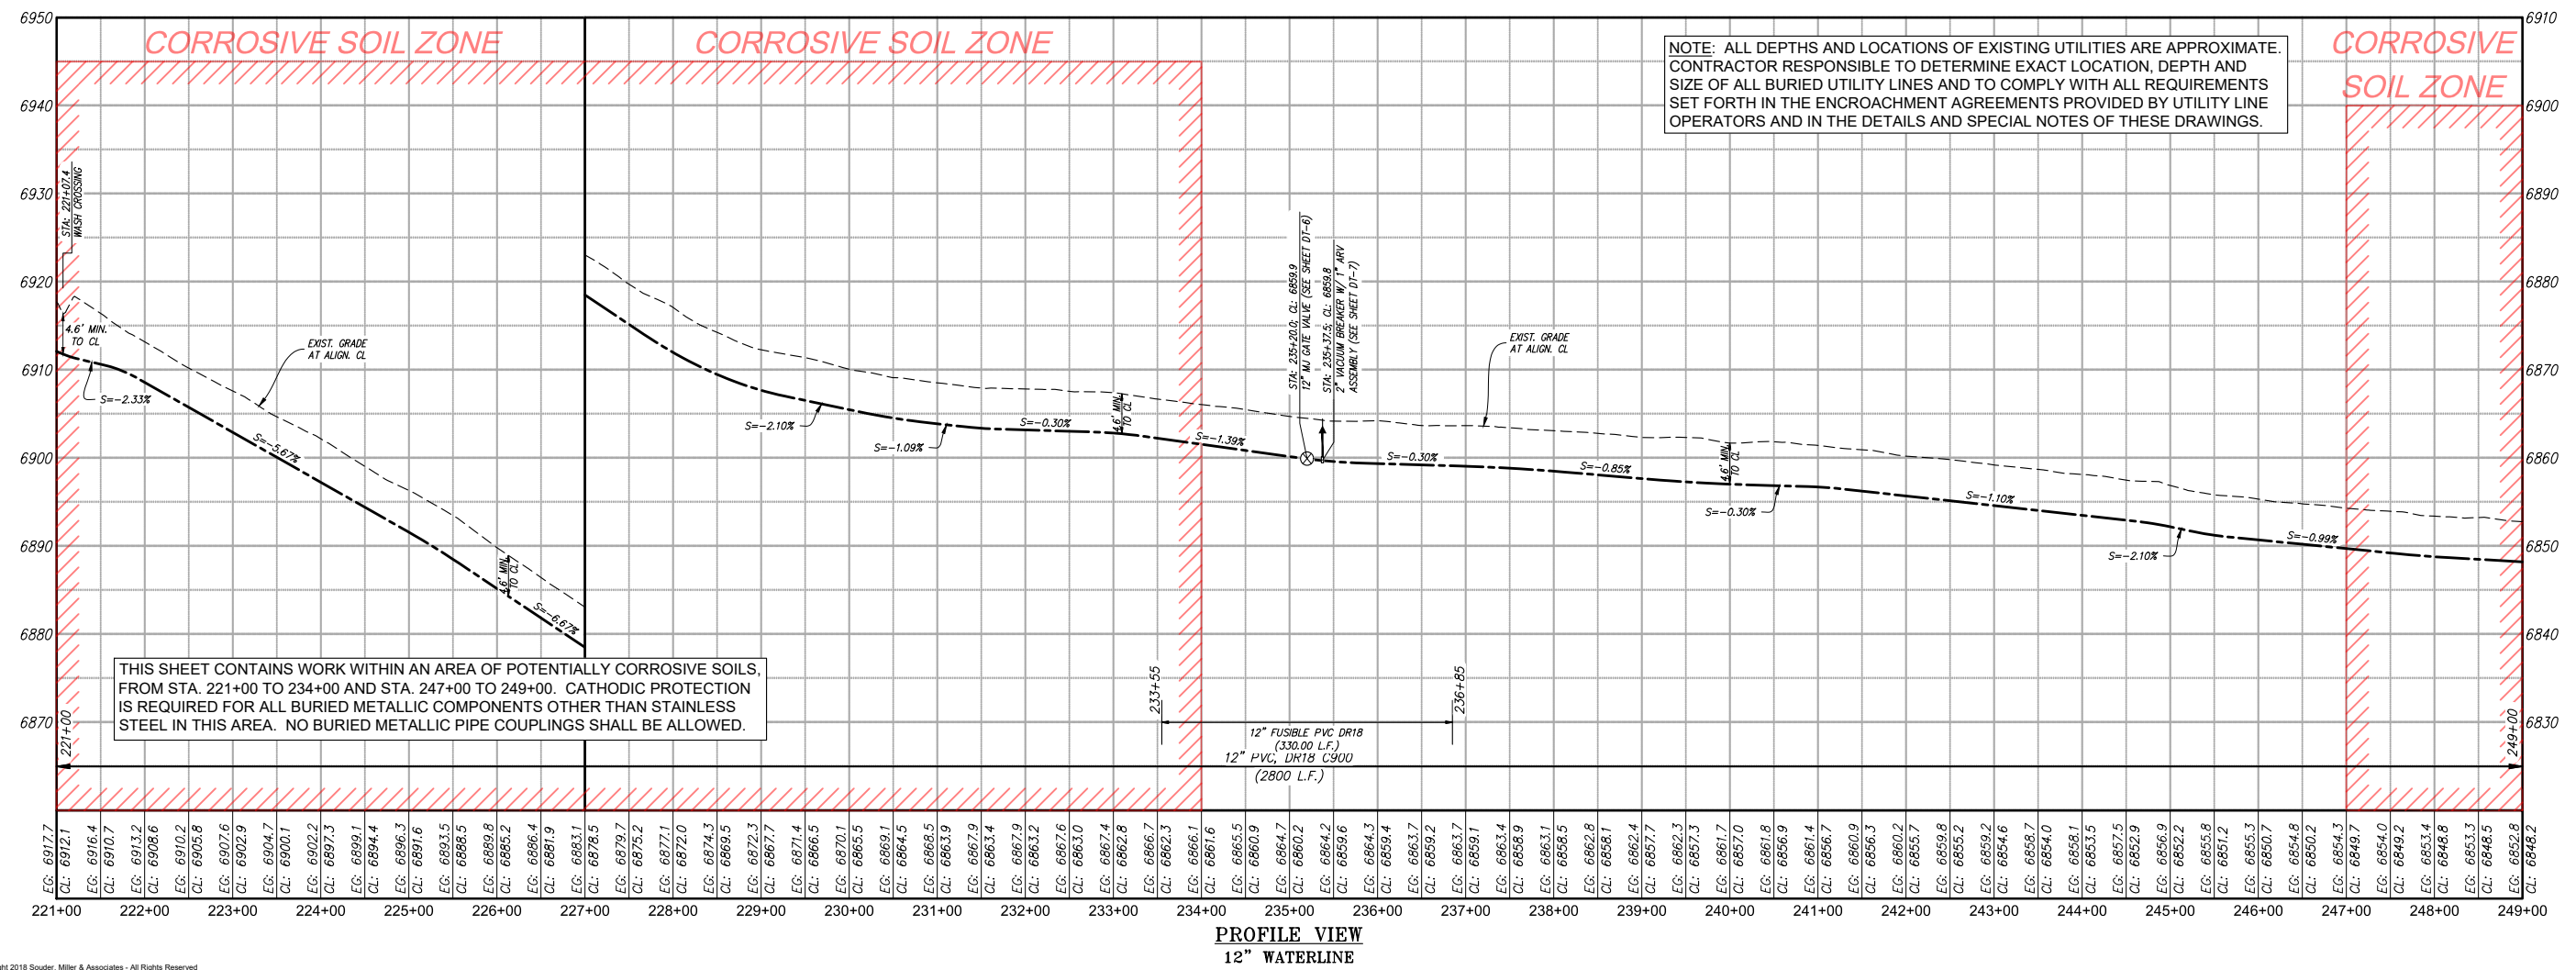

PROFILE VIEW
12" WATERLINE

Revision	Date	Description	By	CHK'd

SMA
Engineering & Environmental Surveying

SOUDER, MILLER & ASSOCIATES
5454 VENCE AVENUE NE, SUITE D
ALBUQUERQUE, NM 87113
Phone (505) 299-0942 Toll-Free (877) 299-0942 Fax (505) 293-3430
www.soudermiller.com

Serving the Southwest & Rocky Mountains
Albuquerque, Carlsbad, Hobbs, Farmington, Las Cruces, Roswell, Santa Fe, NM
Cortez, Grand Junction, CO - Safford, AZ - Moab, UT - El Paso, TX

CLIENT: The Navajo Nation
TOWN: Reach 26.3 To Tarron, NM

PLAN & PROFILE STA 221+00 To STA 249+00
SECTION 32, T. 21 N., R. 5 W.
NAVAJO GALLUP WATER SUPPLY
PROJECT - REACH 26.3
SANDOVAL & MCKINLEY COUNTIES, NEW MEXICO

Designed: TTT
Drawn: MTH/AAV
Checked: AGR

90% REVIEW
DRAFT

PRELIMINARY
NOT FOR CONSTRUCTION


THIS DRAWING IS INCOMPLETE AND NOT TO BE USED FOR CONSTRUCTION UNLESS IT IS STAMPED, SIGNED AND DATED.

NOTICE OF EXTENDED PAYMENT PROVISION:
THIS CONTRACT ALLOWS THE OWNER TO MAKE PAYMENT WITHIN 45 DAYS AFTER SUBMISSION OF AN UNDISPUTED REQUEST FOR PAYMENT.


811 Know what's below. Call before you dig.

Date: September 27, 2018
Scale: Horiz: 1" = 200'
Vert: 1" = 20'

Project No: 6921307
Sheet: C-14

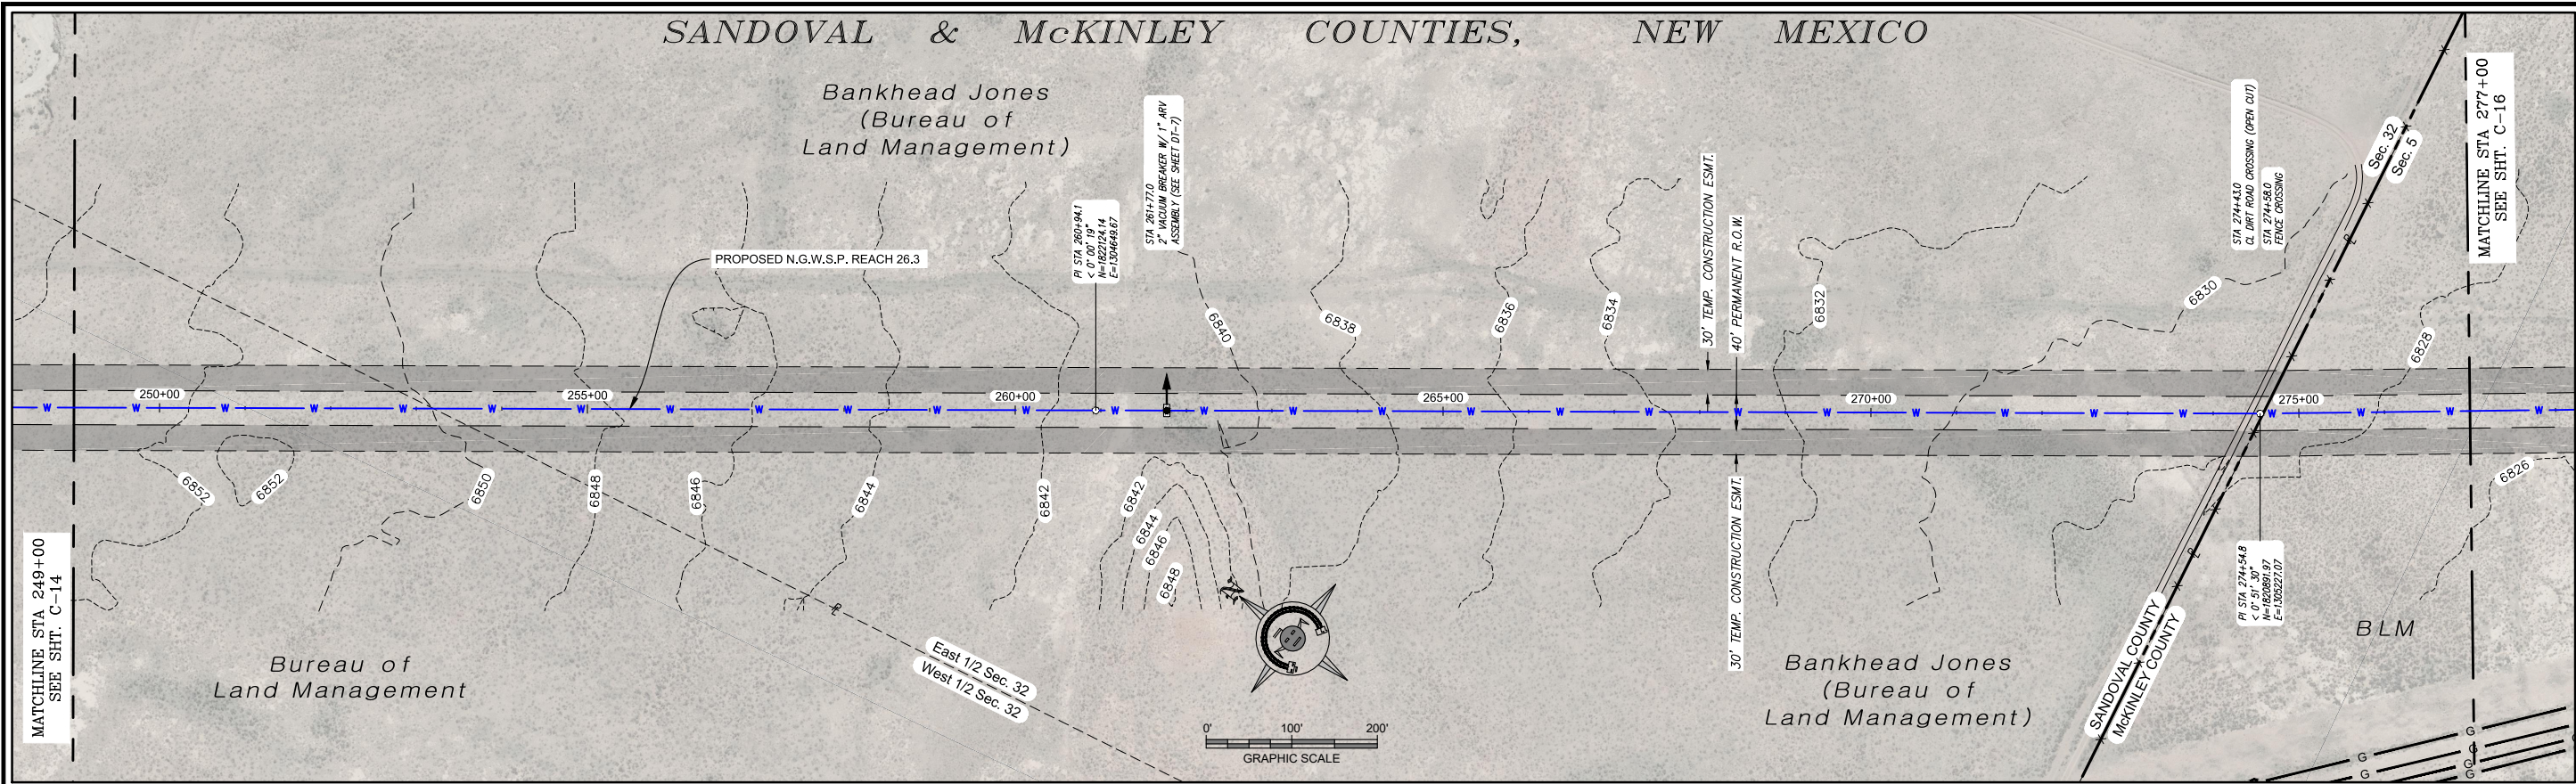

PLAN VIEW
12" WATERLINE

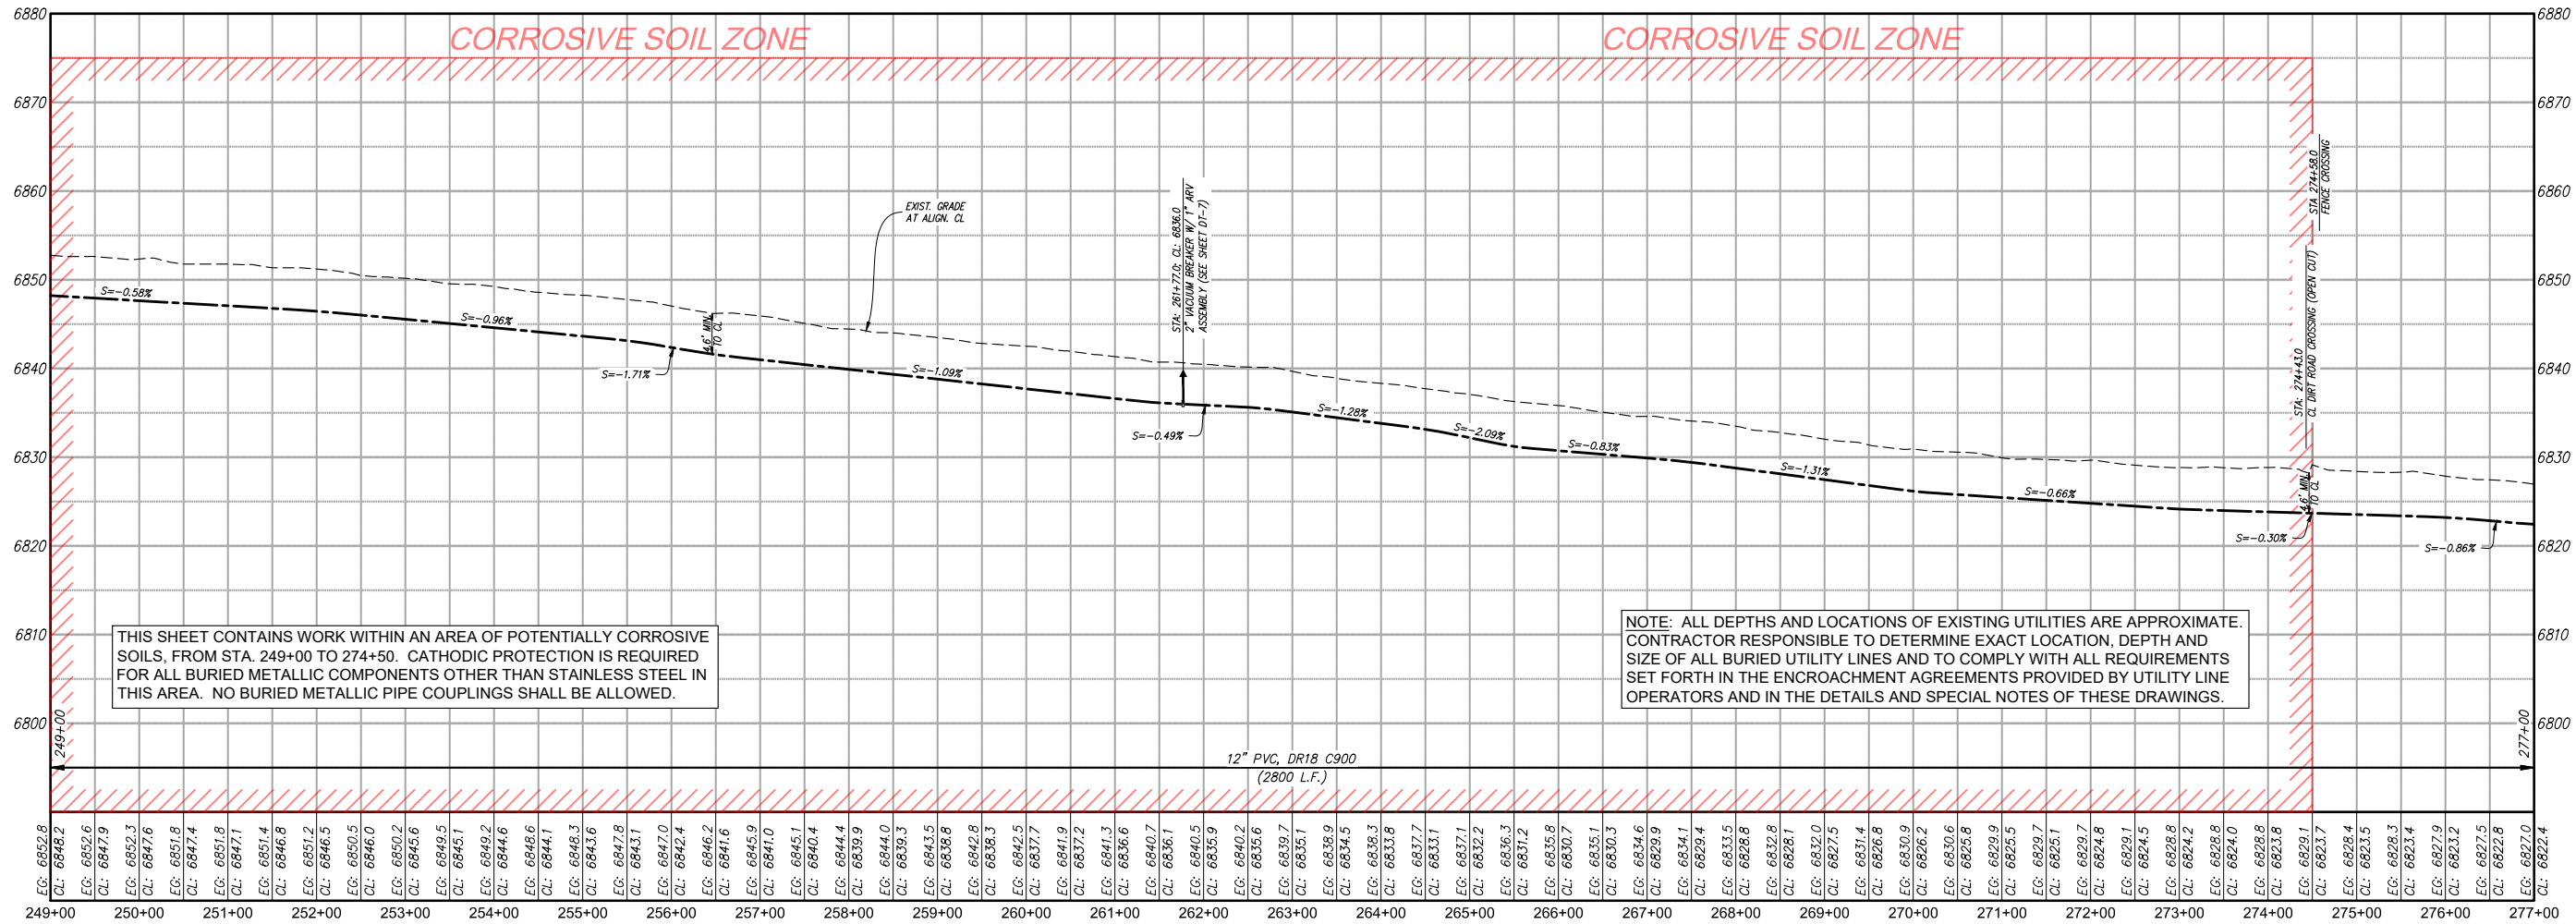

PROFILE VIEW
12" WATERLINE

Revision	Date	Description	By	CHK'd

SMA
SOUDEUR, MILLER & ASSOCIATES
5454 VENCE AVENUE NE, SUITE D
ALBUQUERQUE, NM 87113
Phone (505) 299-0942 Toll-Free (877) 299-0942 Fax (505) 293-3430
www.soudermiller.com
Serving the Southwest & Rocky Mountains
Albuquerque, Carlsbad, Hobbs, Farmington, Las Cruces, Roswell, Santa Fe, NM
Conter, Grand Junction, CO - Safford, AZ - Moab, UT - El Paso, TX
9272918 4:58:34 PM axv

CLIENT: The Navajo Nation
TOWN: Reach 26.3 To Tarron, NM
PLAN & PROFILE STA 249+00 To STA 277+00
SECTION 32, T. 21 N., R. 5 W. & SECTION 5, T. 20 N., R. 5 W.
NAVAJO GALLUP WATER SUPPLY
PROJECT - REACH 26.3
SANDOVAL & MCKINLEY COUNTIES, NEW MEXICO

Designed TTT	Drawn MTH/AAV	Checked AGR
-----------------	------------------	----------------

90% REVIEW
DRAFT


PRELIMINARY
NOT FOR CONSTRUCTION

THIS DRAWING IS INCOMPLETE
AND NOT TO BE USED FOR
CONSTRUCTION UNLESS IT IS
STAMPED, SIGNED AND DATED

NOTICE OF EXTENDED
PAYMENT PROVISION:
THIS CONTRACT ALLOWS THE
OWNER TO MAKE PAYMENT
WITHIN 45 DAYS AFTER
SUBMISSION OF
AN UNDISPUTED REQUEST
FOR PAYMENT.


811 Know what's
below.
Call before
you dig.

Date: September 27, 2018
Scale: Horiz: 1" = 200'
Vert: 1" = 20'
Project No: 6921307
Sheet: C-15

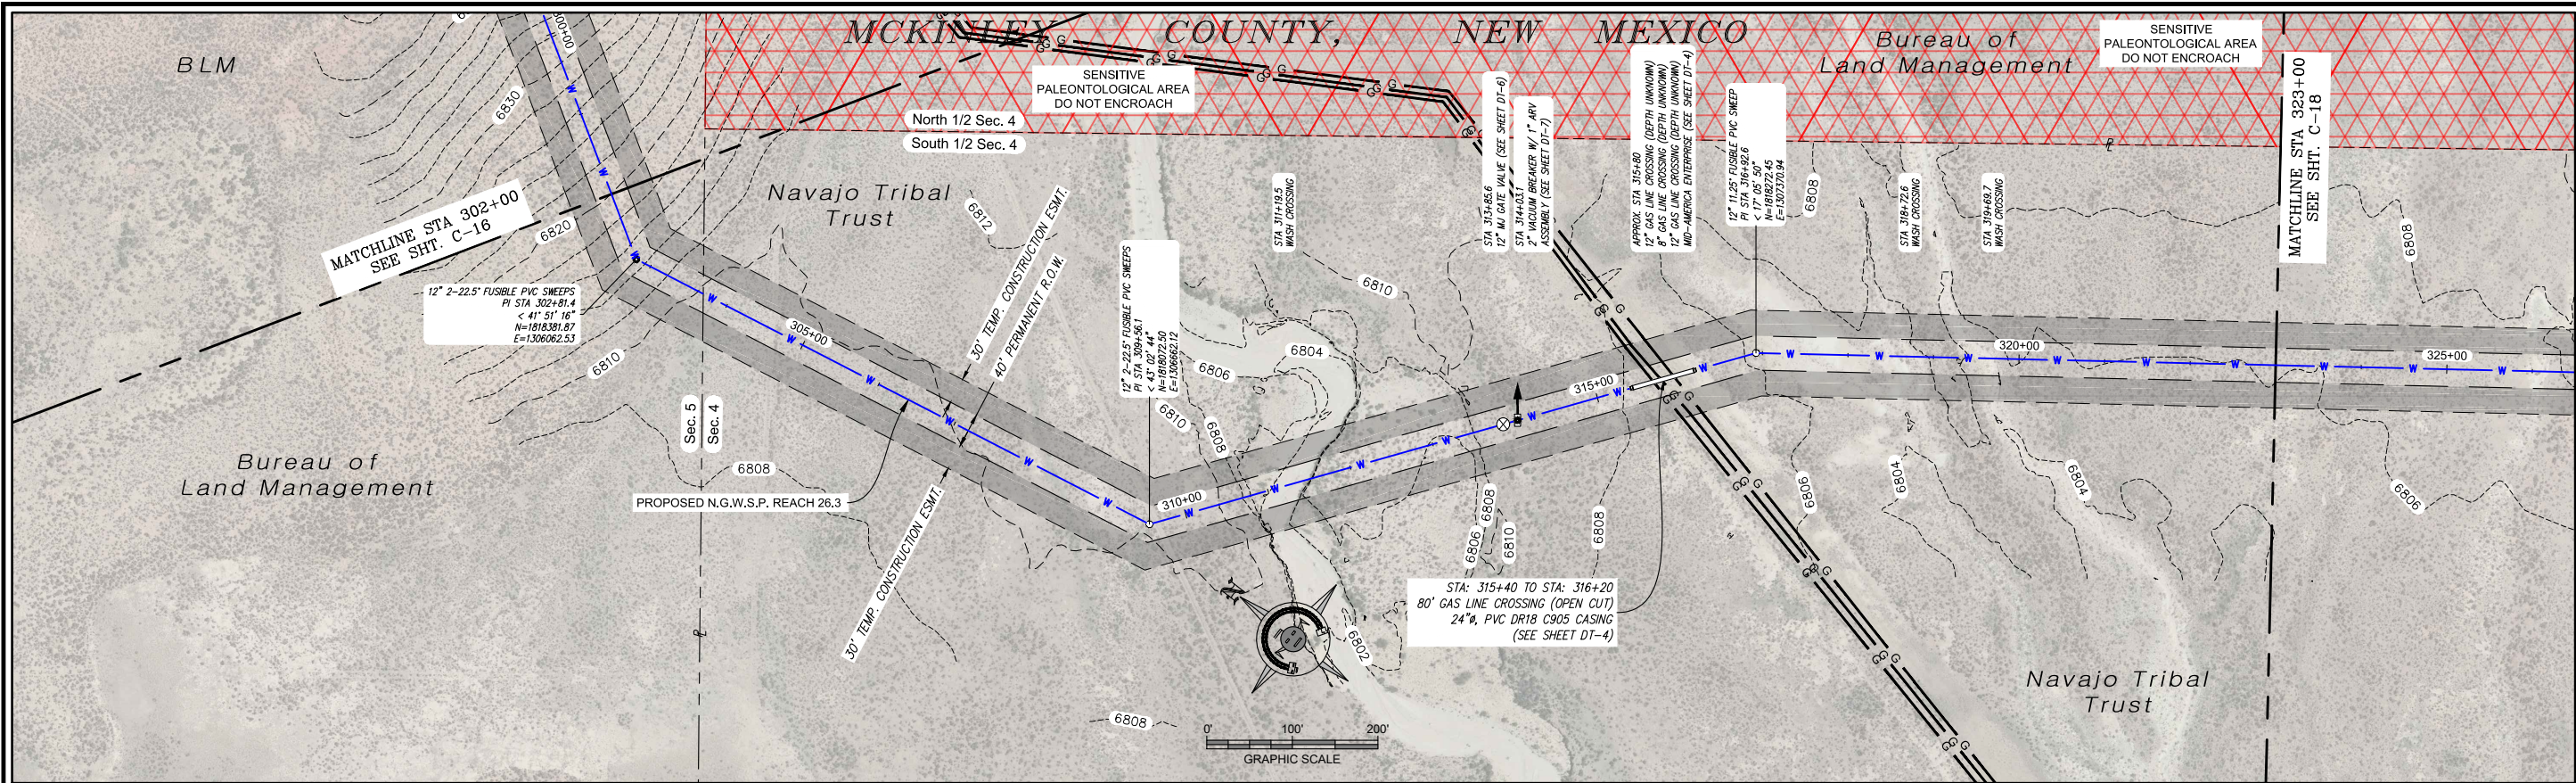

PLAN VIEW
12" WATERLINE

NOTE: ALL DEPTHS AND LOCATIONS OF EXISTING UTILITIES ARE APPROXIMATE. CONTRACTOR RESPONSIBLE TO DETERMINE EXACT LOCATION, DEPTH AND SIZE OF ALL BURIED UTILITY LINES AND TO COMPLY WITH ALL REQUIREMENTS SET FORTH IN THE ENCROACHMENT AGREEMENTS PROVIDED BY UTILITY LINE OPERATORS AND IN THE DETAILS AND SPECIAL NOTES OF THESE DRAWINGS.

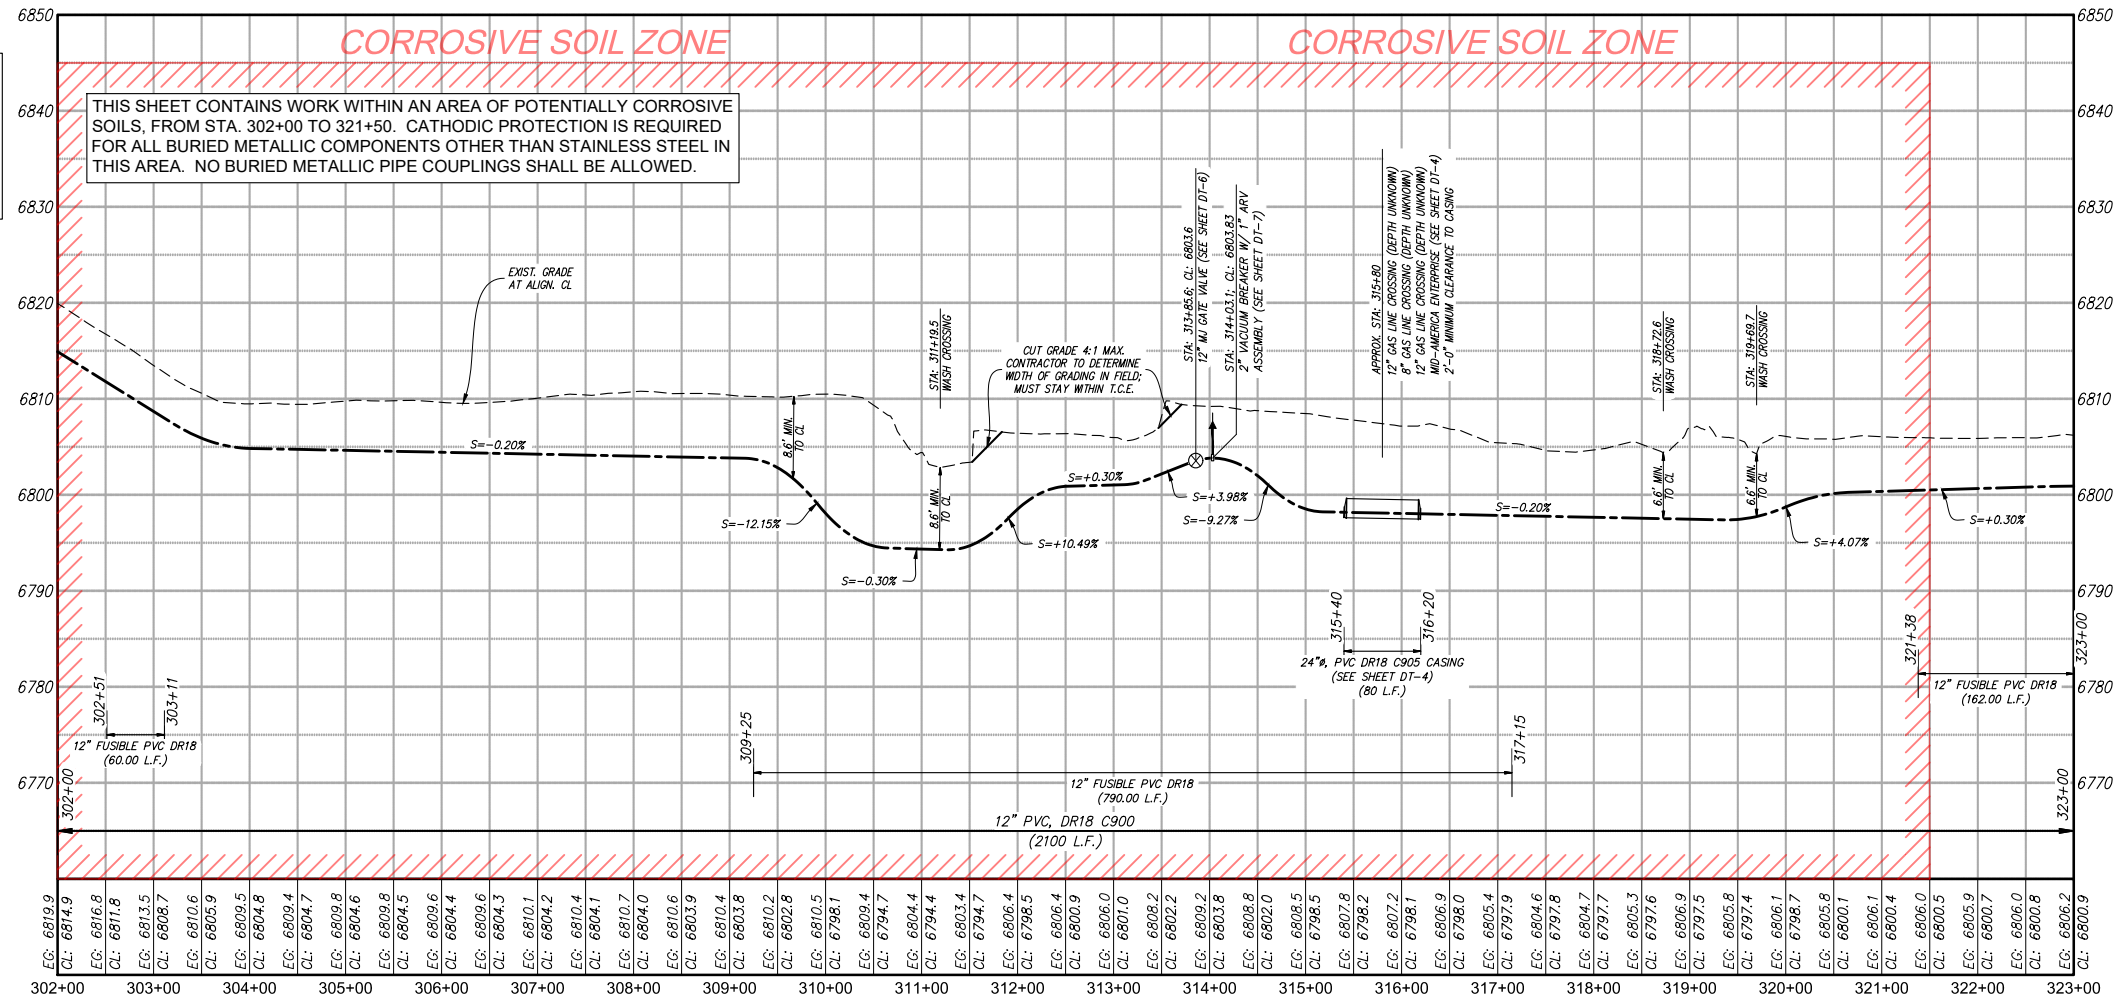

PROFILE VIEW
12" WATERLINE

Revision	Date	Description	By	CHK'd

SMA
Engineering & Environmental
Surveying

SOUDER, MILLER & ASSOCIATES
5454 VENCE AVENUE NE, SUITE D
ALBUQUERQUE, NM 87113
Phone (505) 299-0942 Toll-Free (877) 299-0942 Fax (505) 293-3430
www.soudermiller.com
Serving the Southwest & Rocky Mountains
Albuquerque, Carlsbad, Hobbs, Farmington, Las Cruces, Roswell, Santa Fe, NM
Concepcion, Grand Junction, CO - Safford, AZ - Moab, UT - El Paso, TX

CLIENT: The Navajo Nation
TOWN: Reach 26.3 To Tarron, NM
PLAN & PROFILE STA 302+00 To STA 323+00
SECTIONS 4 & 5, T. 20 N., R. 5 W.
NAVAJO GALLUP WATER SUPPLY
PROJECT - REACH 26.3
SANDOVAL & MCKINLEY COUNTIES, NEW MEXICO

Designed	Drawn	Checked
TTT	MVA/AG	AGR

90% REVIEW
DRAFT

PRELIMINARY
NOT FOR CONSTRUCTION

THIS DRAWING IS INCOMPLETE
AND NOT TO BE USED FOR
CONSTRUCTION UNLESS IT IS
STAMPED, SIGNED AND DATED

**NOTICE OF EXTENDED
PAYMENT PROVISION:**
THIS CONTRACT ALLOWS THE
OWNER TO MAKE PAYMENT
WITHIN 45 DAYS AFTER
SUBMISSION OF
AN UNDISPUTED REQUEST
FOR PAYMENT.

811 Know what's
below.
Call before
you dig.

Date: October 22, 2018

Scale: Horiz: 1" = 200'
Vert: 1" = 20'


Project No: 6921307

Sheet: **C-17**


McKINLEY COUNTY, NEW MEXICO

Bureau of
Land Management

Bureau of
Land Management

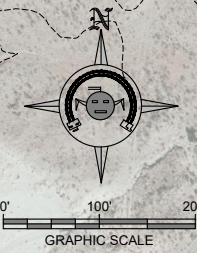

PLAN VIEW
12" WATERLINE

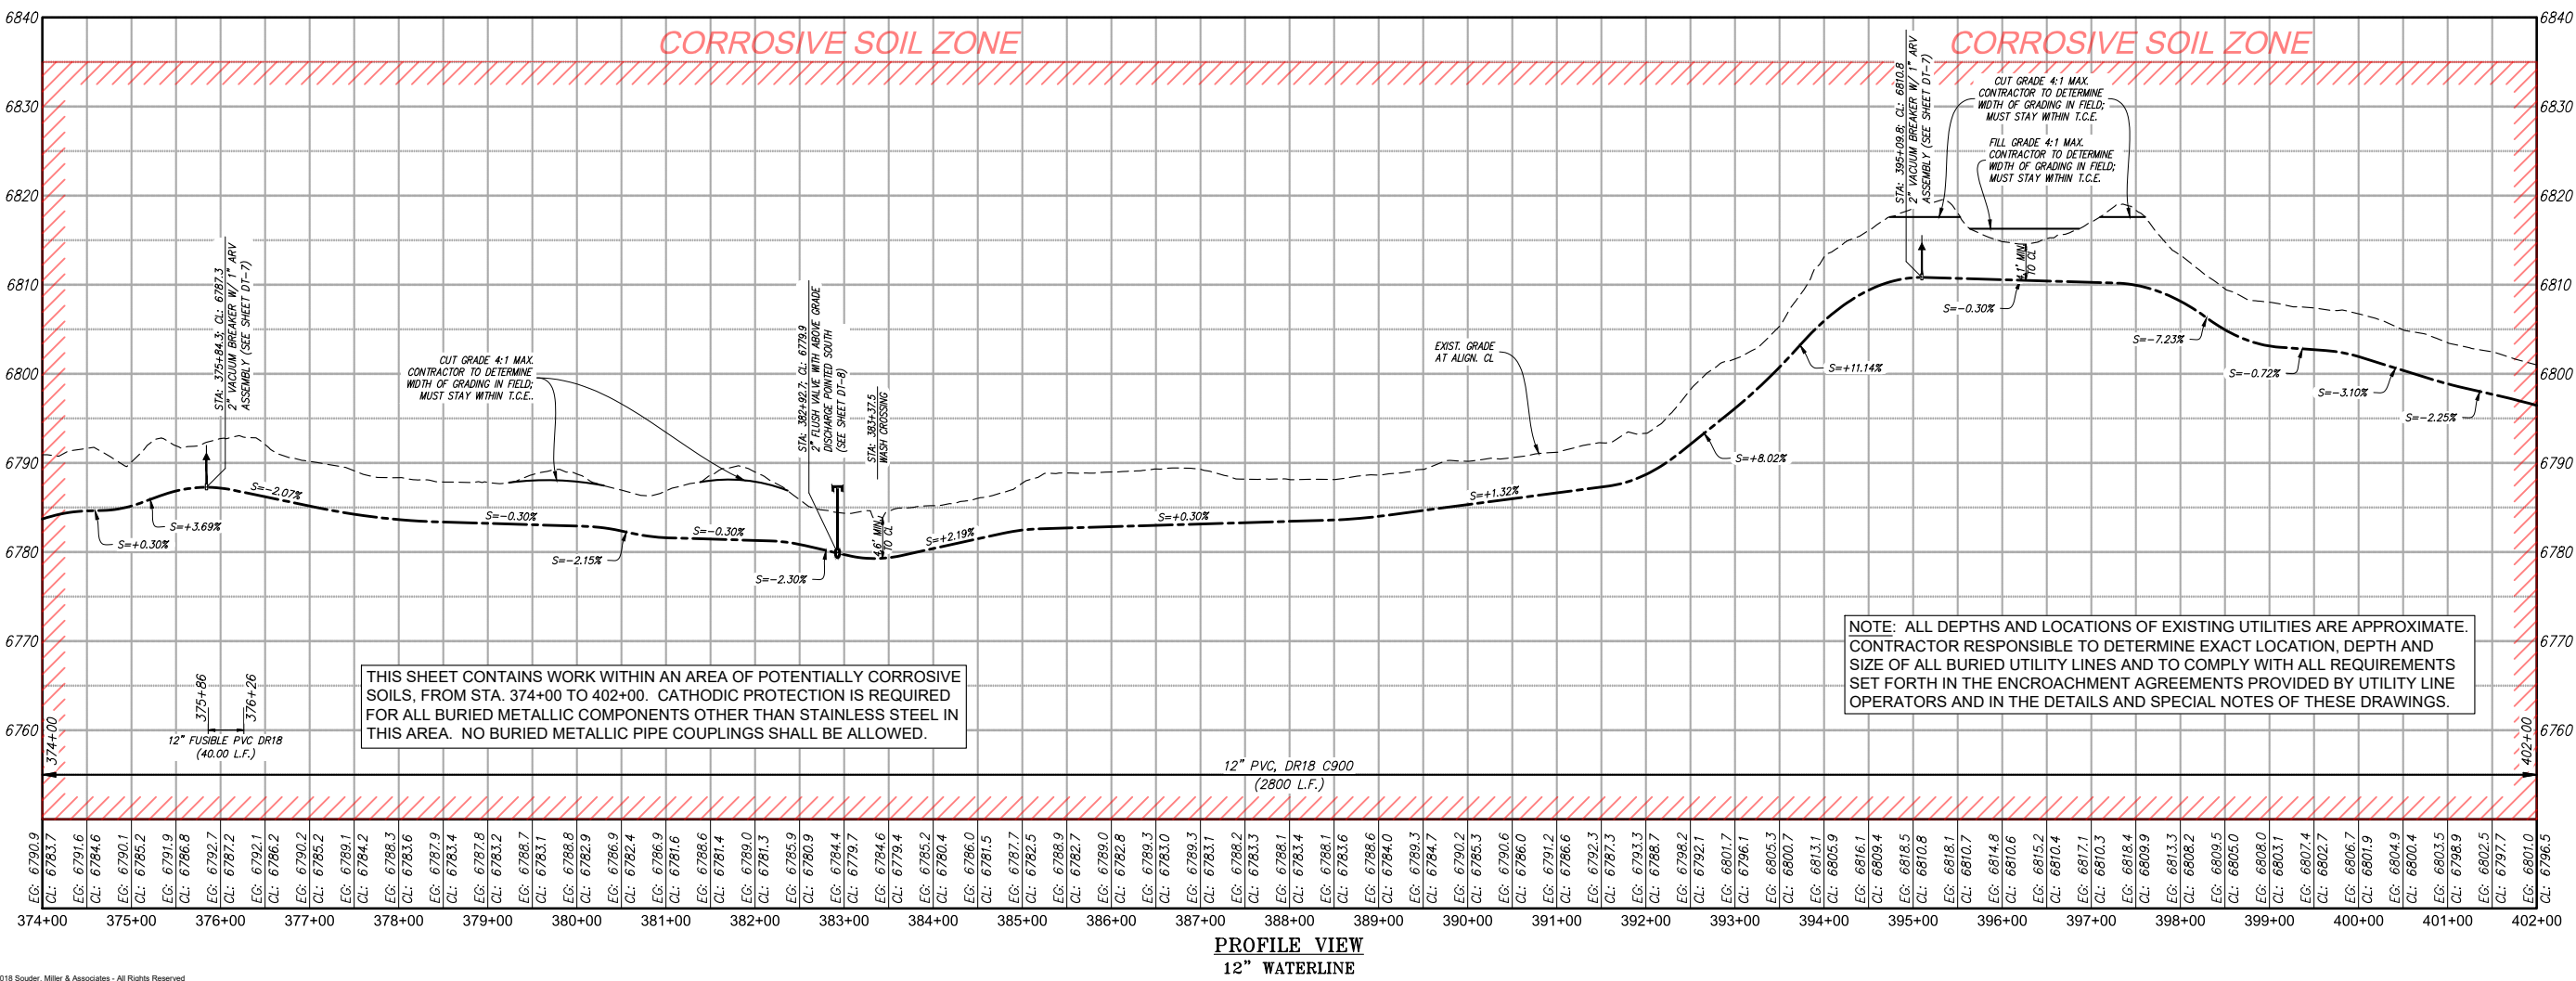

Revision	Date	Description	By	CHK'd

SMA
SOUDER, MILLER & ASSOCIATES
5454 VENCE AVENUE NE, SUITE D
ALBUQUERQUE, NM 87113
Phone (505) 299-0942 Toll-Free (877) 299-0942 Fax (505) 293-3430
www.soudermiller.com
Serving the Southwest & Rocky Mountains
Albuquerque, Carlsbad, Hobbs, Farmington, Las Cruces, Roswell, Santa Fe, NM
Concepcion, Grand Junction, CO - Safford, AZ - Moab, UT - El Paso, TX
9272918 515 4459410

CLIENT: The Navajo Nation TOWN: Reach 26.3 To Tarron, NM
PLAN & PROFILE STA 374+00 TO STA 402+00
SECTION 3, T. 20 N., R. 5 W.
NAVAJO GALLUP WATER SUPPLY
PROJECT - REACH 26.3
SANDOVAL & MCKINLEY COUNTIES, NEW MEXICO

Designed	Drawn	Checked
TTT	MW/AAV	AGR

90% REVIEW
DRAFT

PRELIMINARY
NOT FOR CONSTRUCTION

THIS DRAWING IS INCOMPLETE AND NOT TO BE USED FOR CONSTRUCTION UNLESS IT IS STAMPED, SIGNED AND DATED.

NOTICE OF EXTENDED PAYMENT PROVISION:
THIS CONTRACTOR AGREES TO ALLOW THE OWNER TO MAKE PAYMENT WITHIN 45 DAYS AFTER SUBMISSION OF AN UNDISPUTED REQUEST FOR PAYMENT.


811 Know what's below. Call before you dig.

Date: September 27, 2018


Scale: Horiz: 1" = 200'
Vert: 1" = 20'

Project No: 6921307

Sheet: C-20

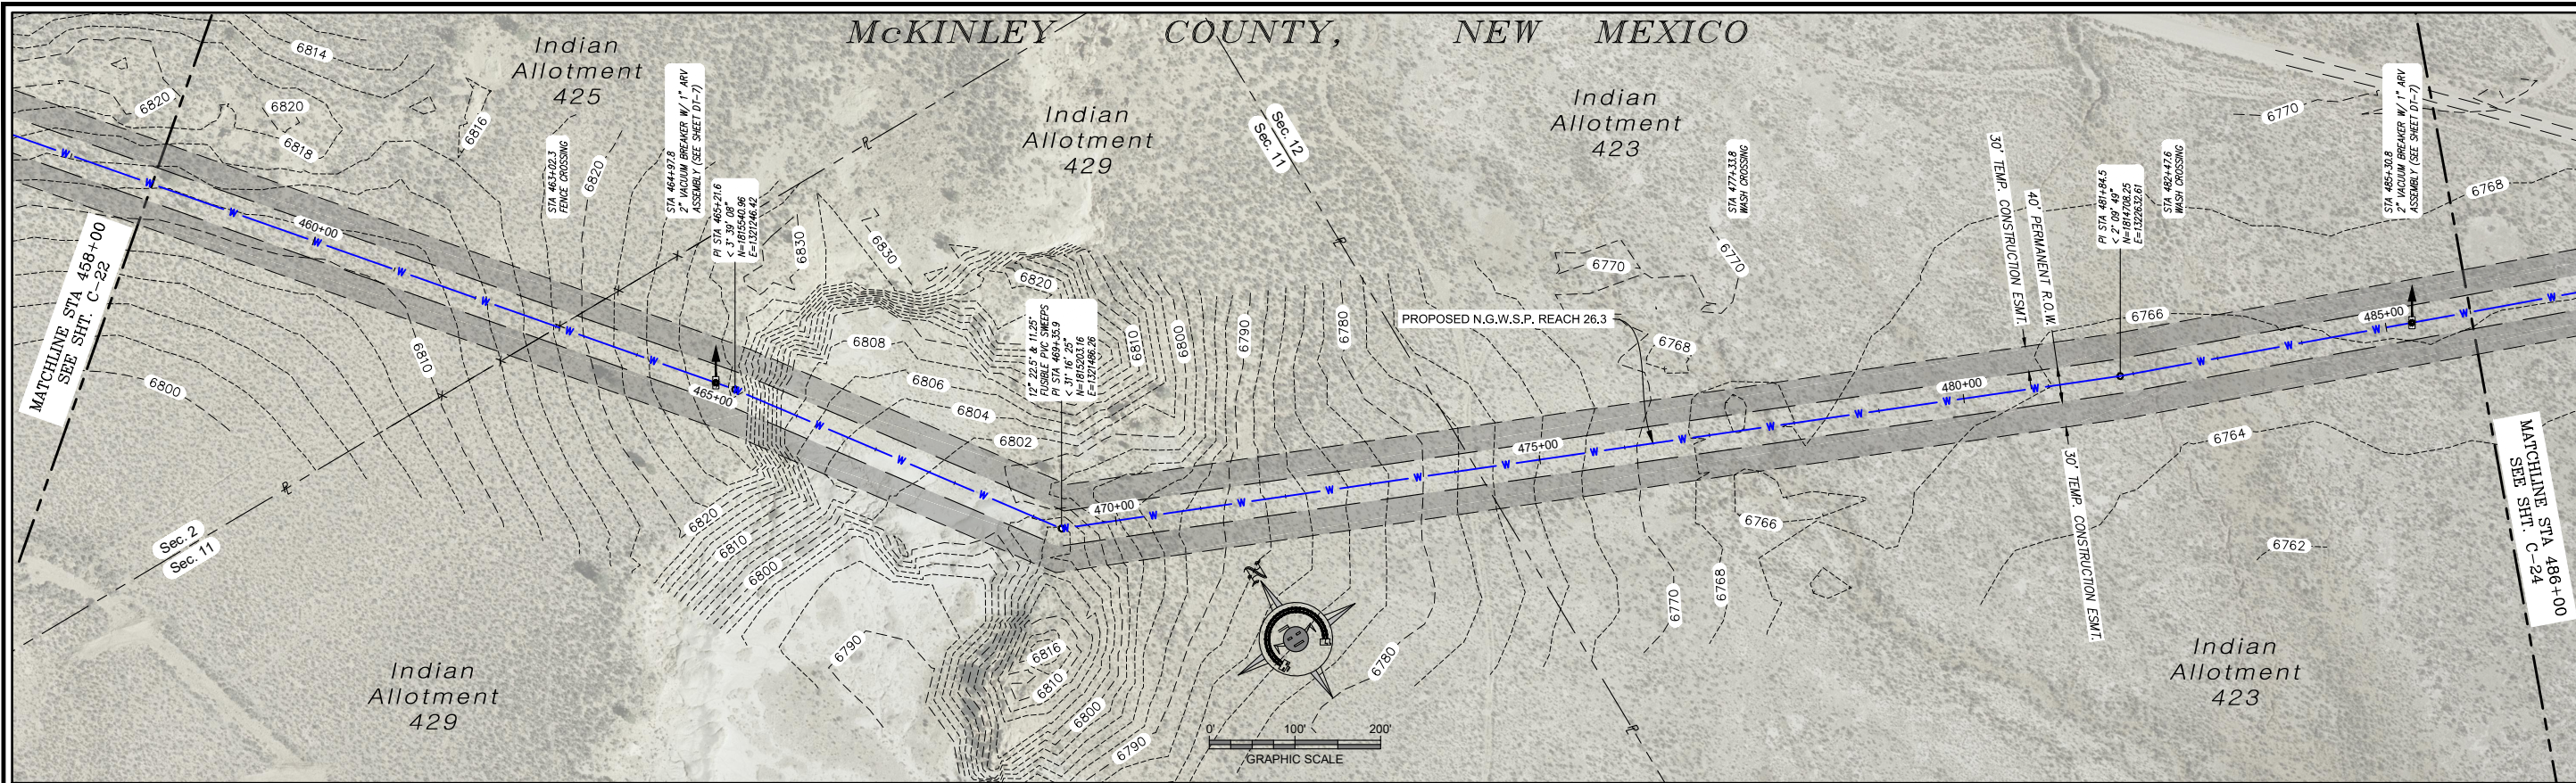

PLAN VIEW
12" WATERLINE

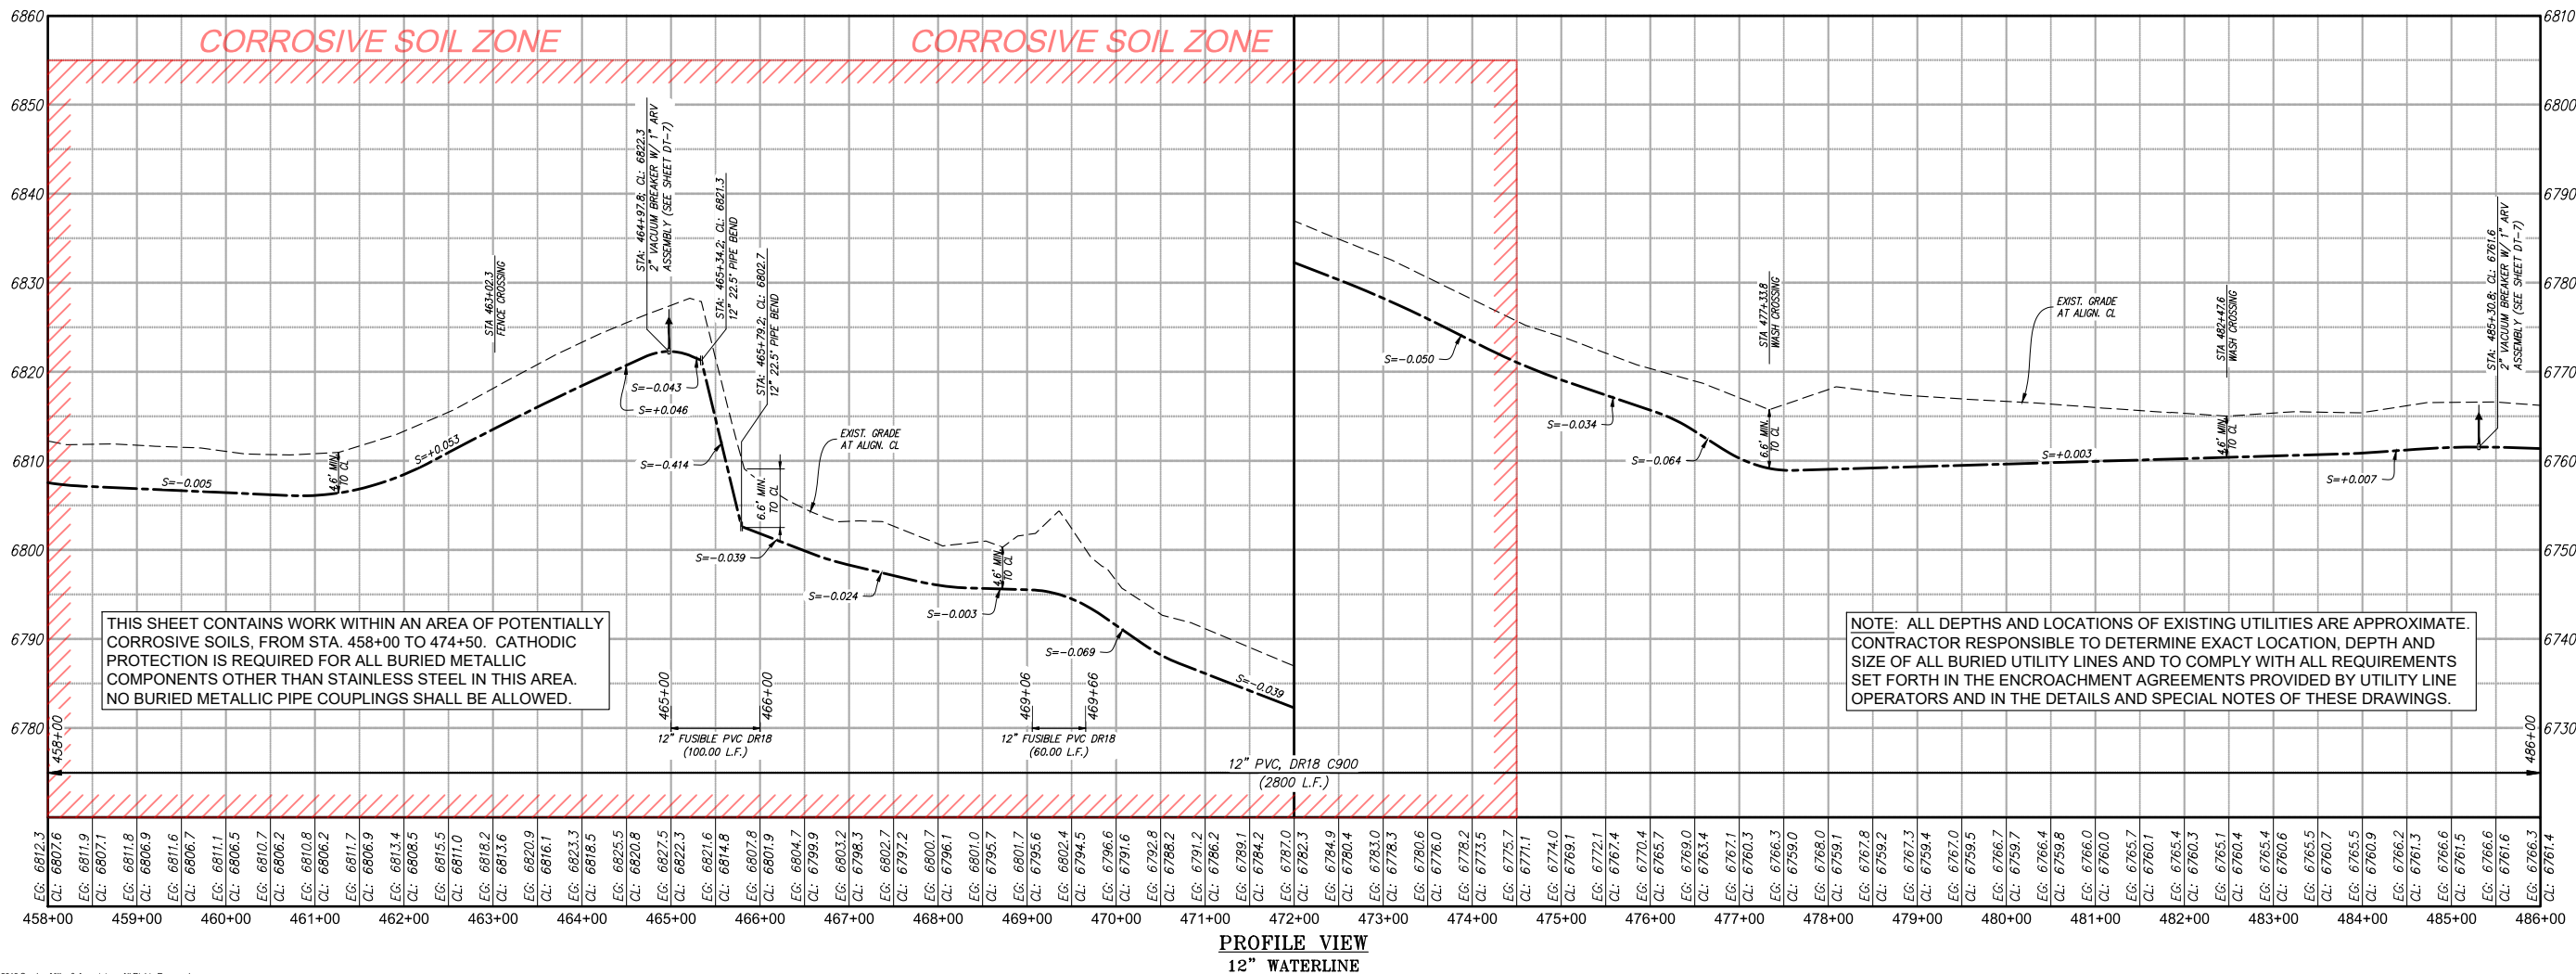

PROFILE VIEW
12" WATERLINE

Revision	Date	Description	By	CHK'd

SMA
Souder, Miller & Associates
5454 VENCE AVENUE NE, SUITE D
ALBUQUERQUE, NM 87113
Phone (505) 299-0942 Toll-Free (877) 299-0942 Fax (505) 293-3430
www.soudermiller.com
Serving the Southwest & Rocky Mountains
Albuquerque, Carlsbad, Hobbs, Farmington, Las Cruces, Roswell, Santa Fe, NM
Conter, Grand Junction, CO - Safford, AZ - Moab, UT - El Paso, TX

CLIENT: The Navajo Nation
TOWN: Reach 26.3 To Tarron, NM
PLAN & PROFILE STA 458+00 TO STA 486+00
SECTIONS 2, 11 & 12, T. 20 N., R. 5 W.
NAVAJO GALLUP WATER SUPPLY
PROJECT - REACH 26.3
SANDOVAL & MCKINLEY COUNTIES, NEW MEXICO

Designed	Drawn	Checked
TTT	MW/AAV	AGR

90% REVIEW
DRAFT

PRELIMINARY
NOT FOR CONSTRUCTION

THIS DRAWING IS INCOMPLETE
AND NOT TO BE USED FOR
CONSTRUCTION UNLESS IT IS
STAMPED, SIGNED AND DATED

**NOTICE OF EXTENDED
PAYMENT PROVISION:**
THIS CONTRACT ALLOWS THE
OWNER TO MAKE PAYMENT
WITHIN 45 DAYS AFTER
SUBMISSION OF
AN UNDISPUTED REQUEST
FOR PAYMENT.



811 Know what's
below.
Call before
you dig.

Date: September 27, 2018

Scale: Horiz: 1" = 200'
Vert: 1" = 20'

Project No: 6921307

Sheet: C-23

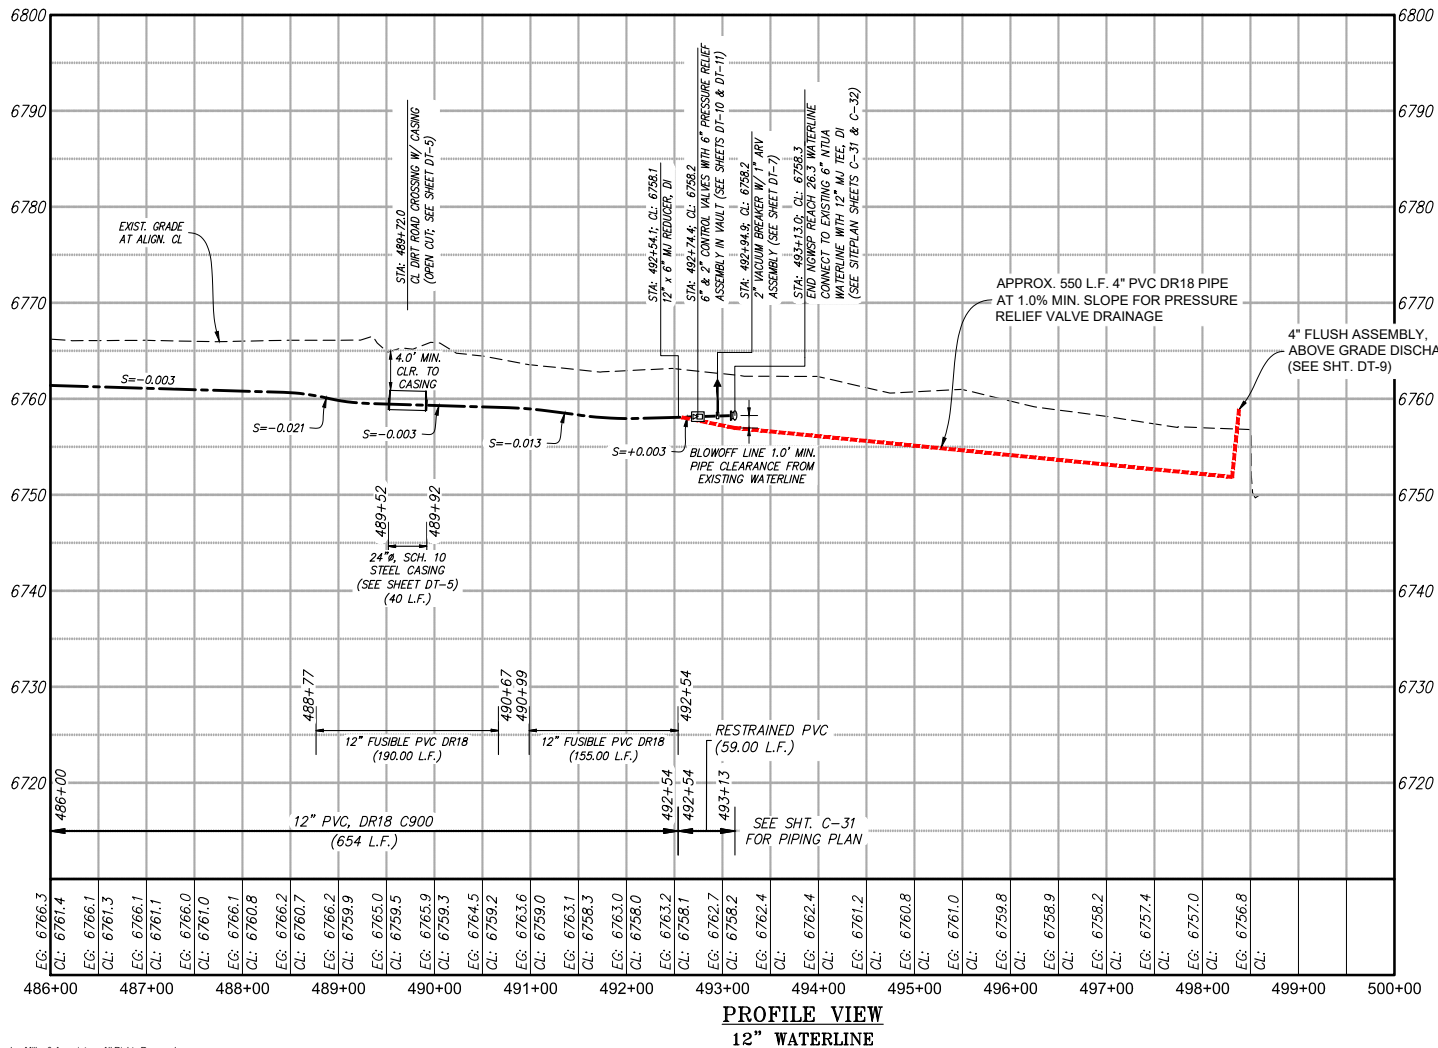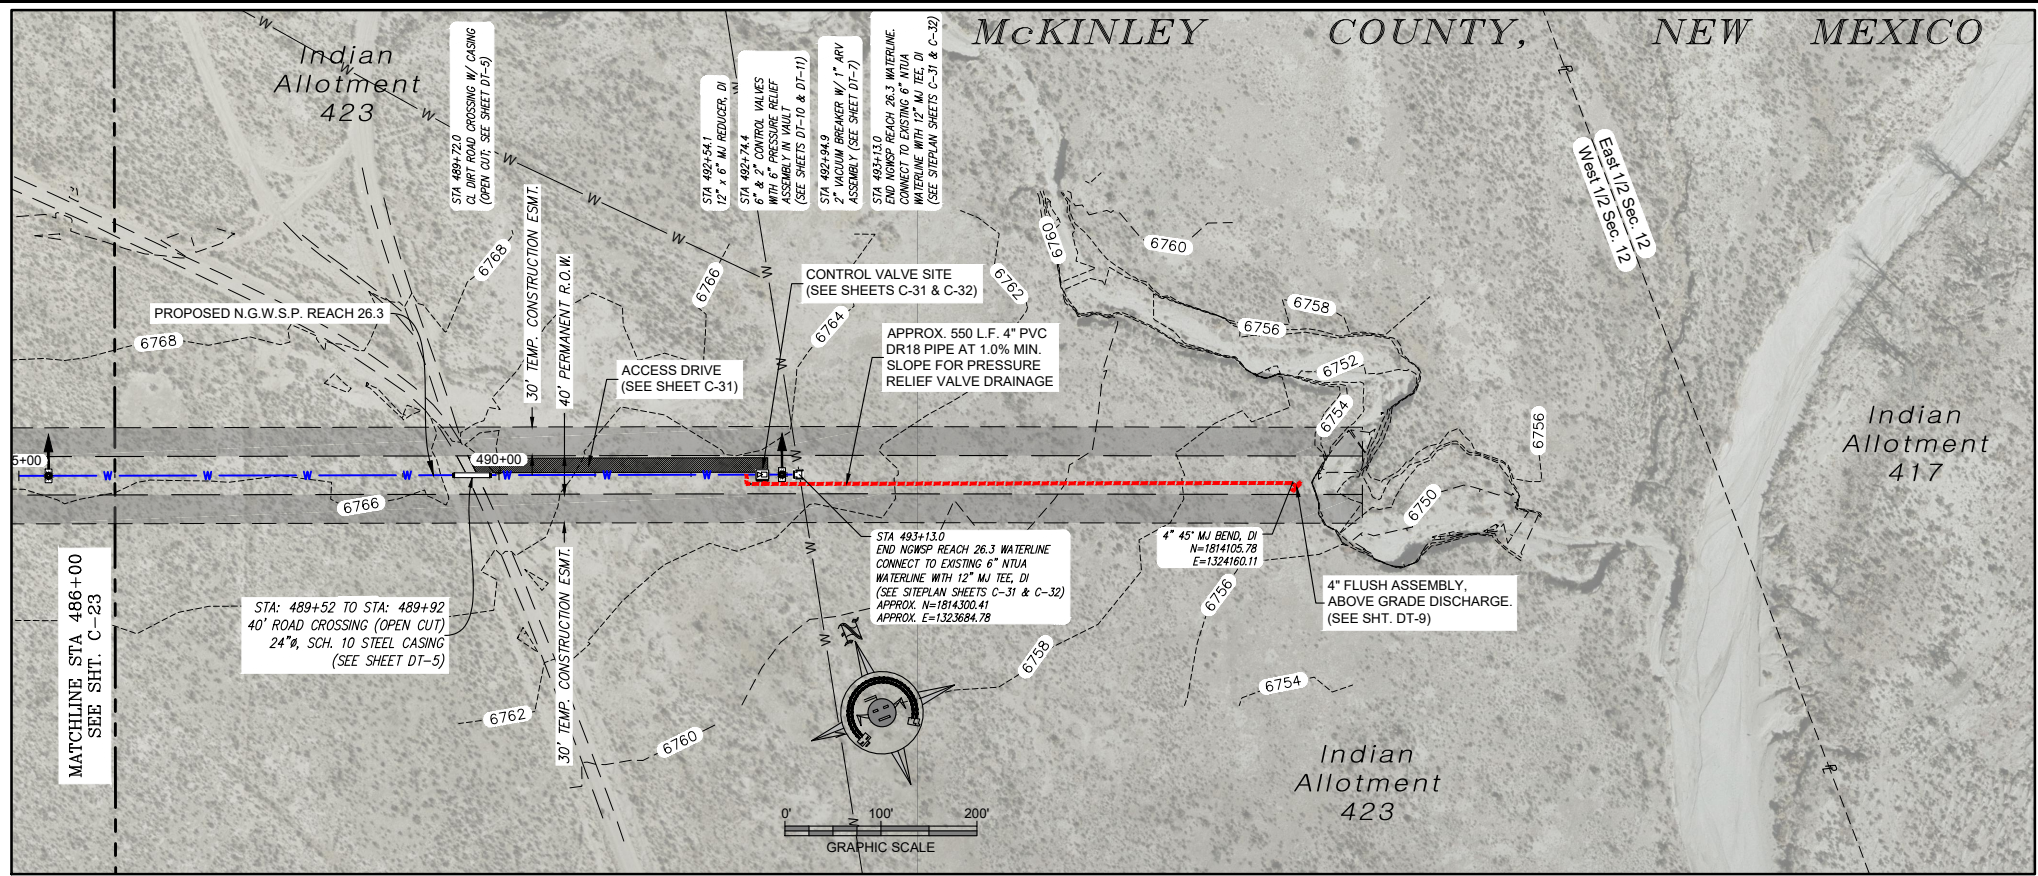

NOTE: ALL DEPTHS AND LOCATIONS OF EXISTING UTILITIES ARE APPROXIMATE. CONTRACTOR RESPONSIBLE TO DETERMINE EXACT LOCATION, DEPTH AND SIZE OF ALL BURIED UTILITY LINES AND TO COMPLY WITH ALL REQUIREMENTS SET FORTH IN THE ENCROACHMENT AGREEMENTS PROVIDED BY UTILITY LINE OPERATORS AND IN THE DETAILS AND SPECIAL NOTES OF THESE DRAWINGS.

Revision	Date	Description	By	CHK'd

SMA
Souder, Miller & Associates
5454 VENCE AVENUE NE, SUITE D
ALBUQUERQUE, NM 87113
Phone (505) 299-0942 Toll-Free (877) 299-0942 Fax (505) 293-3430
www.soudermiller.com
Serving the Southwest & Rocky Mountains
Albuquerque, Carlsbad, Hobbs, Farmington, Las Cruces, Roswell, Santa Fe, NM
Cortez, Grand Junction, CO - Safford, AZ - Moab, UT - El Paso, TX

CLIENT: The Navajo Nation TOWN: Reach 26.3 To Tarron, NM
PLAN & PROFILE STA 486+00 To STA 493+12.9
SECTION 12, T. 20 N., R. 5 W.
NAVAJO GALLUP WATER SUPPLY
PROJECT - REACH 26.3
SANDOVAL & MCKINLEY COUNTIES, NEW MEXICO

Designed TTT	Drawn MVA/AG	Checked AGR
-----------------	-----------------	----------------

90% REVIEW
DRAFT

PRELIMINARY
NOT FOR CONSTRUCTION

THIS DRAWING IS INCOMPLETE AND NOT TO BE USED FOR CONSTRUCTION UNLESS IT IS STAMPED, SIGNED AND DATED

NOTICE OF EXTENDED PAYMENT PROVISION:
THIS CONTRACT ALLOWS THE OWNER TO MAKE PAYMENT WITHIN 45 DAYS AFTER SUBMISSION OF AN UNDISPUTED REQUEST FOR PAYMENT.

811 Know what's below. Call before you dig.


Date: September 27, 2018
Scale: Horiz: 1" = 200'
Vert: 1" = 20'
Project No: 6921307
Sheet: C-24

LEGEND

- 2" GRAVEL OVER 3" NMDOT SPECIFICATION BASE COURSE
- SENSITIVE PALEONTOLOGICAL AREA. DO NOT ENCROACH.
- TEMPORARY CONSTRUCTION EASEMENT
- ACCESS DRIVEWAY

SANDOVAL COUNTY, NEW MEXICO
SEC-29, T-21-N, R-5-W
BUREAU OF LAND MANAGEMENT

Bankhead Jones
(Bureau of Land Management)

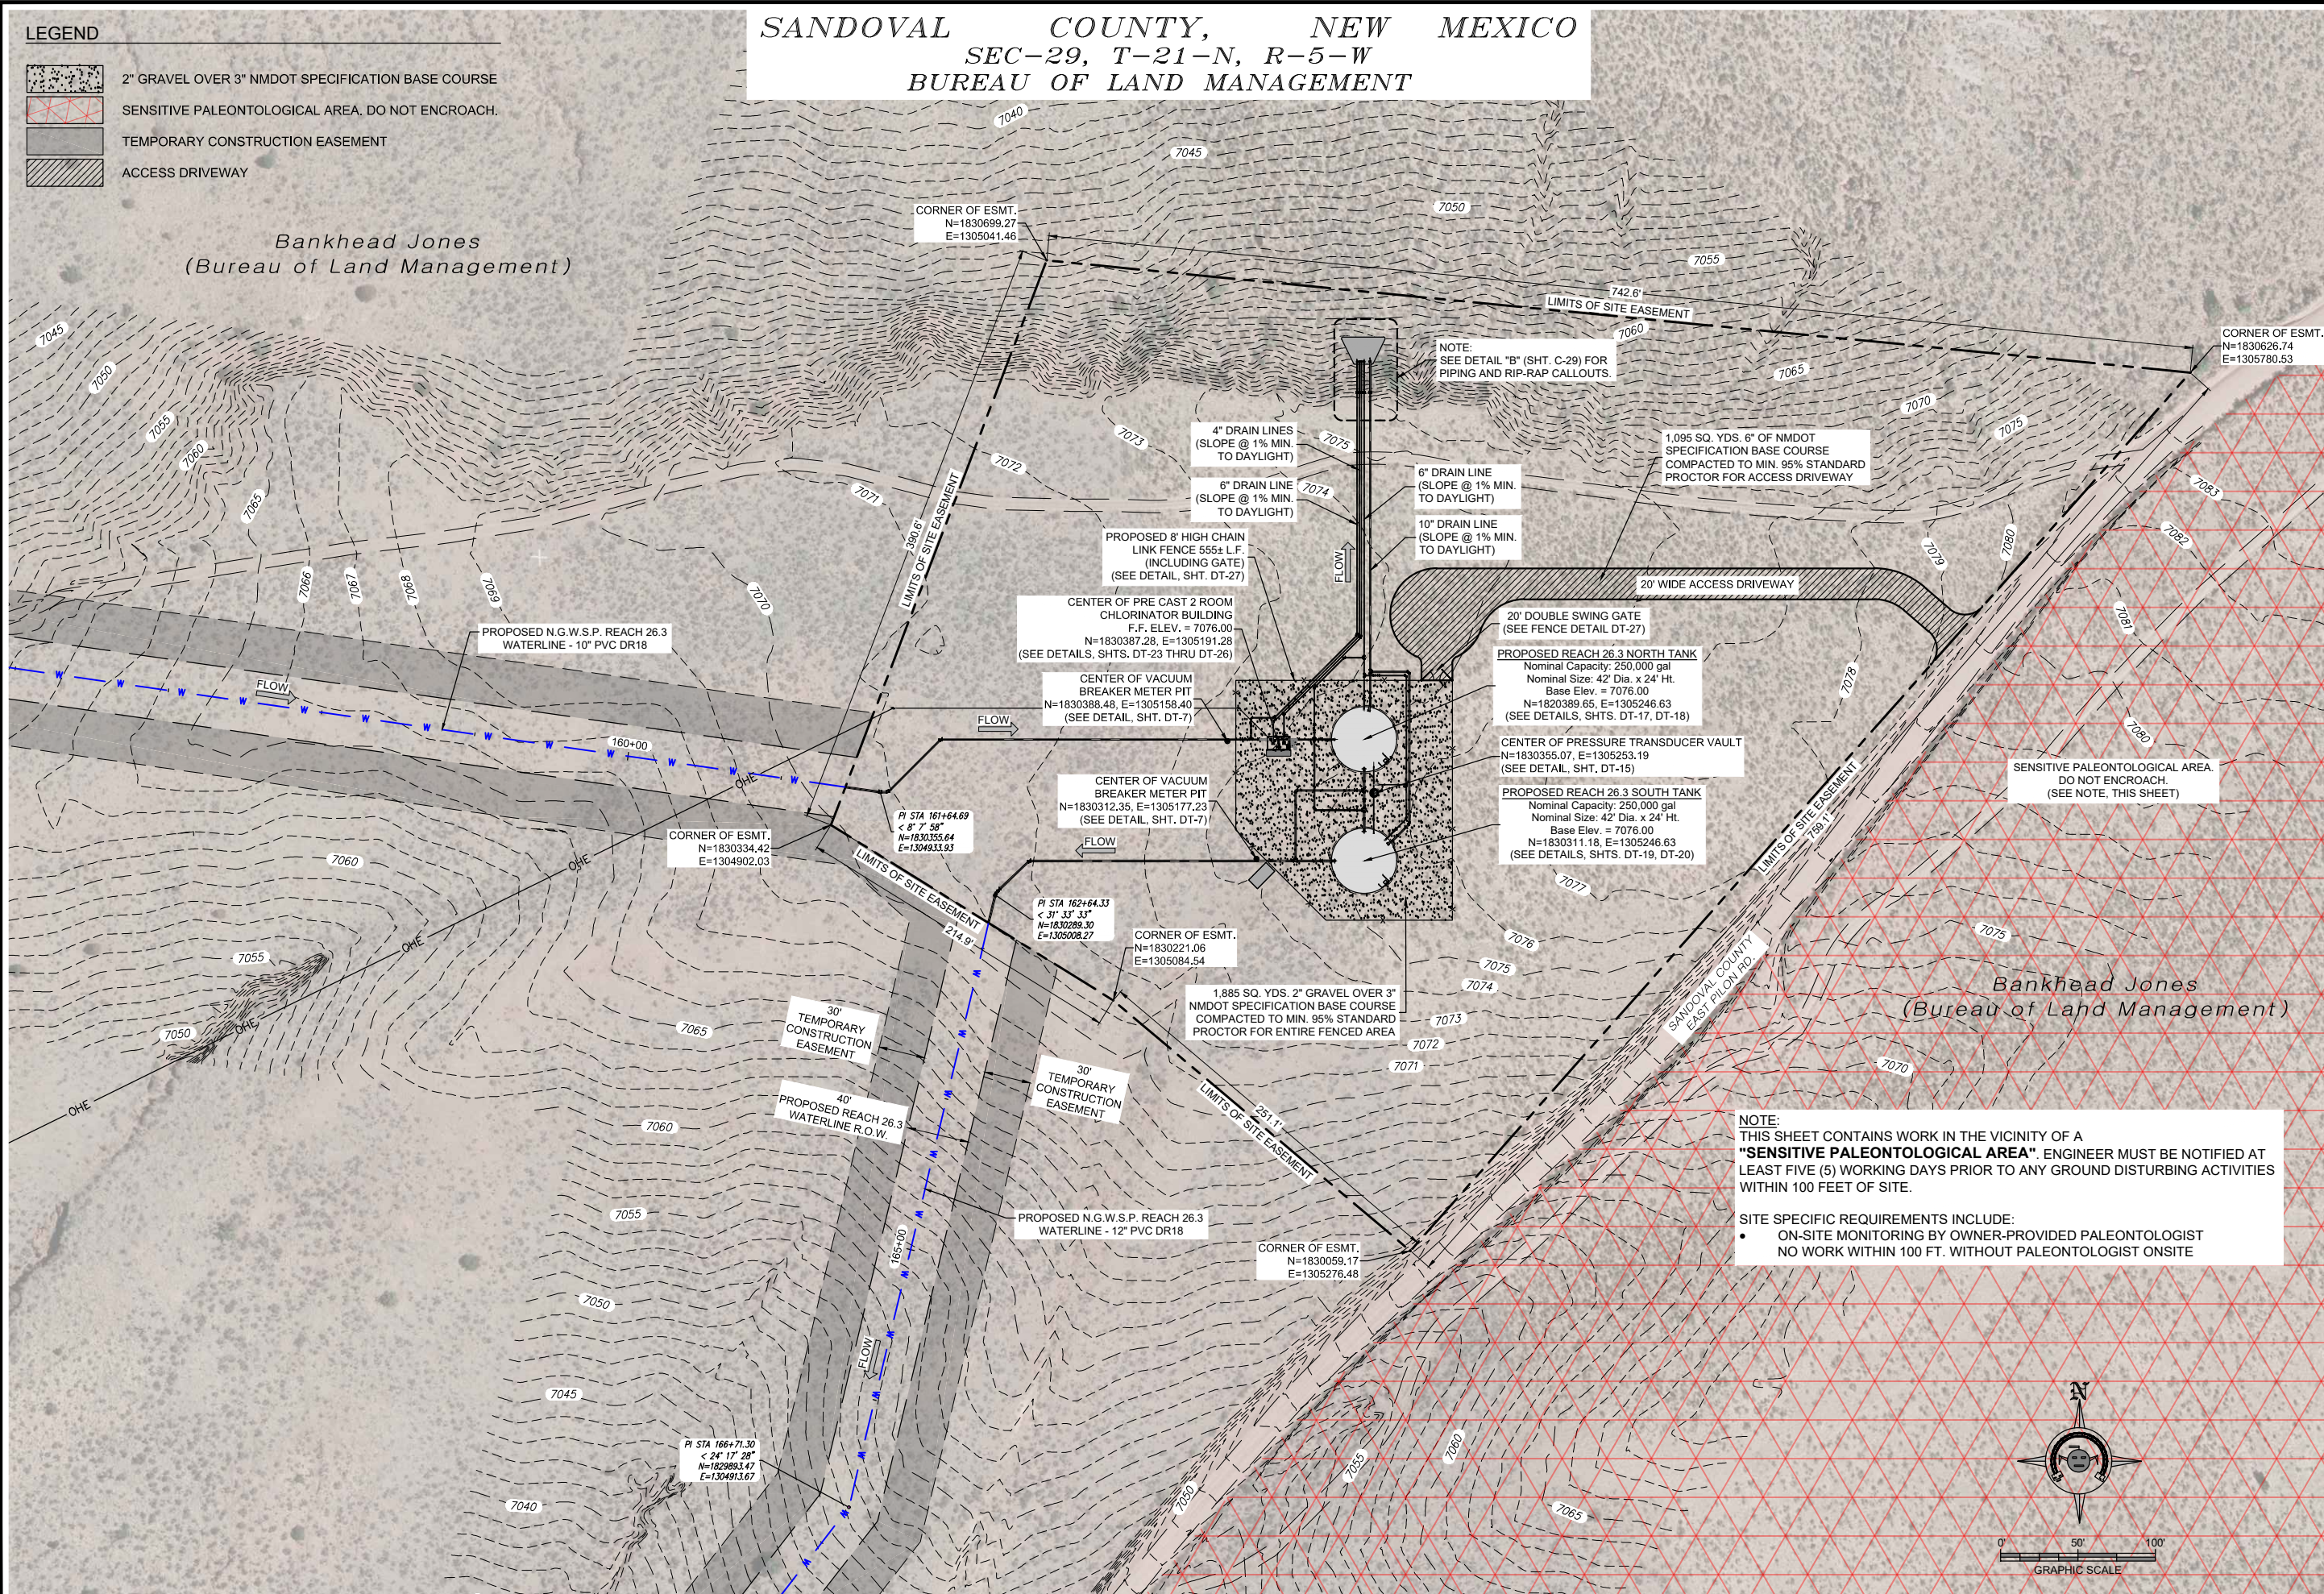

Revision	Date	Description	By	CHK'd

SMA
Souder, Miller & Associates
5454 VINCE AVENUE NE, SUITE D
ALBUQUERQUE, NM 87113
Phone (505) 299-0942 Toll-Free (877) 299-0942 Fax (505) 293-3430
www.soudermiller.com
Serving the Southwest & Rocky Mountains
Albuquerque, Carlsbad, Hobbs, Farmington, Las Cruces, Roswell, Santa Fe, NM
Cortez, Grand Junction, CO - Safford, AZ - Moab, UT - El Paso, TX

CLIENT: The Navajo Nation
TOWN: Reach 26.3 To Tonnore, NM
REACH 26.3 TANK SITE OVERALL PLAN
SECTION 29, T. 21 N., R. 5 W.
NAVAJO GALLUP WATER SUPPLY
PROJECT - REACH 26.3
SANDOVAL & MCKINLEY COUNTIES, NEW MEXICO

Designed TTT	Drawn MWT/AAV	Checked AGR
-----------------	------------------	----------------

90% REVIEW
DRAFT

PRELIMINARY
NOT FOR CONSTRUCTION

THIS DRAWING IS INCOMPLETE
AND NOT TO BE USED FOR
CONSTRUCTION UNLESS IT IS
STAMPED, SIGNED AND DATED

NOTICE OF EXTENDED
PAYMENT PROVISION:
THIS CONTRACT ALLOWS THE
OWNER TO MAKE PAYMENT
WITHIN 45 DAYS AFTER
SUBMISSION OF
AN UNDISPUTED REQUEST
FOR PAYMENT.

811 Know what's
below.
Call before
you dig.

Date: September 27, 2018

Scale: Horiz: 1" = 100'


Project No: 6921307

Sheet: C-25

LEGEND


- 2" GRAVEL OVER 3" NMDOT SPECIFICATION BASE COURSE
- SENSITIVE PALEONTOLOGICAL AREA. DO NOT ENCROACH.
- TEMPORARY CONSTRUCTION EASEMENT
- ACCESS DRIVEWAY

SANDOVAL COUNTY, NEW MEXICO
SEC-29, T-21-N, R-5-W
BUREAU OF LAND MANAGEMENT

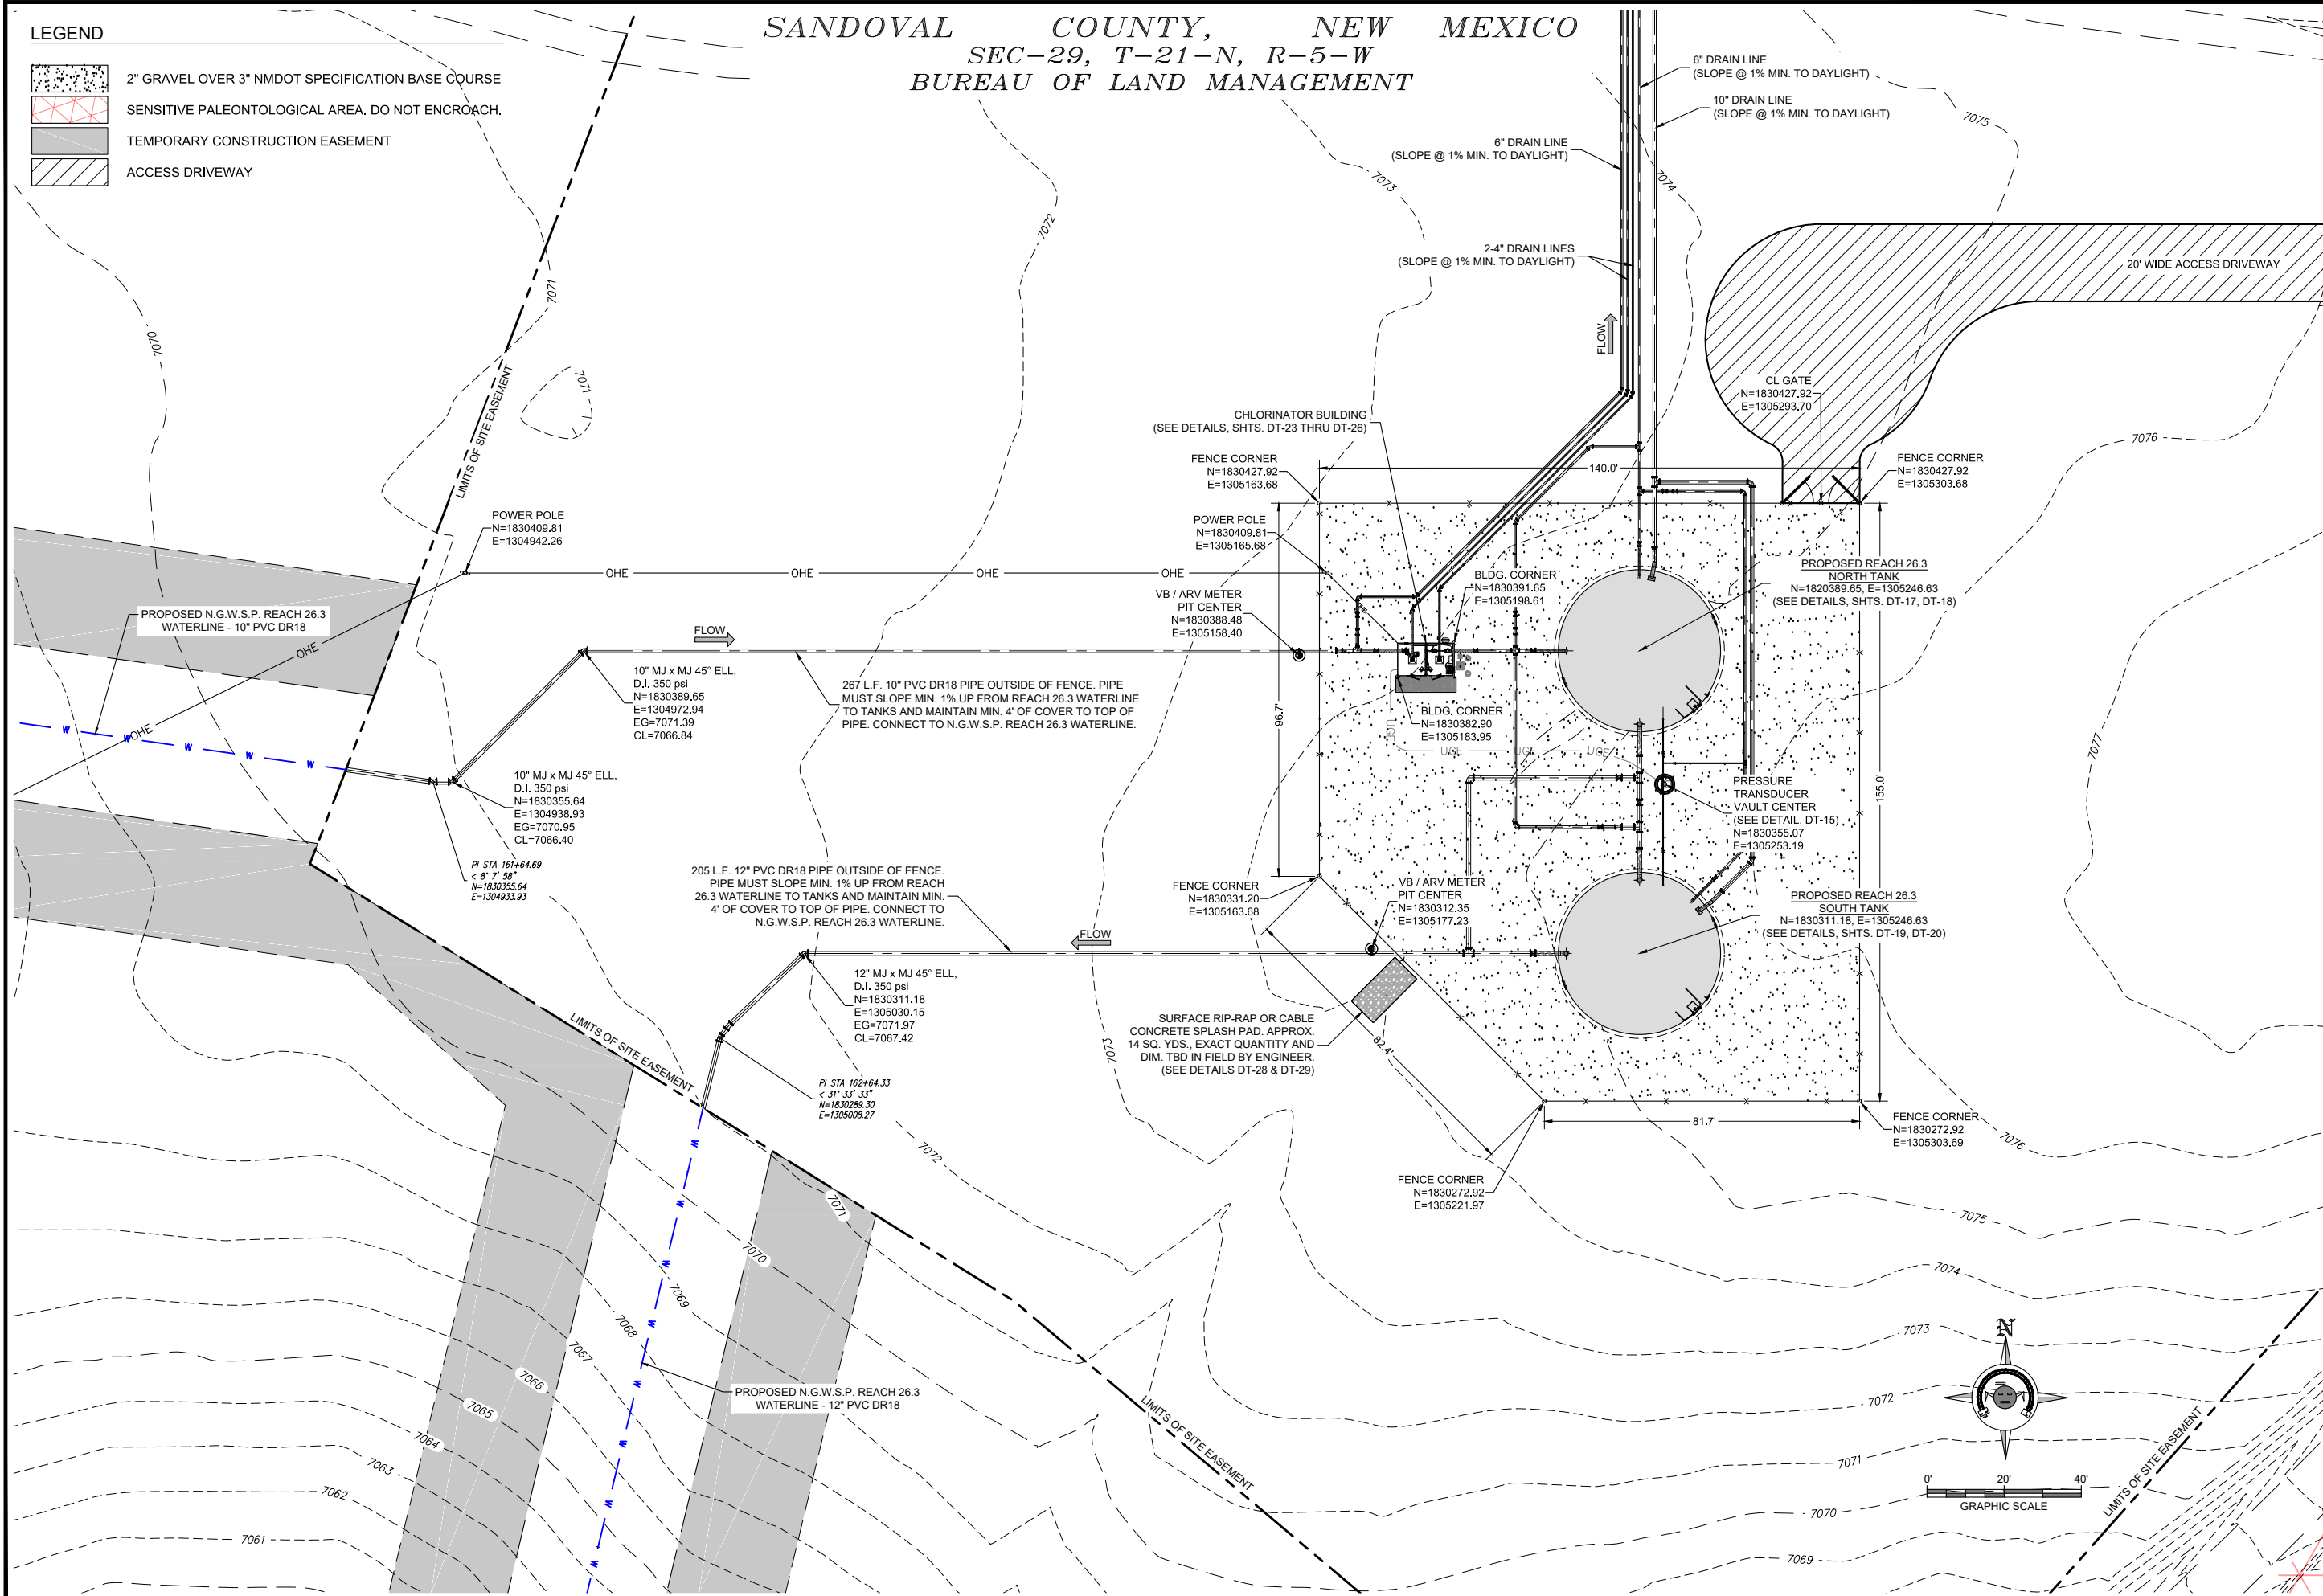

<p>CLIENT: The Navajo Nation</p> <p>TOWN: Reach 26.3 To Turren, NM</p>	
<p>REACH 26.3 TANK SITE PLAN</p> <p>SECTION 29, T. 21 N., R. 5 W.</p> <p>NAVAJO GALLUP WATER SUPPLY</p> <p>PROJECT - REACH 26.3</p> <p>SANDOVAL & MCKINLEY COUNTIES, NEW MEXICO</p>	
<p>Designed TTT</p>	<p>Drawn MVA/AG</p>
<p>Checked AGR</p>	<p>Reviewed 90% DRAFT</p>
<p>PRELIMINARY NOT FOR CONSTRUCTION</p>	
<p>THIS DRAWING IS INCOMPLETE AND NOT TO BE USED FOR CONSTRUCTION UNLESS IT IS STAMPED, SIGNED AND DATED.</p>	
<p>NOTICE OF EXTENDED PAYMENT PROVISION: THIS CONTRACT PROVIDES THE OWNER TO MAKE PAYMENT WITHIN 45 DAYS AFTER SUBMISSION OF AN UNDISPUTED REQUEST FOR PAYMENT.</p>	
<p>811 Know what's below. Call before you dig.</p>	
<p>Date: September 27, 2018</p>	
<p>Scale: Horiz: 1" = 40' Vert: N/A</p>	
<p>Project No: 6921307</p>	
<p>Sheet: C-26</p>	


SANDOVAL COUNTY, NEW MEXICO
SEC-29, T-21-N, R-5-W
BUREAU OF LAND MANAGEMENT

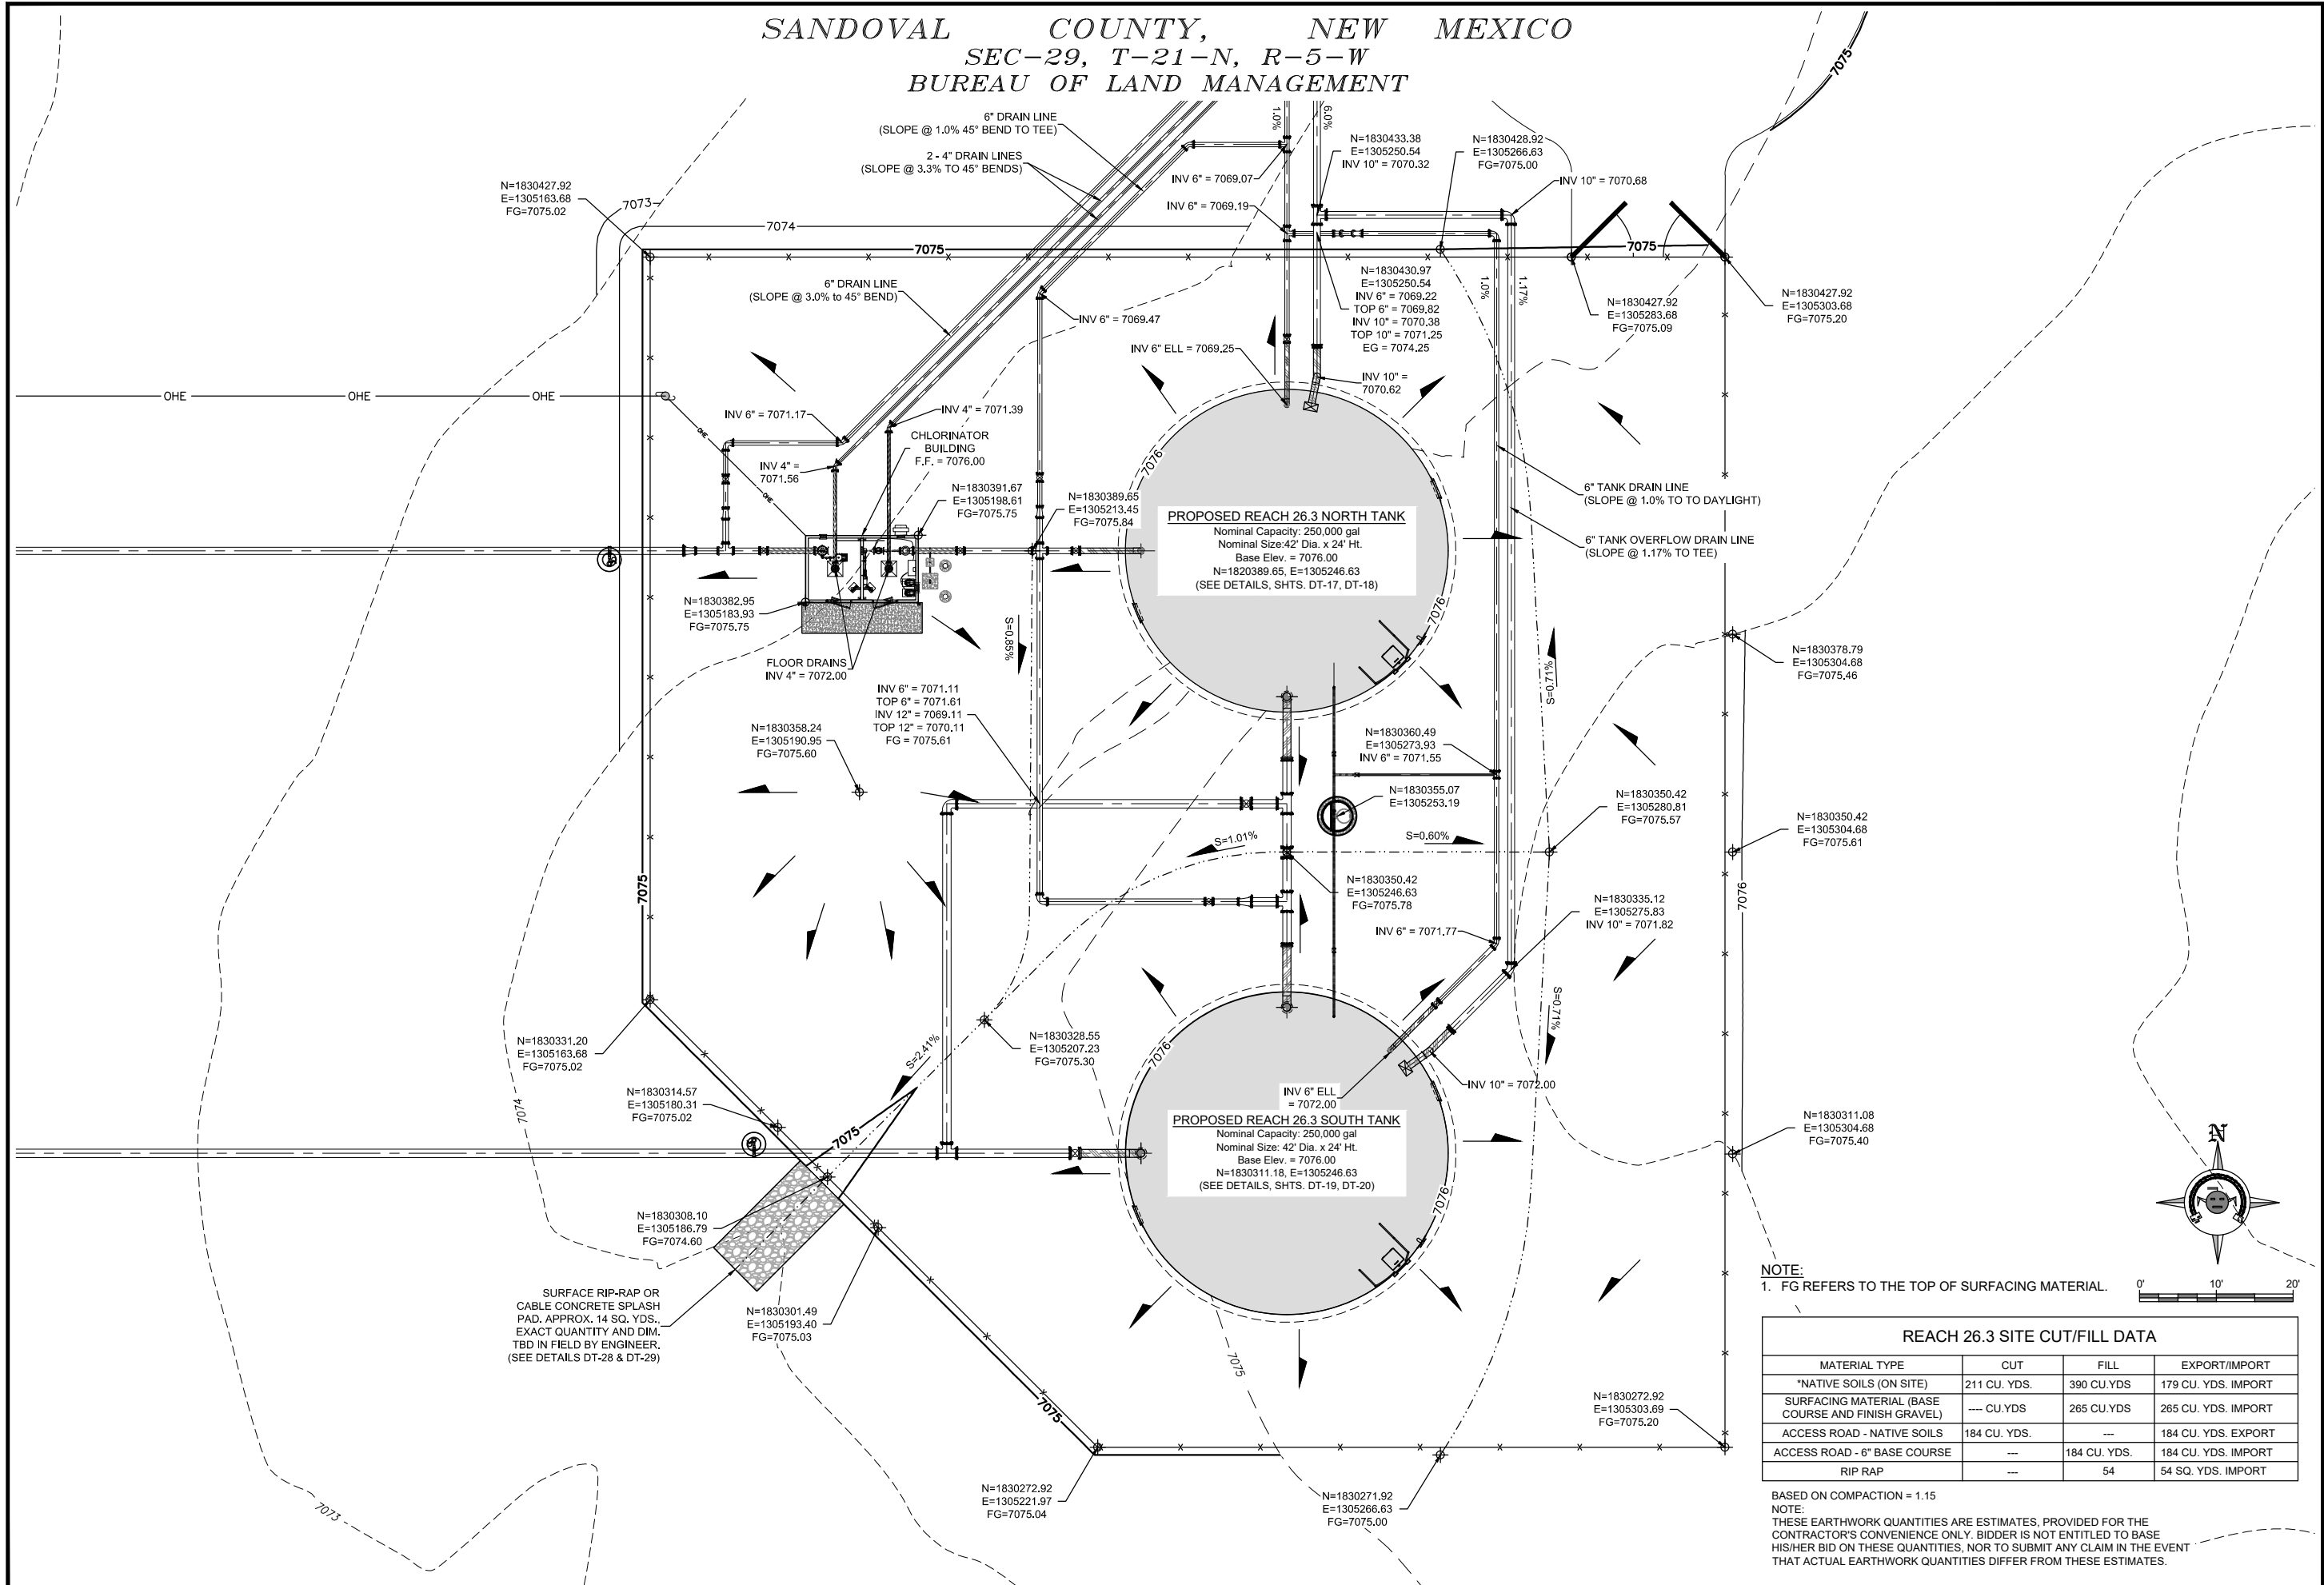

REACH 26.3 SITE CUT/FILL DATA			
MATERIAL TYPE	CUT	FILL	EXPORT/IMPORT
*NATIVE SOILS (ON SITE)	211 CU. YDS.	390 CU.YDS	179 CU. YDS. IMPORT
SURFACING MATERIAL (BASE COURSE AND FINISH GRAVEL)	--- CU.YDS	265 CU.YDS	265 CU. YDS. IMPORT
ACCESS ROAD - NATIVE SOILS	184 CU. YDS.	---	184 CU. YDS. EXPORT
ACCESS ROAD - 6" BASE COURSE	---	184 CU. YDS.	184 CU. YDS. IMPORT
RIP RAP	---	54	54 SQ. YDS. IMPORT

BASED ON COMPACTION = 1.15
NOTE:
THESE EARTHWORK QUANTITIES ARE ESTIMATES, PROVIDED FOR THE CONTRACTOR'S CONVENIENCE ONLY. BIDDER IS NOT ENTITLED TO BASE HIS/HER BID ON THESE QUANTITIES, NOR TO SUBMIT ANY CLAIM IN THE EVENT THAT ACTUAL EARTHWORK QUANTITIES DIFFER FROM THESE ESTIMATES.

SANDOVAL COUNTY, NEW MEXICO
SEC-29, T-21-N, R-5-W
BUREAU OF LAND MANAGEMENT

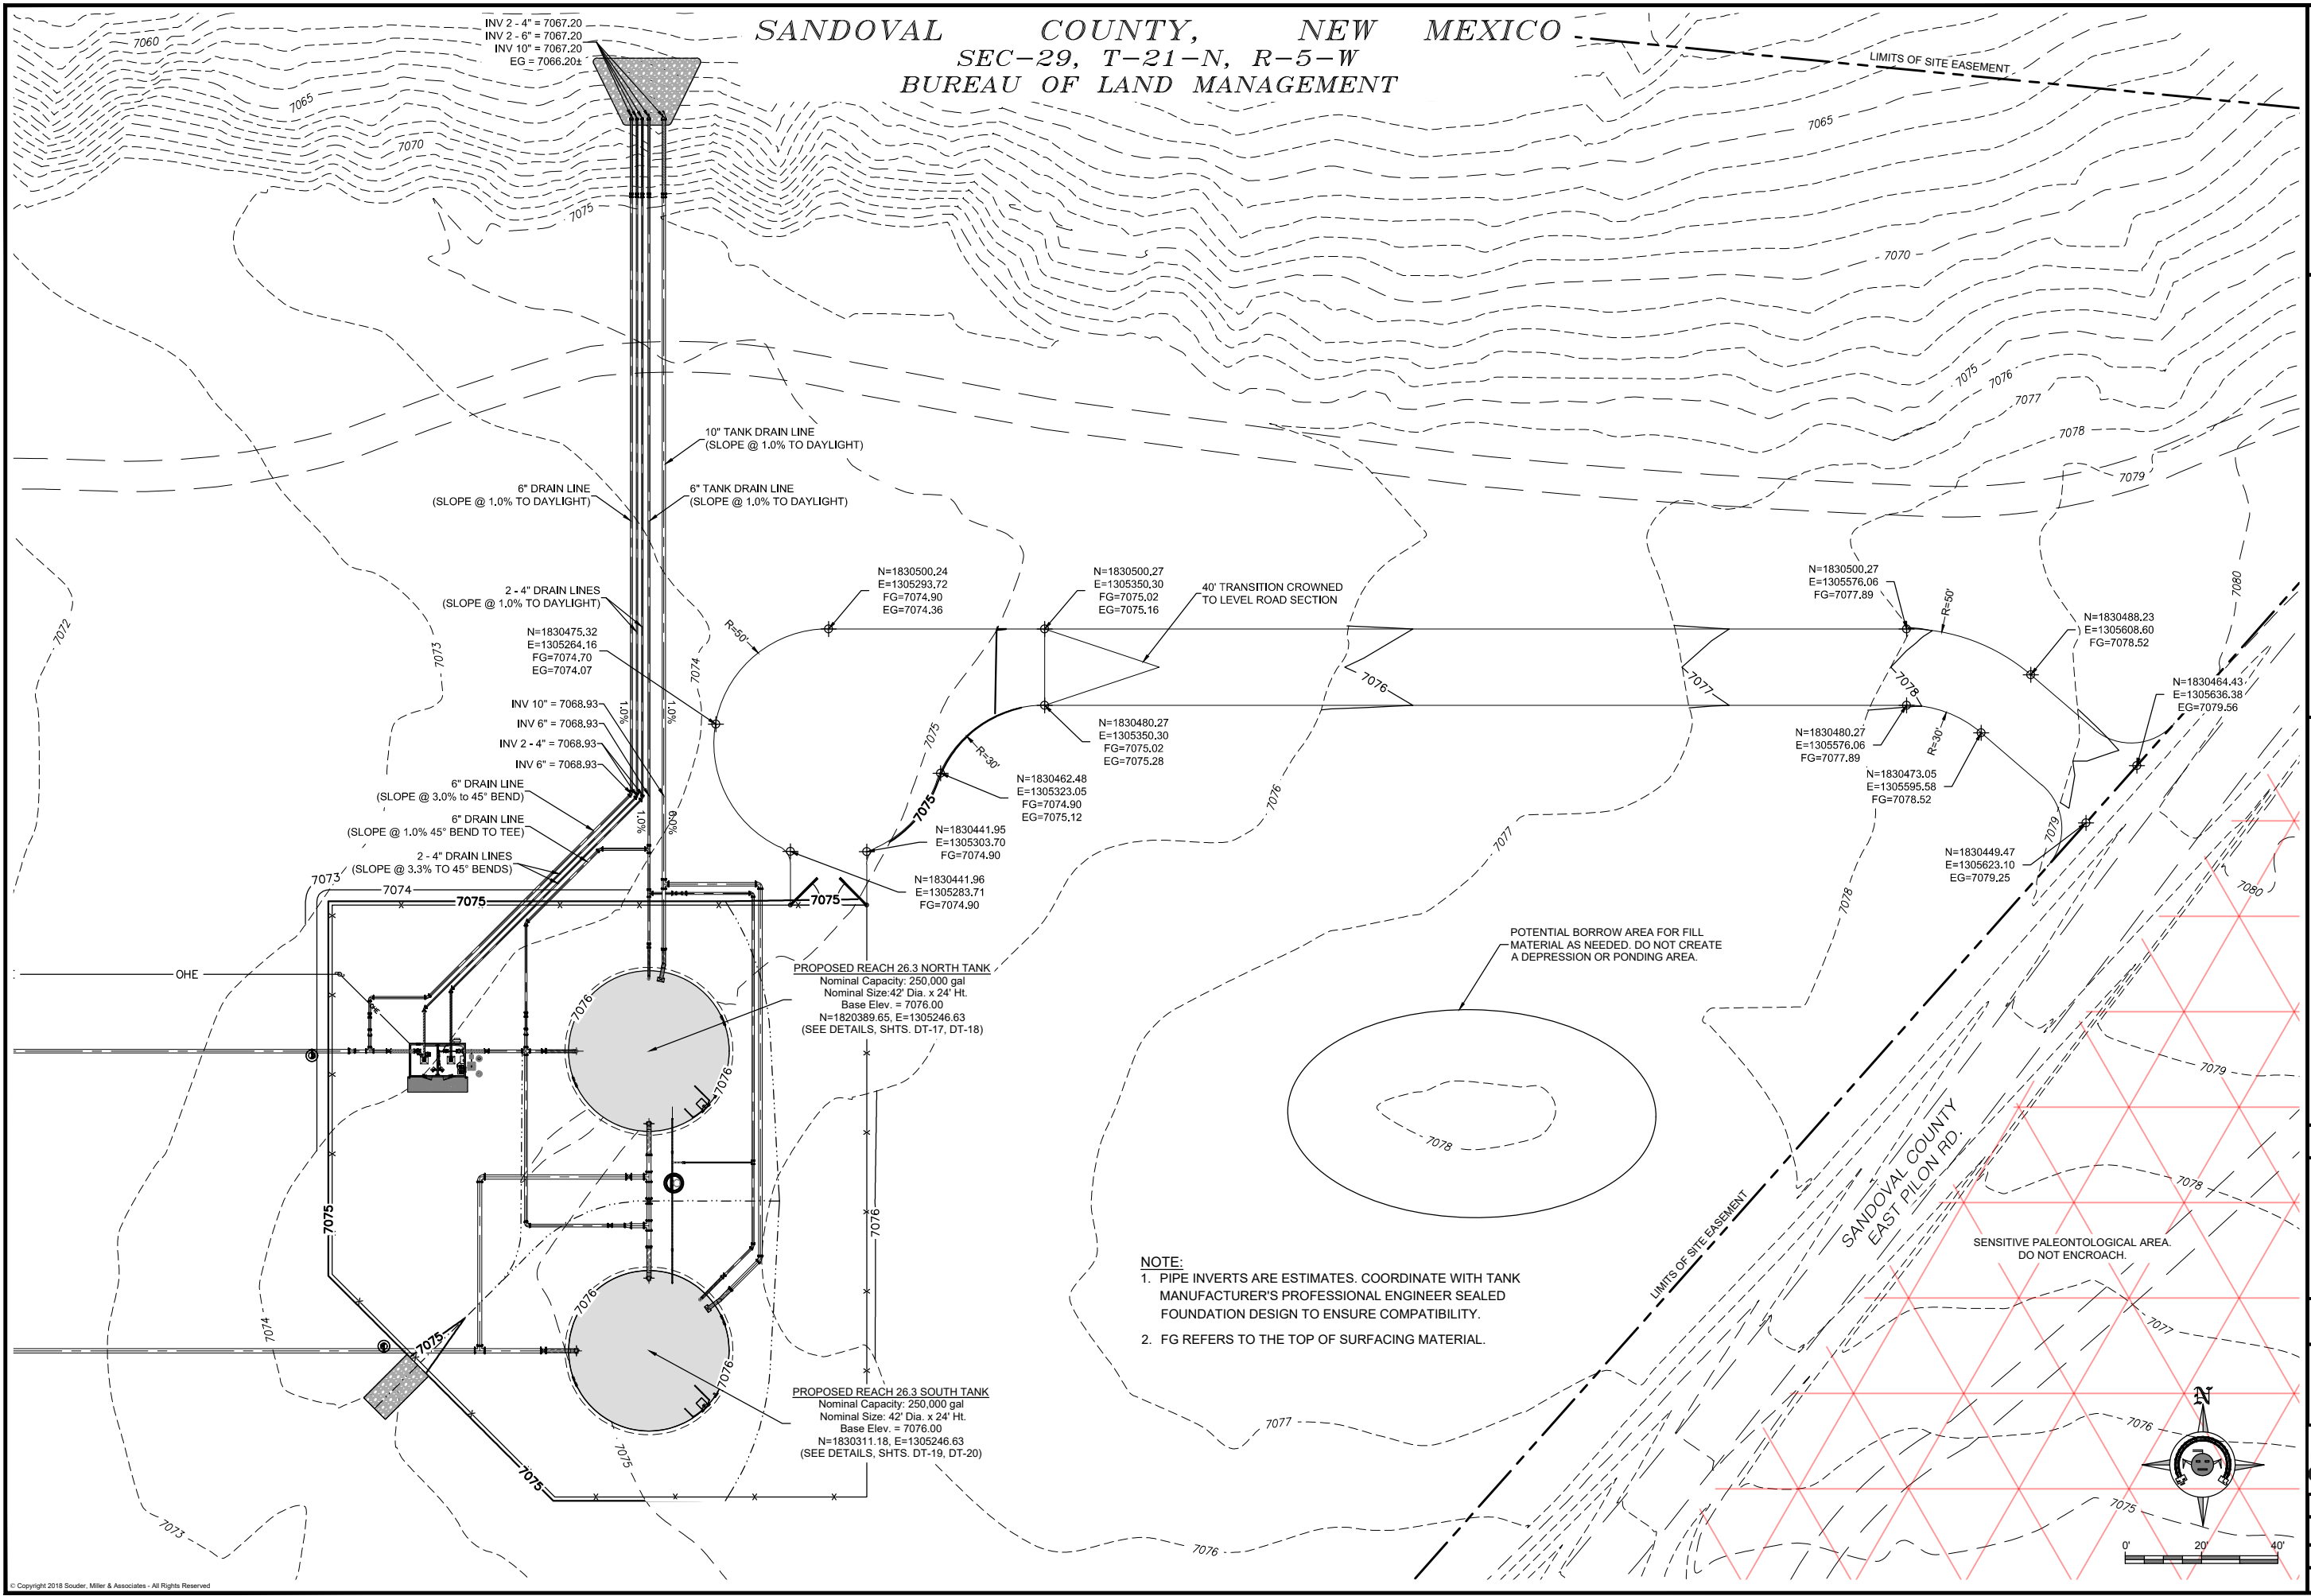

NOTE:
1. PIPE INVERTS ARE ESTIMATES. COORDINATE WITH TANK MANUFACTURER'S PROFESSIONAL ENGINEER SEALED FOUNDATION DESIGN TO ENSURE COMPATIBILITY.
2. FG REFERS TO THE TOP OF SURFACING MATERIAL.

Revision	Date	Description	By	CHK'd

SMA
Engineering & Environmental Surveying
SOUDEUR, MILLER & ASSOCIATES
5454 VANCE AVENUE NE, SUITE D
ALBUQUERQUE, NM 87113
Phone (505) 299-0942 Toll-Free (877) 299-0942 Fax (505) 293-3430
www.soudermiller.com
Serving the Southwest & Rocky Mountains
Albuquerque, Carlsbad, Hobbs, Farmington, Las Cruces, Roswell, Santa Fe, NM
Cortez, Grand Junction, CO - Safford, AZ - Moab, UT - El Paso, TX
10/26/2018 10:48:07 AM

CLIENT: The Navajo Nation TOWN: Reach 26.3 To Tiorreon, NM
REACH 26.3 TANK SITE DRAIN PIPING AND ACCESS ROAD GRADING PLAN
NAVAJO GALLUP WATER SUPPLY PROJECT - REACH 26.3
SANDOVAL & MCKINLEY COUNTIES, NEW MEXICO

Designed	Drawn	Checked
TTT	MW/AAV	AGR

90% REVIEW
DRAFT
PRELIMINARY
NOT FOR CONSTRUCTION

THIS DRAWING IS INCOMPLETE AND NOT TO BE USED FOR CONSTRUCTION UNLESS IT IS STAMPED, SIGNED AND DATED.

NOTICE OF EXTENDED PAYMENT PROVISION:
THIS CONTRACT ALLOWS THE OWNER TO MAKE PAYMENT WITHIN 45 DAYS AFTER SUBMISSION OF AN UNDISPUTED REQUEST FOR PAYMENT.




811 Know what's below. Call before you dig.

Date: September 28, 2018
Scale: Horiz: 1" = 40'
Vert: N/A
Project No: 6921307
Sheet: C-28

KEYED NOTES - PUEBLO PINTADO TANK SITE	
Item No.	Description
1	CHLORINATOR BUILDING (SEE DETAILS DT-23 THRU DT-26)
2	2" VACUUM BREAKER W/ 1" AIR RELEASE VALVE (SEE DETAIL DT-7)
3	PRESSURE TRANSDUCER VAULT (SEE DETAIL DT-15)
4	12" PVC DR18 PIPE
5	12" STEEL PIPE, STANDARD WALL
6	12" MJ x FL GATE VALVE (SEE DETAIL DT-6) 250 psi
7	12" MJ x MJ GATE VALVE (SEE DETAIL DT-6) 250 psi
8	12" MJ x MJ TEE, D.I. 350 psi
9	12" MJ x MJ 90° ELL, D.I. 350 psi
10	12" x 8" MJ x MJ CONCENTRIC REDUCER, D.I. 350 psi
11	10" STEEL PIPE, STANDARD WALL
12	10" PVC DR18 PIPE
13	10" MJ x MJ TEE, D.I. 350 psi
14	10" MJ x MJ 90° ELL, D.I. 350 psi
15	10" MJ x MJ 45° ELL, D.I. 350 psi
16	10" MJ FLANGE ADAPTER, FBE-COATED WITH SS 304 BOLTS, MEGAFLANGE SERIES 2100, 235 psi, OAE
17	10" TIDEFLEX VALVE (SEE DETAIL DT-30)
18	10" FL x PE DUCTILE IRON PIPE 350 psi
19	10" MJ X MJ SHORT SLEEVE, D.I. 350 psi
20	10" x 8" MJ x MJ CONCENTRIC REDUCER, D.I. 350 psi
21	8" STEEL PIPE, STANDARD WALL
22	8" PVC DR18 PIPE
23	8" MJ x MJ GATE VALVE (SEE DETAIL DT-6) 350 psi
24	8" MJ x FL GATE VALVE (SEE DETAIL DT-6) 350 psi
25	8" MJ x MJ TEE, D.I. 350 psi
26	8" MJ x MJ CROSS, D.I. 350 psi
27	8" MJ x MJ 90° ELL, D.I. 350 psi
28	8" DUCTILE IRON PIPE 350 psi
29	8" x 6" MJ x MJ CONCENTRIC REDUCER, D.I. 350 psi
30	6" STEEL PIPE, STANDARD WALL
31	6" PVC DR18 PIPE
32	6" MJ x MJ GATE VALVE (SEE DETAIL DT-6) 350 psi
33	6" MJ x FL GATE VALVE (SEE DETAIL DT-6) 350 psi
34	6" MJ x MJ TEE, D.I. 350 psi
35	6" MJ x MJ 90° ELL, D.I. 350 psi
36	6" MJ x MJ 45° ELL, D.I. 350 psi
37	6" FL x PE DUCTILE IRON PIPE 350 psi
38	6" TIDEFLEX VALVE (SEE DETAIL DT-30)
39	6" MJ X MJ SHORT SLEEVE, D.I. 350 psi
40	6" x 2" MJ x MJ TAPPED TEE, 350 psi
41	4" PVC DR18 PIPE
42	4" DUCTILE IRON PIPE 350 psi
43	4" FL x PE DUCTILE IRON PIPE 350 psi
44	4" MJ x MJ 45° ELL, D.I. 350 psi
45	4" CAST IRON FLAP VALVE (SEE DETAIL DT-30)
46	4" MJ X MJ SHORT SLEEVE, D.I. 350 psi
47	2" STEEL PIPE NPT, SCHEDULE 40
48	2" STEEL TEE NPT, SCHEDULE 40
49	2" MUELLER 300 BALL CURB VALVE, 300 psi, OAE (SEE DETAIL DT-16)
50	1" YARD HYDRANT ASSEMBLY (SEE DETAIL DT-16)
51	12" MJ FLANGE ADAPTER, FBE-COATED WITH SS 304 BOLTS, MEGAFLANGE SERIES 2100, 235 psi, OAE

NOTES:

- CONTRACTOR SHALL FIELD SURVEY ELEVATION OF OVERFLOW WEIR OF BOTH TANKS AND ENSURE OVERFLOW WEIR ELEVATIONS MATCH (WITHIN A TOLERANCE OF $\pm 1/2"$ INCH).
- PROVIDE TANK SUB-FOUNDATIONS, OVER-EXCAVATION AND SITE GRADING IN ACCORDANCE WITH GEOTECHNICAL REPORT (GEOTEST REPORT NO. 1-71108 DATED 1-8-2018) AND DETAILS DT-17 THRU DT-22.
- PROVIDE TANK FOUNDATION IN ACCORDANCE WITH GEOTECHNICAL REPORT (GEOTEST REPORT NO. 1-71108 DATED 1-8-2018) AND TANK MANUFACTURER'S PE-SEALED FOUNDATION DESIGN.
- NO HIGH SPOTS PERMITTED ON SITE PIPING. ALL SITE PIPING (INCLUDING SENSOR LINES) SHALL SLOPE UP TOWARDS TANKS, VACUUM BREAKER / AIR RELEASE VALVE VAULTS, PRESSURE TRANSDUCER VAULT, OR CHLORINATOR BUILDING (MIN. 1%).
- ALL MATERIALS, FITTINGS AND APPURTENANCES SHALL BE RATED TO AT LEAST 235 psi, UNLESS OTHERWISE NOTED.
- ALL PIPE AND FITTINGS UNDERNEATH AND WITHIN 5' OF TANK AND BUILDING FOUNDATIONS SHALL BE STEEL AND SHALL BE SHOP WELDED, SHOP COATED, X-RAY TESTED AND PRESSURE TESTED PRIOR TO PLACING FOUNDATIONS. SHOP COATINGS SHALL BE APPLIED AFTER WELDING.
- ALL VALVES AND STEEL-TO-PVC COUPLINGS AT TANKS AND BUILDINGS SHALL BE LOCATED AT LEAST 5' FROM EDGES OF FOUNDATIONS. COORDINATE WITH TANK FOUNDATION PROFESSIONAL ENGINEER DESIGN.
- ALL BURIED NON-STAINLESS STEEL PIPE AND FITTINGS SHALL BE COLD-APPLIED TAPE-WRAPPED, PER SPECIFICATIONS.
- IF WELDED STEEL TANKS ARE USED, ALL BURIED STEEL PIPE, WELDED FITTINGS AND OTHER COMPONENTS SHALL BE EXTERIOR COATED W/ COAL TAR EPOXY AND COLD APPLIED TAPE COATING PER SPECIFICATIONS, AND INTERIOR COATED TO MATCH TANK INTERIOR SIDE WALL.
- IF GLASS-FUSED STEEL TANKS ARE USED, ALL 2-INCH STEEL PIPE AND FITTINGS SHALL BE COLD APPLIED TAPE WRAPPED PER SPECIFICATIONS. ALL 2-INCH STEEL PIPES AND FITTINGS SHALL BE SS 304.
- ALL BURIED DUCTILE IRON PIPE (EXCEPT FOR RISERS UNDER CHLORINATION BUILDING) AND ALL DUCTILE IRON FITTINGS SHALL BE DOUBLE-WRAPPED POLYETHYLENE, PER SPECIFICATIONS. INNER JACKET SHALL BE V-BIO ENHANCED, MIN. 8-MIL. OUTER JACKET SHALL BE STANDARD PE, MIN. 8-MIL. DUCTILE IRON RISERS UNDER CHLORINATION BUILDING SHALL BE COLD-APPLIED TAPE-WRAPPED, PER SPECIFICATIONS.
- ALL BURIED DUCTILE IRON FITTINGS SHALL BE MJ. ALL BURIED DUCTILE IRON PIPES SHALL BE SOLID PIECES. NO DUCTILE IRON PIPE JOINTS ALLOWED.
- ALL PRESSURE BEARING PIPES WITHIN SITE SHALL BE FULLY RESTRAINED. ALL PVC PIPE JOINTS LARGER THAN 2" SHALL BE FUSED. REFER TO DETAIL, SHEET DT-3.
- FIELD LOCATE CONDUITS PER REVIEW WITH ELECTRICIAN.

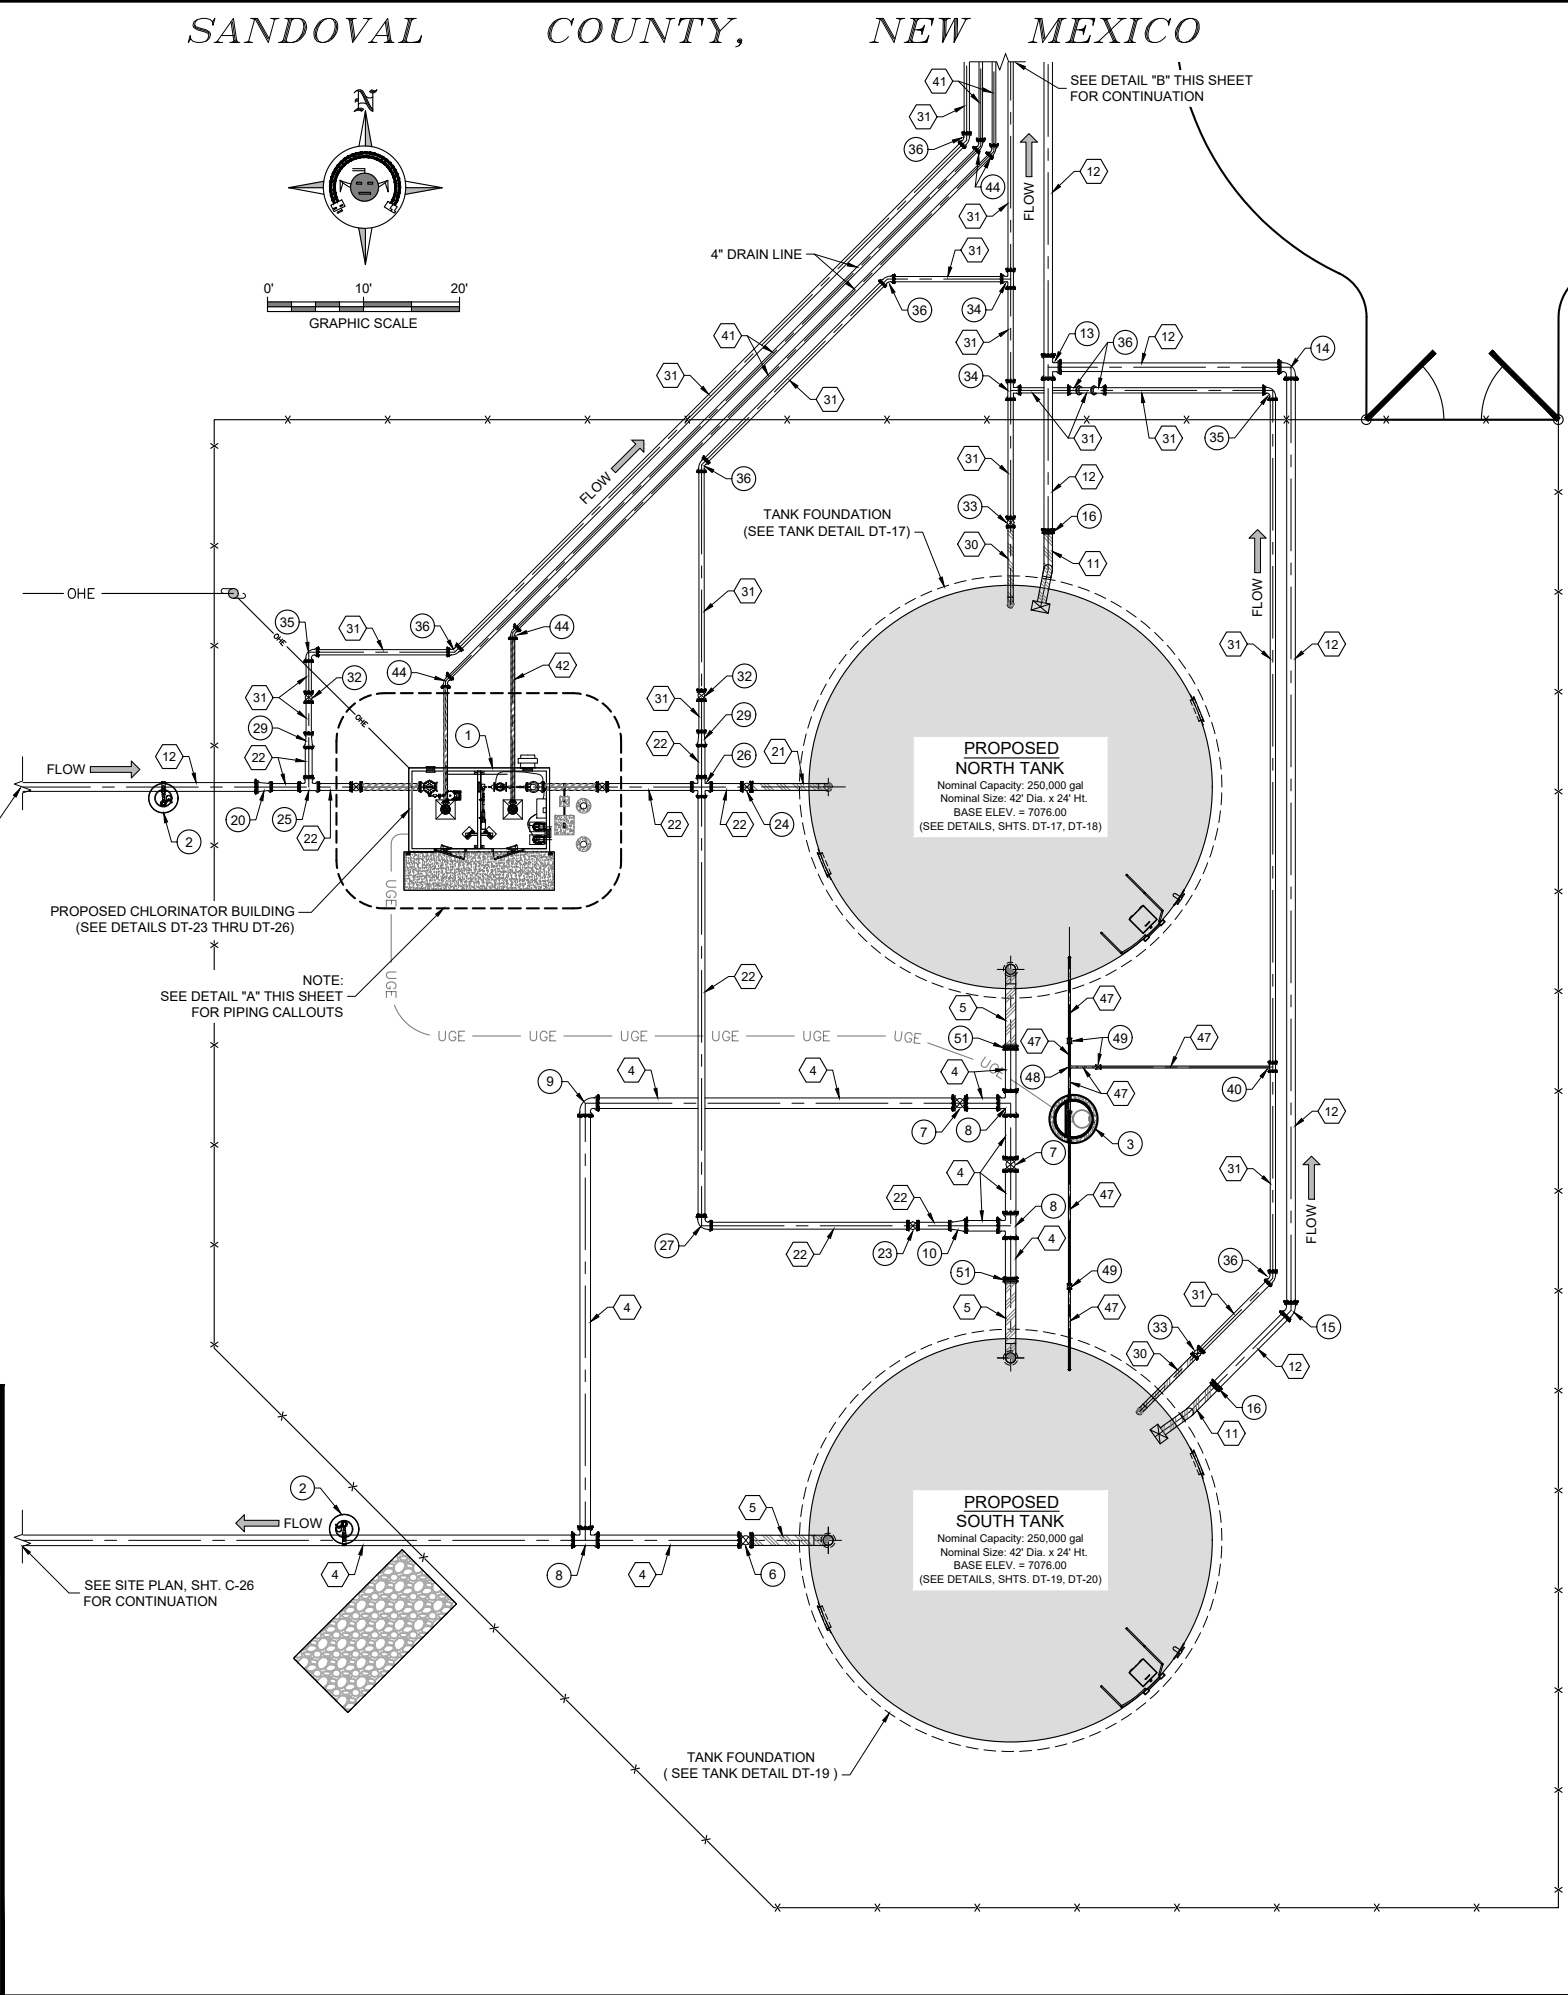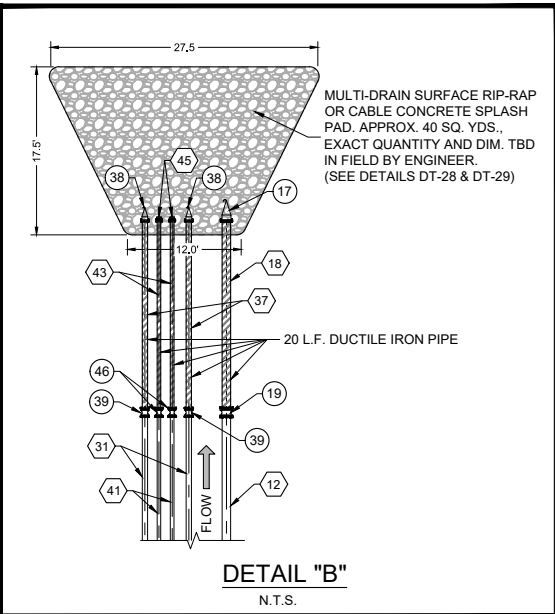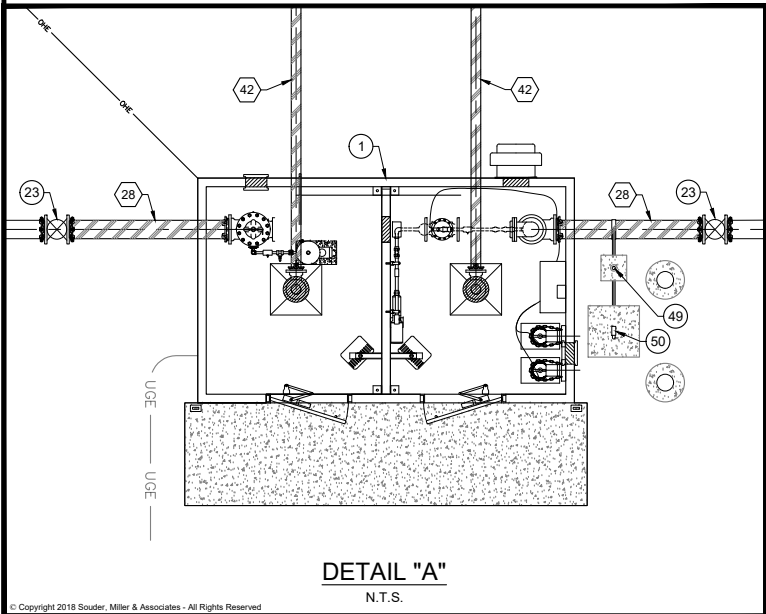

CLIENT: The Navajo Nation
TOWN: Reach 26.3 To Turren, NM
REACH 26.3 TANK SITE PIPING PLAN
SECTION 29, T. 21 N., R. 5 W.
NAVAJO GALLUP WATER SUPPLY
PROJECT - REACH 26.3
SANDOVAL & MCKINLEY COUNTIES, NEW MEXICO

DESIGNED: TTT
DRAWN: MHT/AAV
CHECKED: AGR


90% REVIEW
DRAFT
PRELIMINARY
NOT FOR CONSTRUCTION
THIS DRAWING IS INCOMPLETE AND NOT TO BE USED FOR CONSTRUCTION UNLESS IT IS STAMPED, SIGNED AND DATED
NOTICE OF EXTENDED PAYMENT PROVISION:
THIS CONTRACT ALLOWS THE OWNER TO MAKE PAYMENT WITHIN 45 DAYS AFTER SUBMISSION OF AN UNDISPUTED REQUEST FOR PAYMENT.

811
Know what's below.
Call before you dig.
Date: September 27, 2018
Scale: Horiz: 1" = 20'
Vert: N/A
Project No: 6921307
Sheet: C-29

SOUDER, MILLER & ASSOCIATES
5454 VENCE AVENUE, SUITE D
ALBUQUERQUE, NM 87113
Phone (505) 299-0942 Toll-Free (877) 299-0942 Fax (505) 293-3430
www.soudermiller.com
Serving the Southwest & Rocky Mountains
Albuquerque, Carlsbad, Hobbs, Farmington, Las Cruces, Roswell, Santa Fe, NM
Cortez, Grand Junction, CO - Safford, AZ - Moab, UT - El Paso, TX

Revision: Date: Description: By: CWS

REACH 26.3 TANK SITE - VALVE NUMBERING				
Valve No.	Valve Size	Valve Type	Pipe Type	Description
1	6"	GV	PVC	PRE CHLORINATION FLUSH VALVE
2	8"	GV	DI/PVC	CHLORINATION BUILDING INLET
3	1"	CS	HDPE	YARD HYDRANT
4	8"	GV	DI/PVC	CHLORINATION BUILDING OUTLET
5	6"	GV	PVC	POST CHLORINATION FLUSH VALVE
6	8"	GV	STEEL/PVC	NORTH TANK INLET
7	6"	GV	STEEL/PVC	NORTH TANK FLOOR DRAIN
8	12"	GV	PVC	SOUTH TANK BYPASS
9	2"	CS	STEEL	NORTH TANK SENSOR LINE
10	2"	CS	STEEL	SENSOR LINE FLUSH
11	12"	GV	PVC	NORTH TANK OUTLET / SOUTH TANK INLET
12	8"	GV	PVC	NORTH TANK BYPASS
13	2"	CS	STEEL	SOUTH TANK SENSOR LINE
14	6"	GV	STEEL/PVC	SOUTH TANK FLOOR DRAIN
15	12"	GV	STEEL/PVC	SOUTH TANK OUTLET

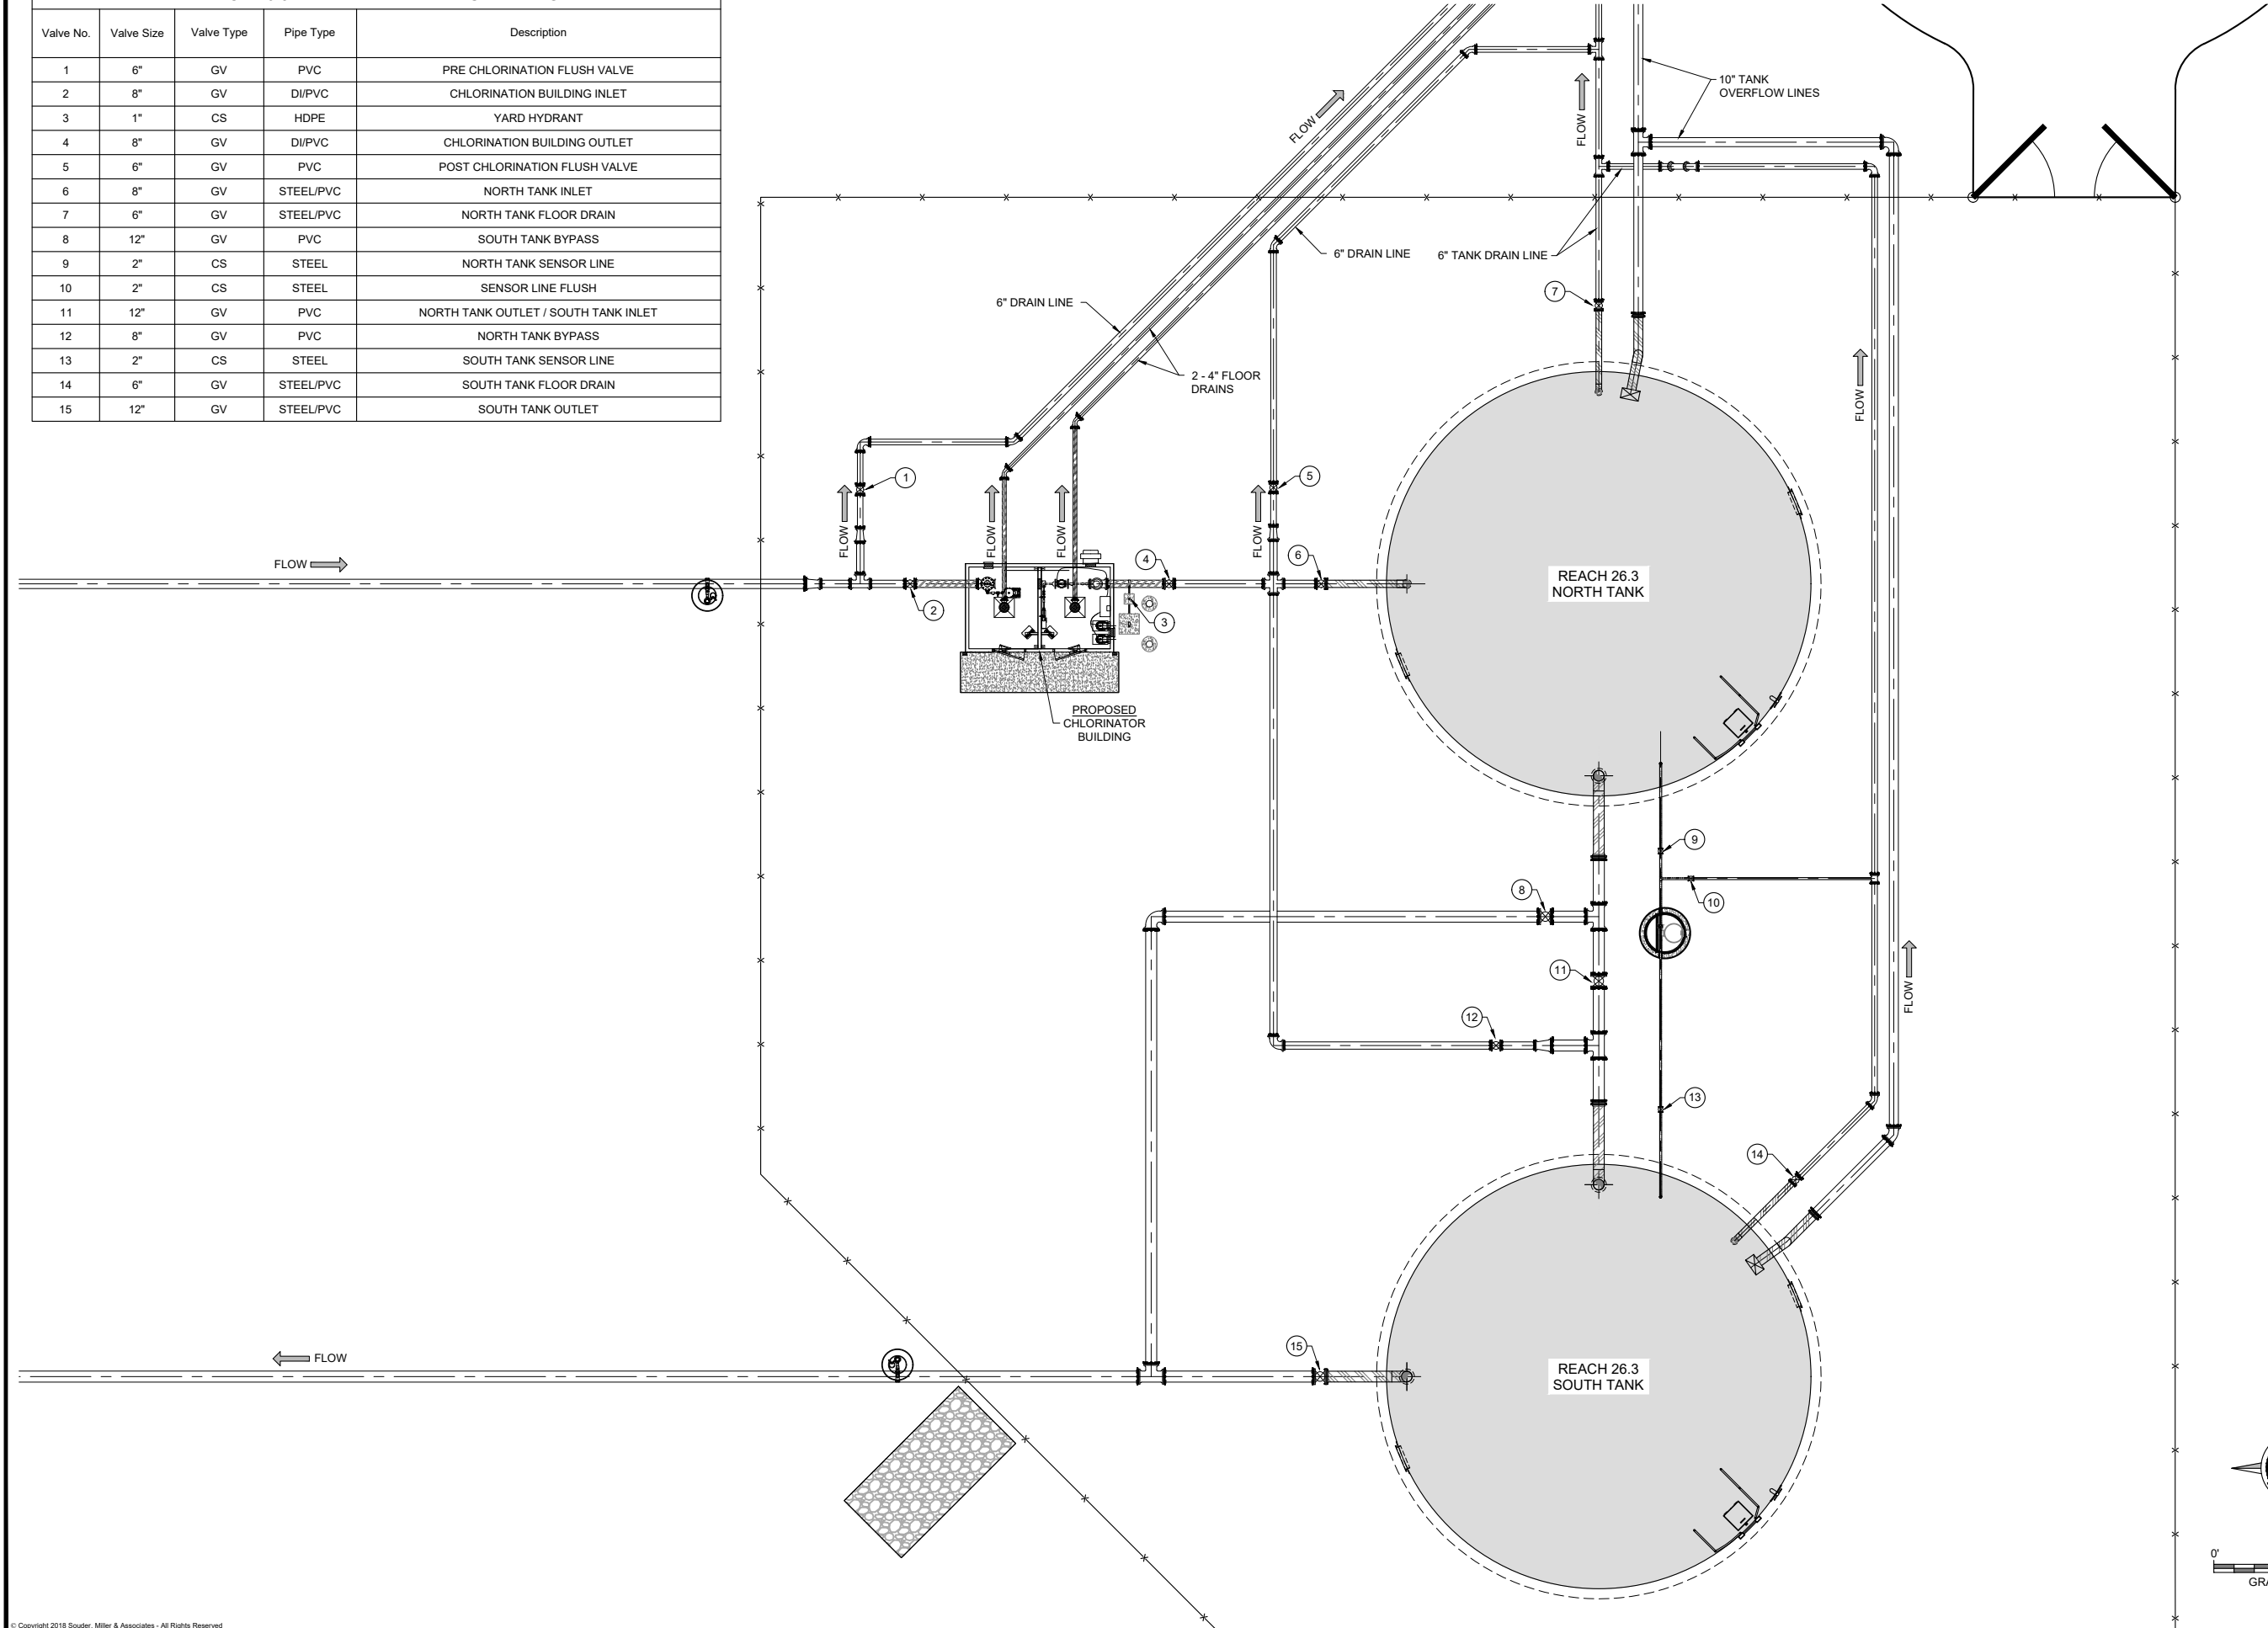

Revision	Date	Description	By	Check



SOUDER, MILLER & ASSOCIATES
5454 VENCE AVENUE NE, SUITE D
ALBUQUERQUE, NM 87113
Phone (505) 299-0942 Toll-Free (877) 299-0942 Fax (505) 293-3430
www.soudermiller.com
Serving the Southwest & Rocky Mountains
Albuquerque, Carlsbad, Hobbs, Farmington, Las Cruces, Roswell, Santa Fe, NM
Cortez, Grand Junction, CO - Safford, AZ - Moab, UT - El Paso, TX

CLIENT: The Navajo Nation
TOWN: Reach 26.3 To Tarron, NM
REACH 26.3 TANK SITE VALVE NUMBERING PLAN
SECTION 29, T. 21 N., R. 5 W.
NAVAJO GALLUP WATER SUPPLY
PROJECT - REACH 26.3
SANDOVAL & MCKINLEY COUNTIES, NEW MEXICO

Designed TTT	Drawn MHT/AAV	Checked AGR
-----------------	------------------	----------------

90% REVIEW
DRAFT

PRELIMINARY
NOT FOR CONSTRUCTION

THIS DRAWING IS INCOMPLETE
AND NOT TO BE USED FOR
CONSTRUCTION UNLESS IT IS
STAMPED, SIGNED AND DATED



NOTICE OF EXTENDED
PAYMENT PROVISION:
THIS CONTRACT ALLOWS THE
OWNER TO MAKE PAYMENT
WITHIN 45 DAYS AFTER
SUBMISSION OF
AN UNDISPUTED REQUEST
FOR PAYMENT.



Know what's
below.
Call before
you dig.


Date: September 27, 2018
Scale: Horiz: 1" = 16'
Vert: N/A
Project No: 6921307
Sheet: **C-30**

McKINLEY COUNTY, NEW MEXICO
SEC-12, T-20-N, R-5-W
INDIAN ALLOTMENT 423

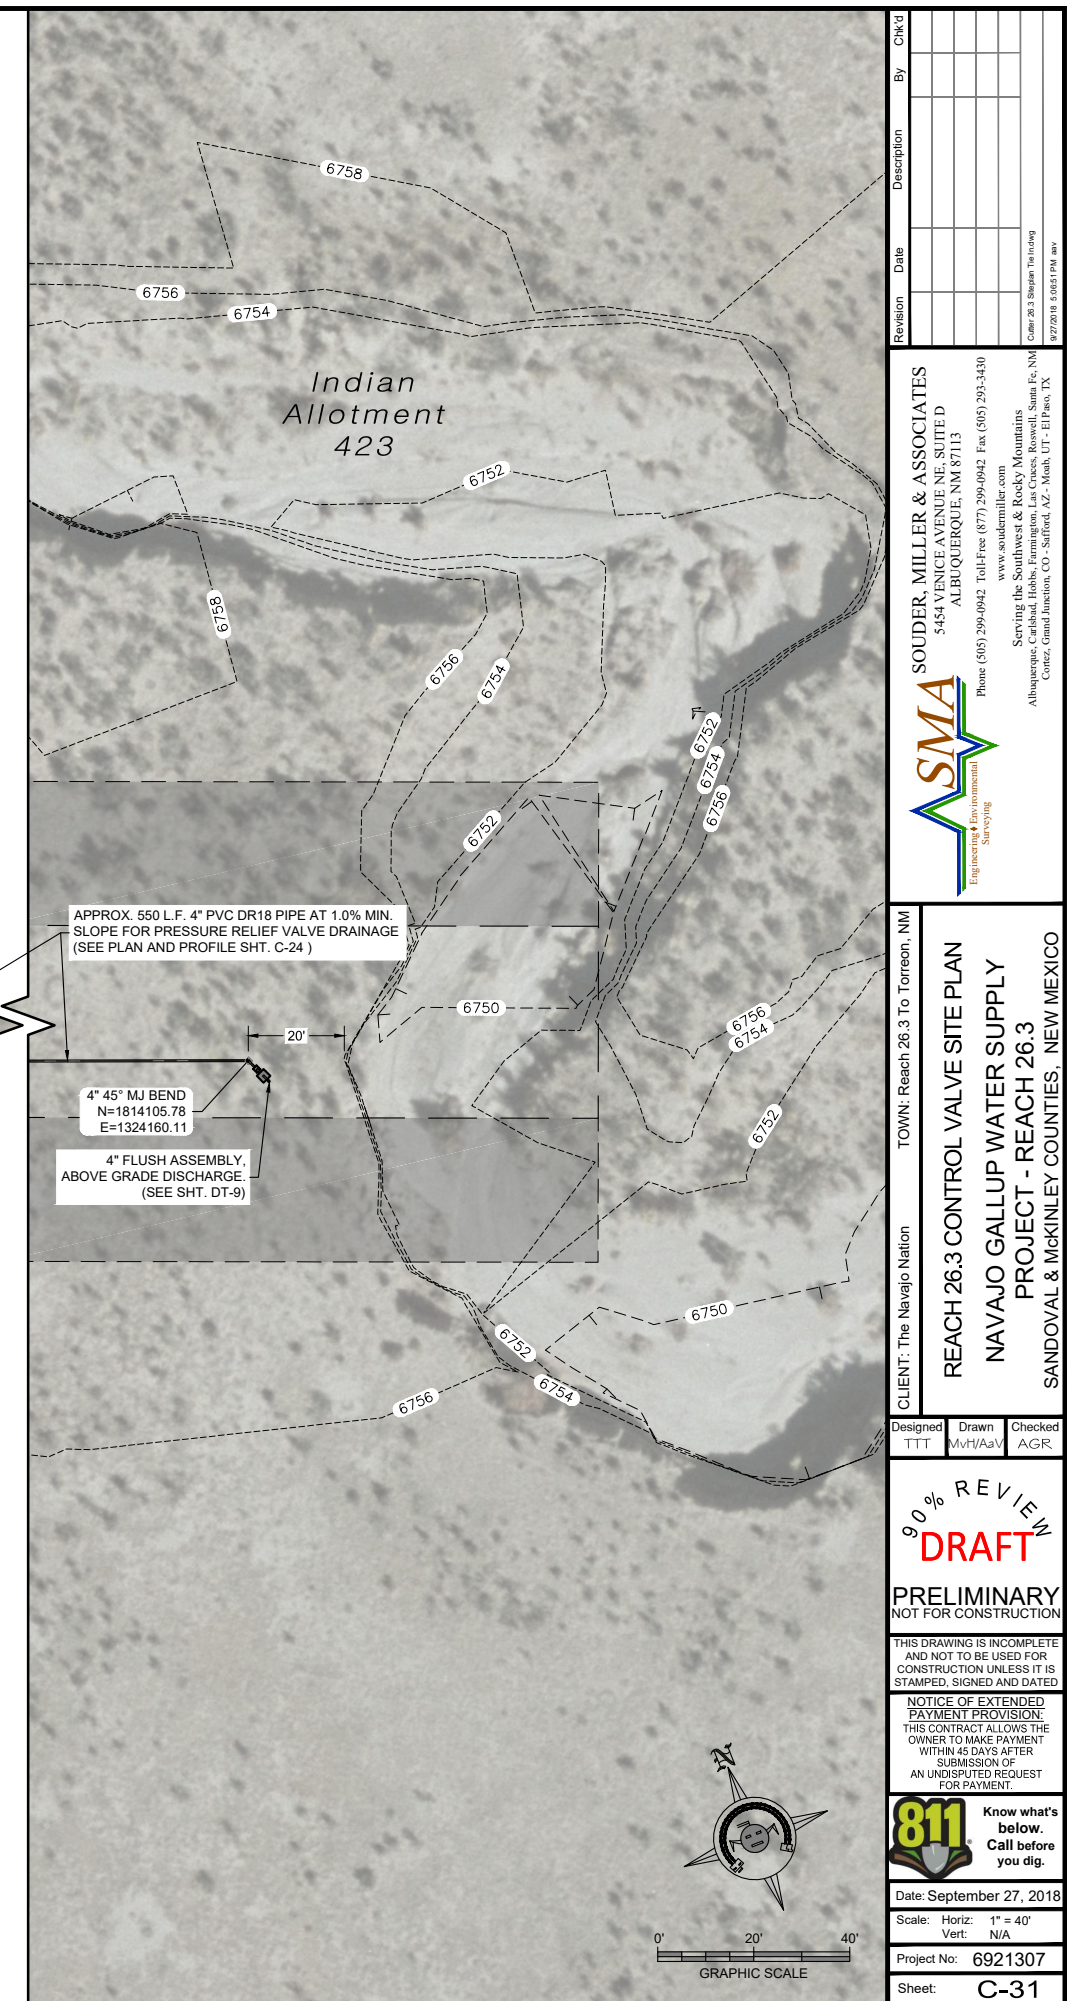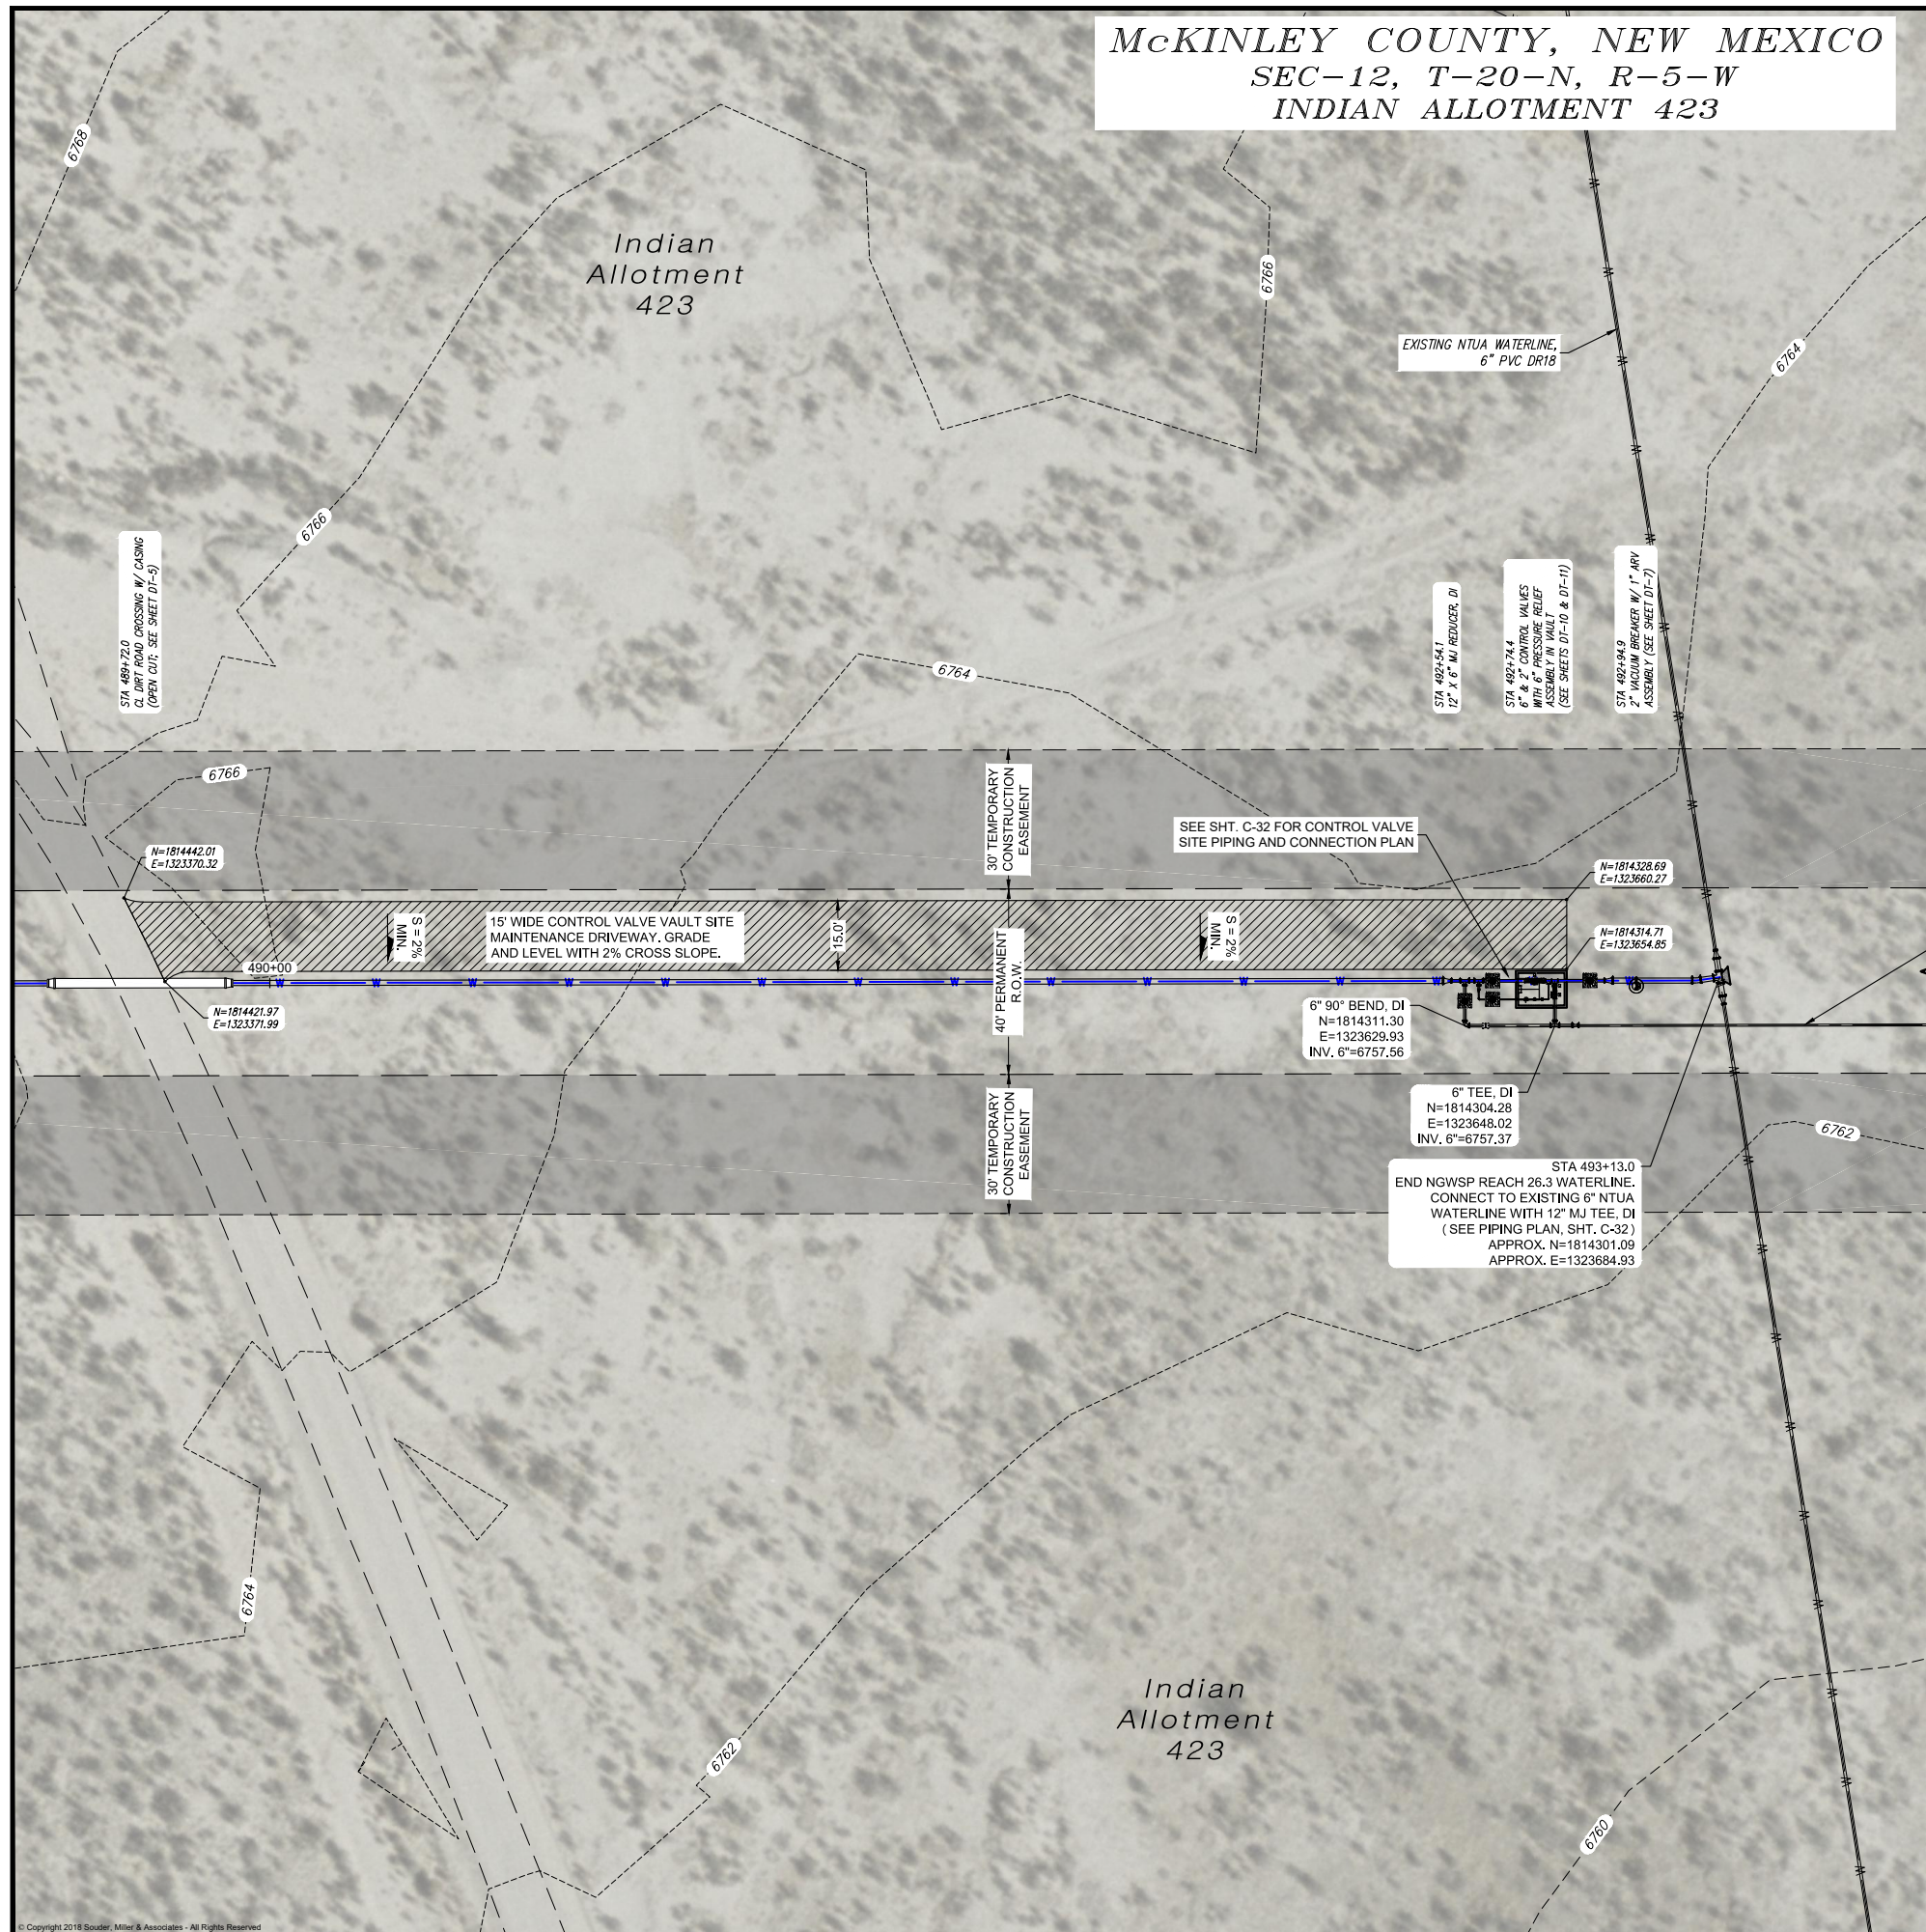


© Copyright 2018 Souder, Miller & Associates - All Rights Reserved

McKINLEY COUNTY, NEW MEXICO
SEC-12, T-20-N, R-5-W
INDIAN ALLOTMENT 423

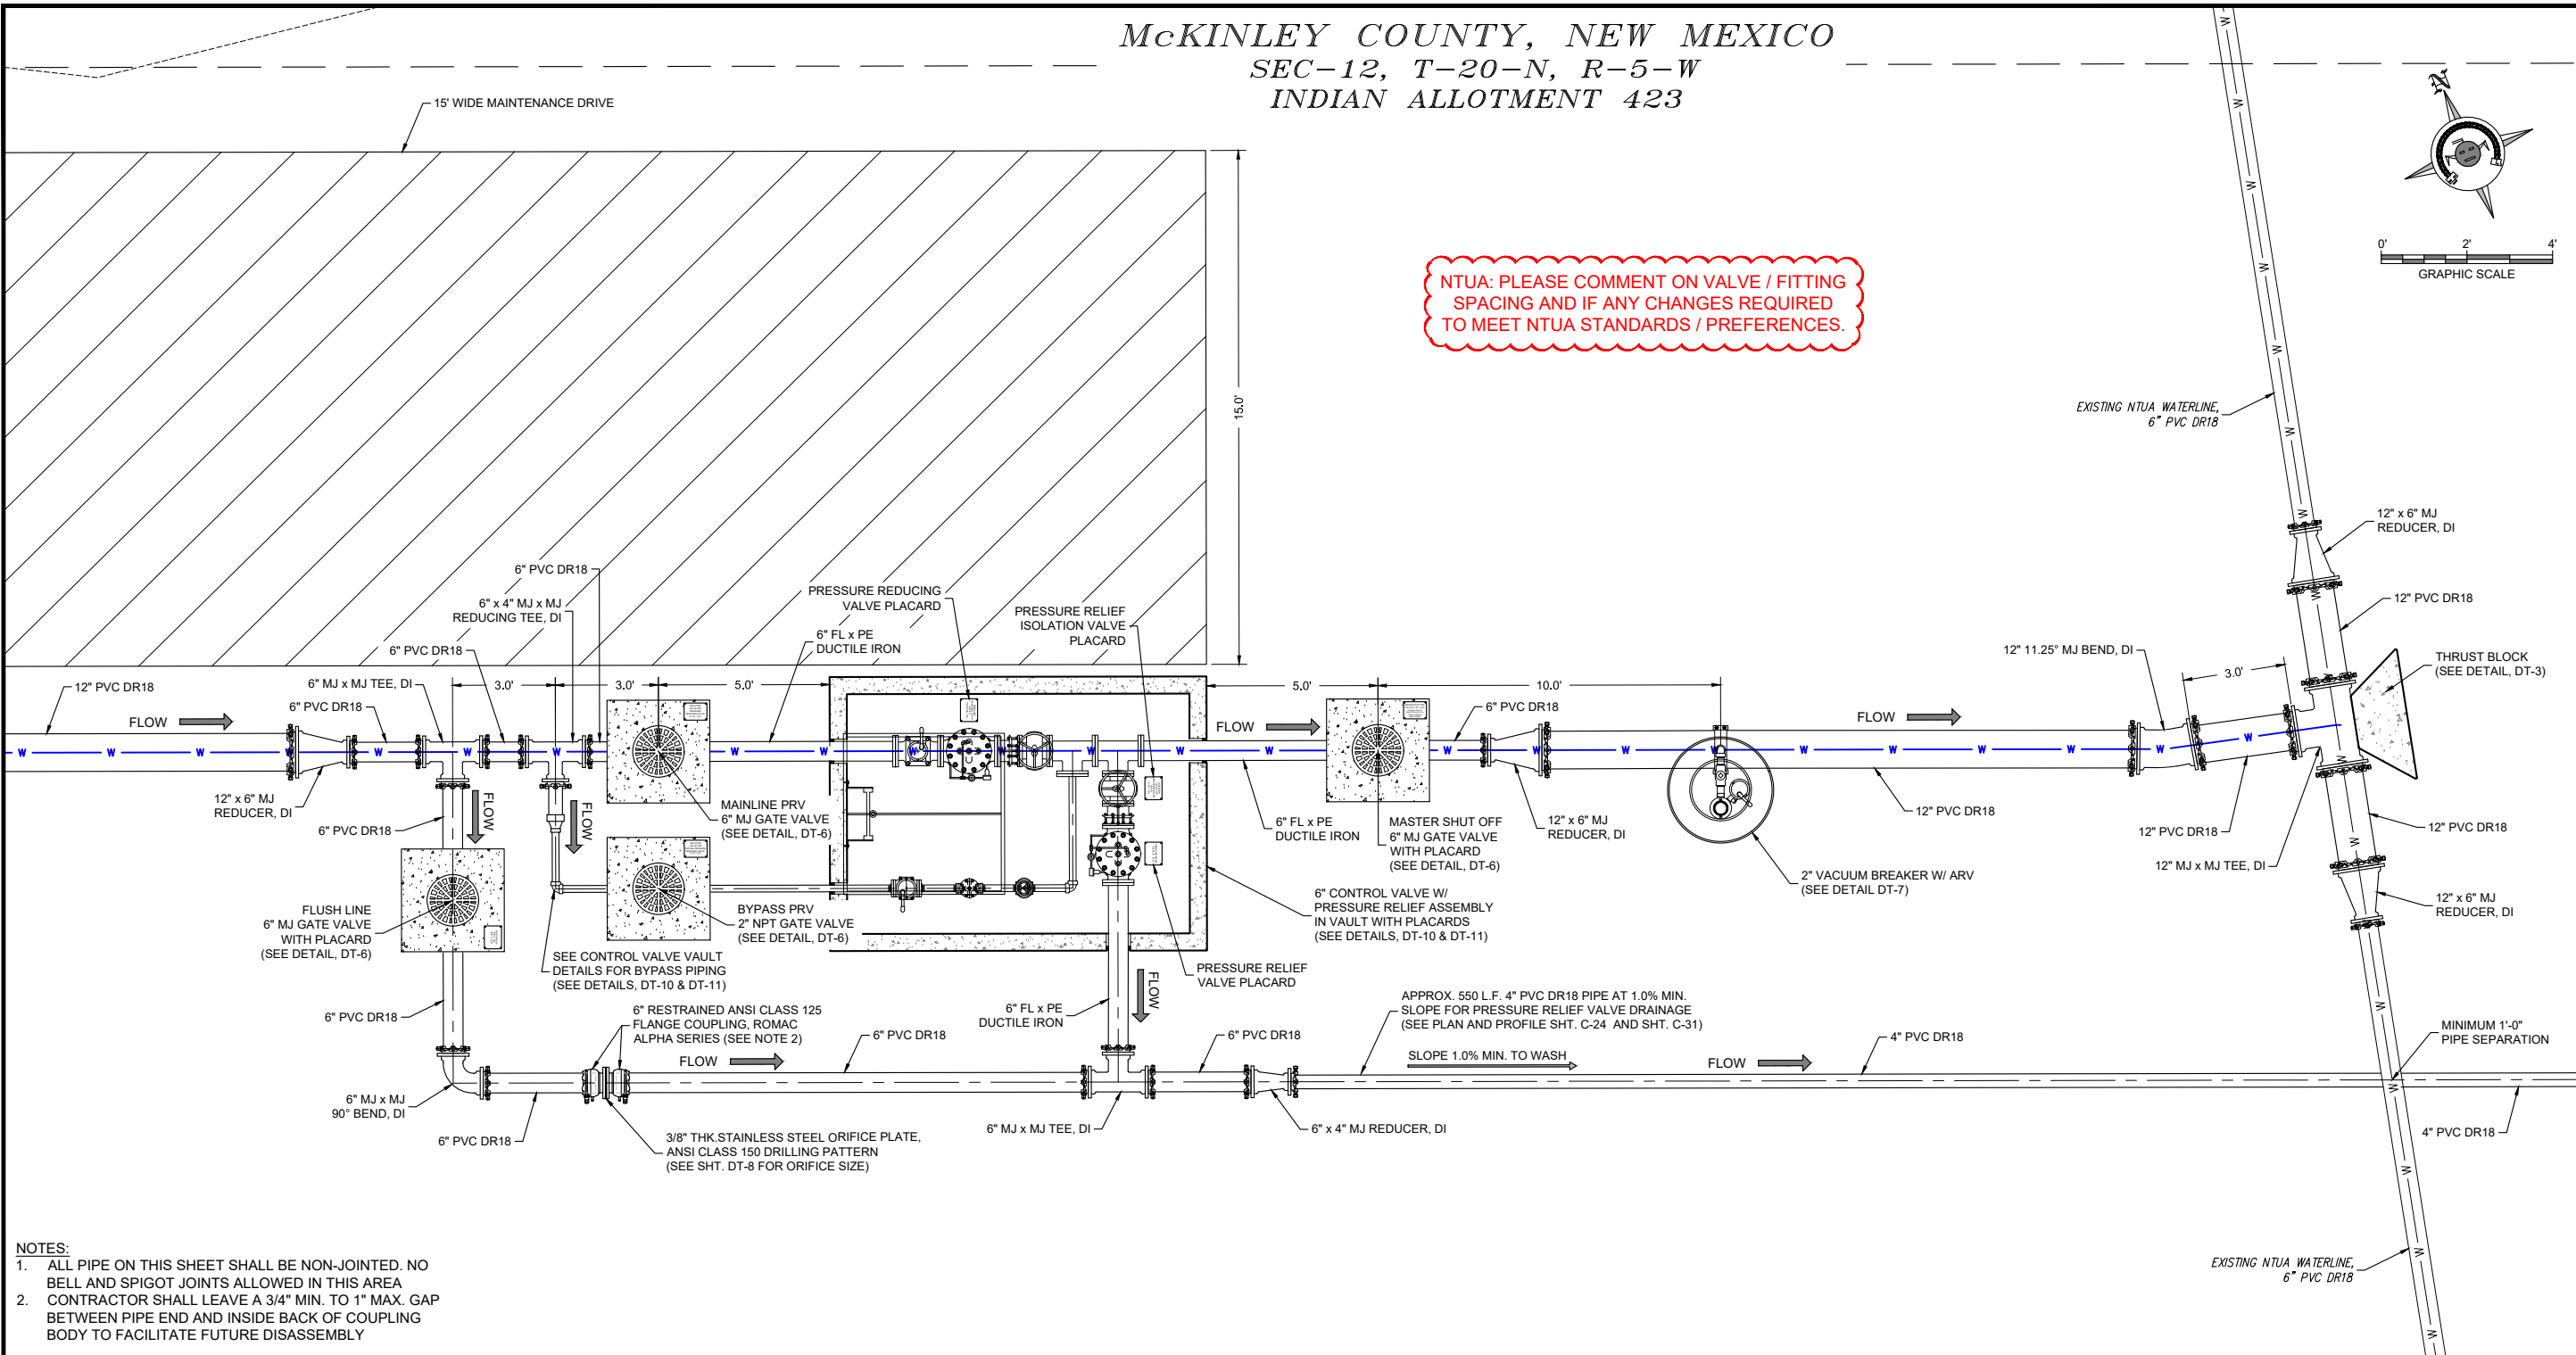


NOTES:

1. ALL PIPE ON THIS SHEET SHALL BE NON-JOINTED. NO BELL AND SPIGOT JOINTS ALLOWED IN THIS AREA
2. CONTRACTOR SHALL LEAVE A 3/4\"/>

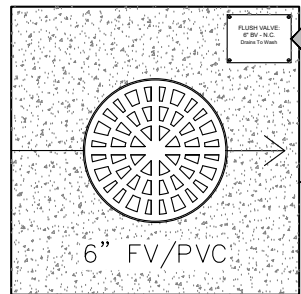

NOTE:

1. CONCRETE SHALL BE SCRIBED PRIOR TO CURING OR ETCHED AFTER CURING WITH 4\"/>

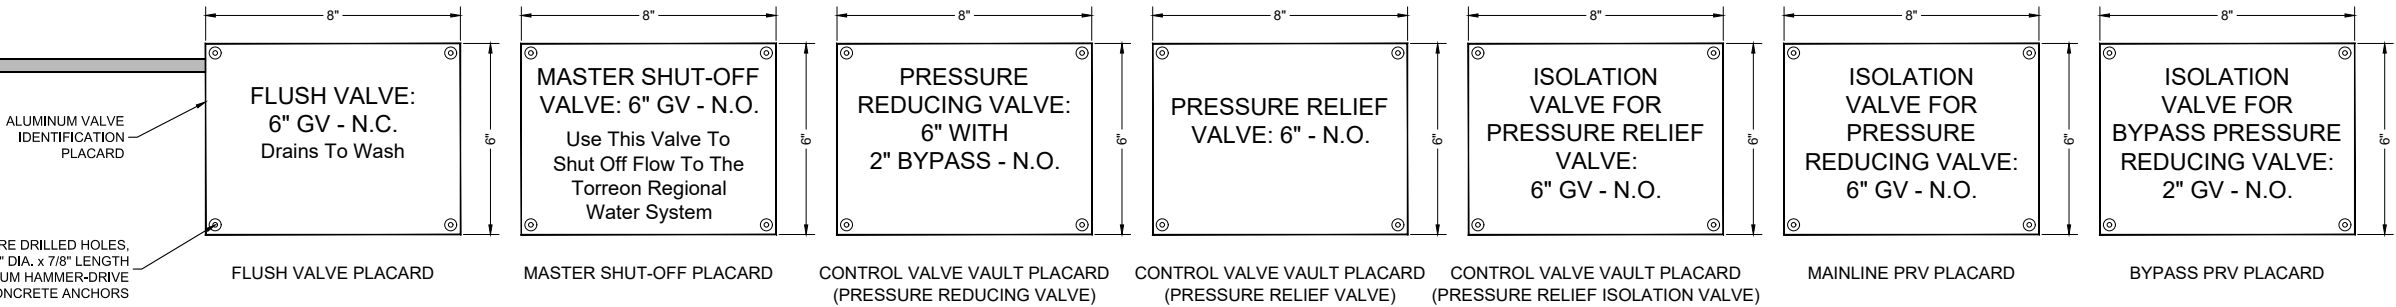

PLACARDS FOR CONTROL VALVE SITE AND
FLUSH VALVE COLLAR SCRIBE DETAIL
NOT TO SCALE

Revision	Date	Description	By	CHK'd

SMA
Engineering & Environmental
Surveying

SOUDEUR, MILLER & ASSOCIATES
5454 VENCE AVENUE NE, SUITE D
ALBUQUERQUE, NM 87113
Phone (505) 299-0942 Toll-Free (877) 299-0942 Fax (505) 293-3430
www.soudermiller.com

Serving the Southwest & Rocky Mountains
Albuquerque, Carlsbad, Hobbs, Farmington, Las Cruces, Roswell, Santa Fe, NM
Cortez, Grand Junction, CO - Safford, AZ - Moab, UT - El Paso, TX

CLIENT: The Navajo Nation
TOWN: Reach 26.3 To Torreon, NM

**REACH 26.3 CONTROL VALVE SITE
PIPING AND CONNECTION PLAN**

**NAVAJO GALLUP WATER SUPPLY
PROJECT - REACH 26.3**

SANDOVAL & MCKINLEY COUNTIES, NEW MEXICO

Designed TTT	Drawn MVT/AAV	Checked AGR
-----------------	------------------	----------------

90%
DRAFT

PRELIMINARY
NOT FOR CONSTRUCTION

THIS DRAWING IS INCOMPLETE
AND NOT TO BE USED FOR
CONSTRUCTION UNLESS IT IS
STAMPED, SIGNED AND DATED

**NOTICE OF EXTENDED
PAYMENT PROVISION:**
THIS CONTRACT ALLOWS THE
OWNER TO MAKE PAYMENT
WITHIN 45 DAYS AFTER
SUBMISSION OF
AN UNDISPUTED REQUEST
FOR PAYMENT.



Date: September 27, 2018

Scale: Horiz: 1" = 4'
Vert: N/A

Project No: 6921307

Sheet: C-32


1. SOIL CEMENT SLURRY MAY BE USED IN LIEU OF COMPACTED SELECT MATERIAL AT CONTRACTOR'S OPTION AND EXPENSE.
2. ANY SECTION OF PIPE EMBEDDED IN COMPACTED SELECT MATERIAL THAT FAILS TO MEET SOIL CLASSIFICATION AND/OR COMPACTION REQUIREMENTS SHALL BE DUG UP, RE-BURIED, RE-COMPACTED AND RE-TESTED AT CONTRACTOR'S SOLE EXPENSE.
3. MINIMUM CLEARANCES BETWEEN PIPE AND TRENCH WALL MUST BE MET PRIOR TO PLACING EMBEDMENT (WHETHER COMPACTED SELECT MATERIAL OR SOIL CEMENT SLURRY). INCREASE CLEARANCES AND/OR TRENCH WIDTH AS NEEDED TO ALLOW FOR COMPACTION AND/OR TO ENSURE ADEQUATE SOIL CEMENT SLURRY LAYER THICKNESS IN HAUNCH AREAS AND PIPE SPRING LINE. DO NOT ALLOW PIPE TO REST AGAINST TRENCH WALL.
4. ROUNDED TRENCH BOTTOMS MAY BE USED IN CONJUNCTION WITH SOIL CEMENT SLURRY, PROVIDED THE THICKNESS OF SOIL CEMENT AROUND THE PIPE IS AT NO POINT LESS THAN 3".



NOTES ON COMPACTION:

1. ALL COMPACTION VALUES BASED ON STD. PROCTOR, ASTM D698. SOIL CLASSIFICATIONS BASED ON ASTM D2487.
2. EMBEDMENT WITHIN DRIVING SURFACES OF ALL ROADS, DRIVEWAYS AND PARKING AREAS AS WELL AS GAS LINES ROW, WASH CROSSINGS, AROUND VAULTS AND METER CANS SHALL BE COMPACTED TO AT LEAST 95% STD. PROCTOR, REGARDLESS OF SOIL TYPE. SOIL CEMENT MAY BE USED IN LIEU OF COMPACTED SELECT MATERIAL.
3. COMPACTION REQUIRED WHERE SHOWN ON DRAWINGS.




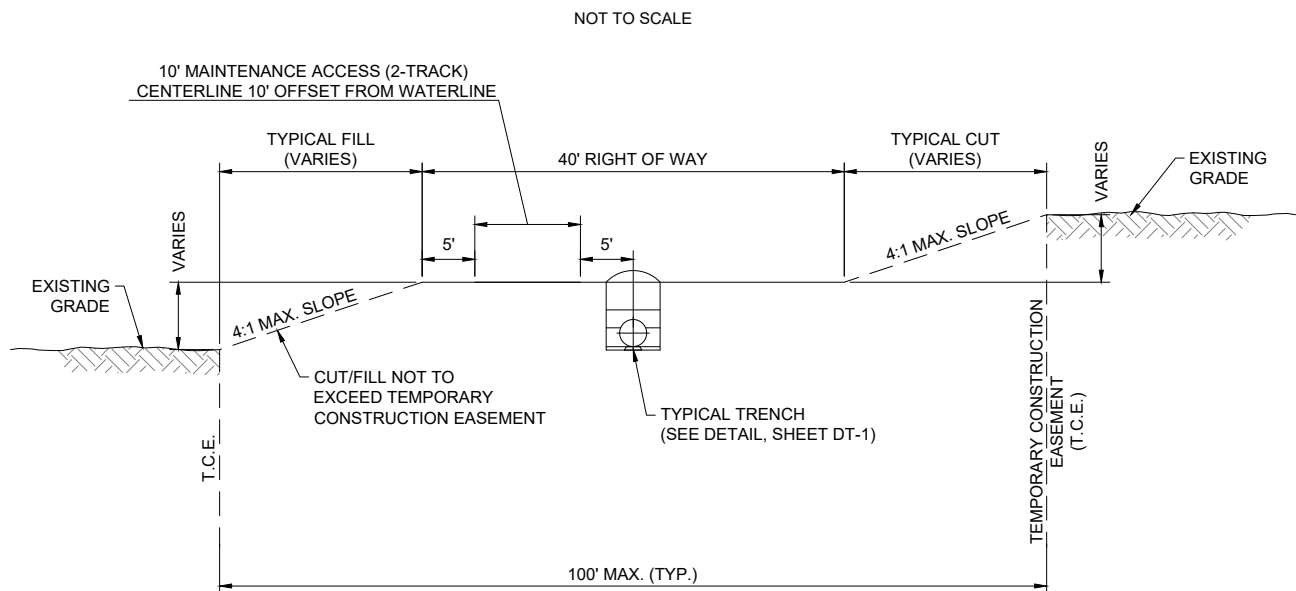




TYPICAL PIPELINE ROW FINISHED GRADING DETAIL
NOT TO SCALE

NOTES:

1. ALL DISTURBED EARTH SHALL BE COMPACTED AND RESEED AS REQUIRED PER DT-1 AND SPECIFICATIONS.
2. TOTAL WIDTH REDUCED IN AREAS WHERE TEMPORARY CONSTRUCTION EASEMENT IS TRUNCATED DUE TO ADJACENT CULTURALLY SENSITIVE AREAS, ROADWAYS, PRIVATE PROPERTIES, ETC.
3. FINAL GRADING AND SLOPE STABILIZATION MUST BE APPROVED BY ENGINEER AND BLM.

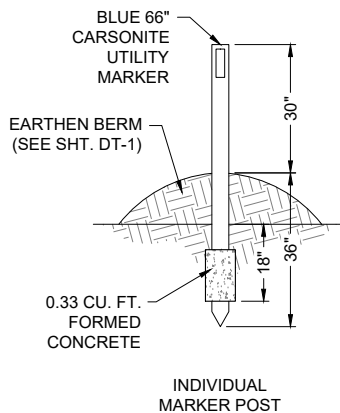

- NOTE:
1. CARSONITE UTILITY MARKER ON ALL P.I.'S AND GRADE CHANGES.
 2. MAXIMUM DISTANCE BETWEEN CARSONITE UTILITY MARKERS SHALL BE 1500 LF.

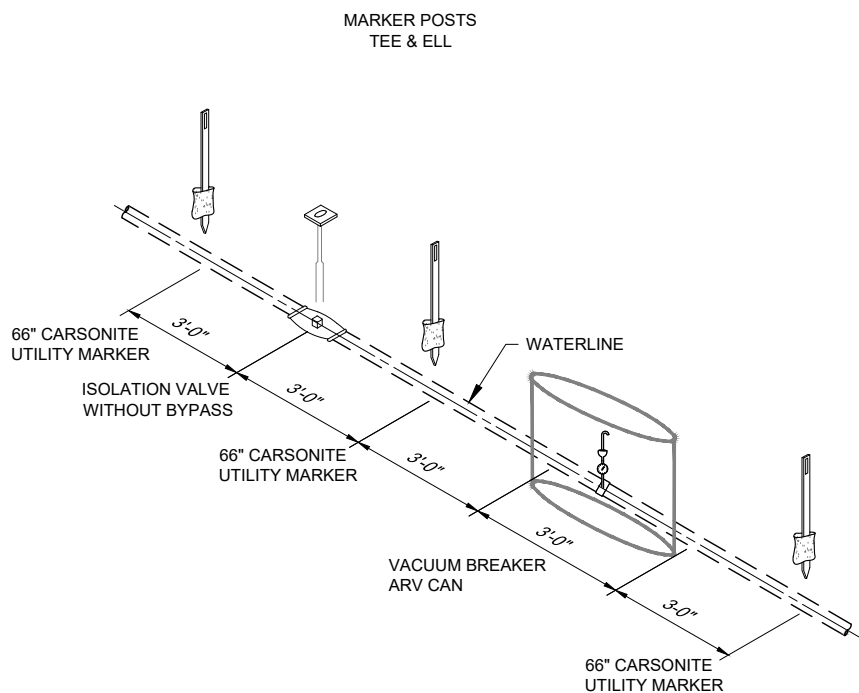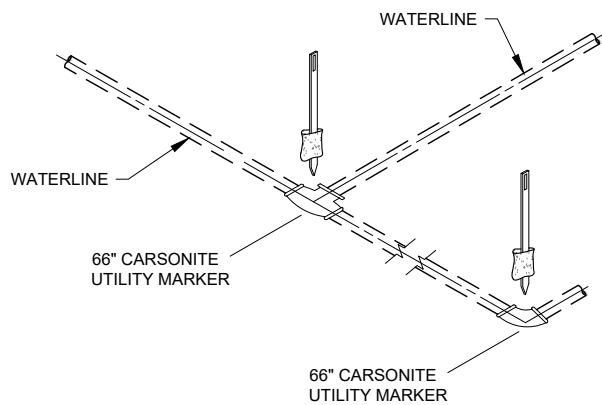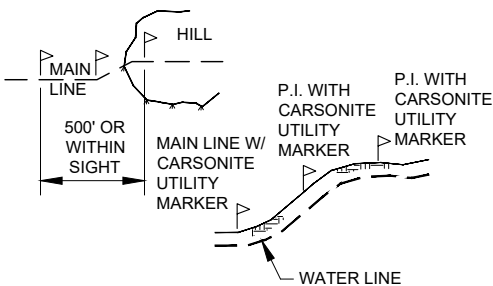

MARKER POSTS
GATE VALVE & VACUUM
BREAKER / ARV VAULT

TYPICAL MARKER POSTS
NOT TO SCALE

Revision	Date	Description	By	Chk'd

SMA
Engineering & Environmental Surveying

SOUDER, MILLER & ASSOCIATES
5454 VENCE AVENUE, SUITE D
ALBUQUERQUE, NM 87113
Phone (505) 299-0942 Toll-Free (877) 299-0942 Fax (505) 293-3430
www.soudermiller.com

Serving the Southwest & Rocky Mountains
Albuquerque, Carlsbad, Hobbs, Farmington, Las Cruces, Roswell, Santa Fe, NM
Cortez, Grand Junction, CO - Safford, AZ - Moab, UT - El Paso, TX

CLIENT: The Navajo Nation TOWN: Reach 26.3 To Turren, NM

MISCELLANEOUS CONSTRUCTION DETAILS

NAVAJO GALLUP WATER SUPPLY PROJECT - REACH 26.3

SANDOVAL & MCKINLEY COUNTIES, NEW MEXICO

Designed TTT	Drawn AAV	Checked AGR
-----------------	--------------	----------------

90% REVIEW
DRAFT

PRELIMINARY
NOT FOR CONSTRUCTION

THIS DRAWING IS INCOMPLETE AND NOT TO BE USED FOR CONSTRUCTION UNLESS IT IS STAMPED, SIGNED AND DATED.

NOTICE OF EXTENDED PAYMENT PROVISION:
THIS CONTRACT ALLOWS THE OWNER TO MAKE PAYMENT WITHIN 45 DAYS AFTER SUBMISSION OF AN UNDISPUTED REQUEST FOR PAYMENT.

811 Know what's below. Call before you dig.

Date: September 18, 2018

Scale: Horiz: NONE
Vert: N/A


Project No: 6921307

Sheet: DT-2


THRUST BLOCK DIMENSION SCHEDULE			
Pipe Location	Pipe Size (Inches)	90° Bend H x W	Tee H x W
Reach 26.3 Chlorinator, Inlet & Outlet	8"	4'-0" x 4'-0"	N/A
Flush Valve with Above-Grade Discharge	2"	N/A	1'-0" x 1'-0"
Tee for Torreon Regional Water System Tie-in	6"	N/A	2'-6" x 2'-6"

GENERAL NOTES


1. SOIL BEARING FROM GEO-TEST REPORT NO. 1-71180 DATED JANUARY 8, 2018
2. ALL CONCRETE SHALL BE 3000 psi, MINIMUM COMPRESSIVE STRENGTH IN 28 DAYS

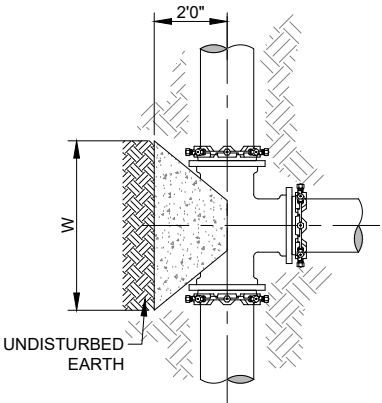


PLAN VIEW
CONCRETE BLOCKING
FOR TEE

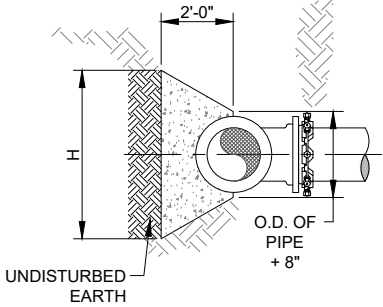

ELEVATION VIEW
CONCRETE BLOCKING
FOR TEE

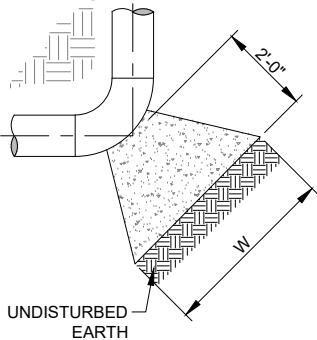

PLAN VIEW
CONCRETE BLOCKING
FOR ELBOW

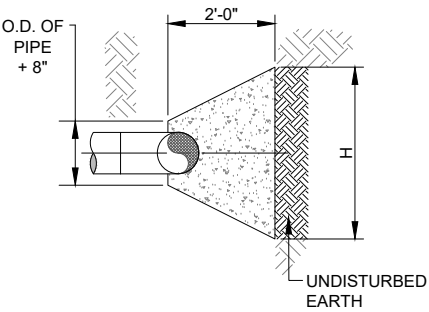

ELEVATION VIEW
CONCRETE BLOCKING
FOR ELBOW


THRUST BLOCK DETAIL
NOT TO SCALE

Minimum Required Restraint Lengths Reach 26.3 - 10" DR18 PVC			
Fitting	Pipe Size	Test Pressure (psi)	Required Restraint Length (ft)
Tee	10"	235	40
Isolation Valve / Dead End	10"	235	140
From End of Casing	10"	235	60
Horizontal Bend or Sweep			
90°	10"	235	65
45°	10"	235	30
22.5°	10"	235	20
11.25°	10"	235	20
Vertical Offset or Sweep			Upper Bend Lower Bend
22.5°	10"	235	30 20
11.25°	10"	235	20 20


Minimum Required Restraint Lengths Reach 26.3 - 12" DR18 PVC			
Fitting	Pipe Size	Test Pressure (psi)	Required Restraint Length (ft)
Tee	12"	235	65
Isolation Valve / Dead End	12"	235	165
From End of Casing	12"	235	75
Horizontal Bend or Sweep			
90°	12"	235	75
45°	12"	235	30
22.5°	12"	235	20
11.25°	12"	235	20
Vertical Offset or Sweep			Upper Bend Lower Bend
22.5°	12"	235	35 20
11.25°	12"	235	20 20
Transition			
Reducer	12" x 6"	235	120

NOTES:


1. MECHANICAL JOINT RESTRAINTS SHALL BE RATED TO PIPE PRESSURE RATINGS.
2. MECHANICAL JOINT RESTRAINTS INSTALLED PER MANUFACTURER'S RECOMMENDATIONS.
3. FITTINGS WITHIN TANK SITE AND CONTROL VALVE VAULT SHALL BE MORTAR LINED, BITUMINOUS-COATED AND PE WRAPPED PER SPECIFICATIONS. ALL BURIED METALLIC WATER BEARING COMPONENTS OUTSIDE THESE SITES SHALL BE COATED WITH FUSION BONDED EPOXY, INTERIOR AND EXTERIOR.
4. APPLY CATHODIC PROTECTION TO ALL BURIED METALLIC COMPONENTS LOCATED WITHIN CORROSIVE SOILS ZONES, AS DESIGNATED IN PLANS AND/OR SPECIFICATIONS.
5. ALL RESTRAINED PIPE JOINTS SHALL BE FUSIBLE PVC. NO BELL HARNESS RESTRAINTS SHALL BE ALLOWED.
6. ALL SITE PIPING SHALL BE FULLY RESTRAINED.
7. WHERE MULTIPLE FITTING / VALVE RESTRAINT LENGTHS OVERLAP, THE RESTRAINT LENGTHS FOR EACH APPURTENANCE SHALL BE ADDED TOGETHER, UNLESS OTHERWISE SHOWN ON PLANS.
8. FOR ANY FITTING OR APPURTENANCE NOT EXPRESSLY CALLED OUT IN PLANS, REFER TO THIS SHEET FOR RESTRAINT LENGTH REQUIREMENTS.
9. NO VERTICAL BENDS SHALL BE ALLOWED THAT ARE NOT SHOWN ON DRAWINGS WITHOUT ENGINEER'S PRIOR APPROVAL. IN THE EVENT VERTICAL BENDS ARE ADDED, ADDITIONAL JOINT RESTRAINT SHALL BE REQUIRED AT CONTRACTOR'S EXPENSE.
10. FOR RESTRAINED LENGTHS 20 LF OR LESS, JOINTED PVC PIPE MAY BE USED IN LIEU OF FUSIBLE PVC, PROVIDED THE ENTIRE PIPE IS A SINGLE STICK.

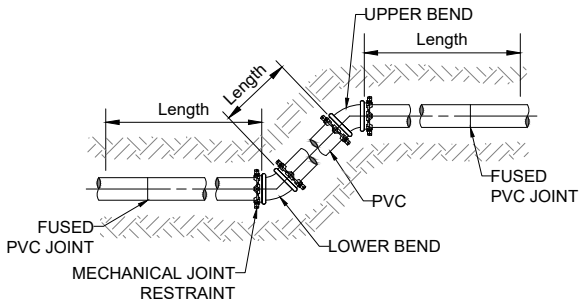


ELEVATION VIEW
MECHANICAL JOINT RESTRAINT FOR VERTICAL OFFSET

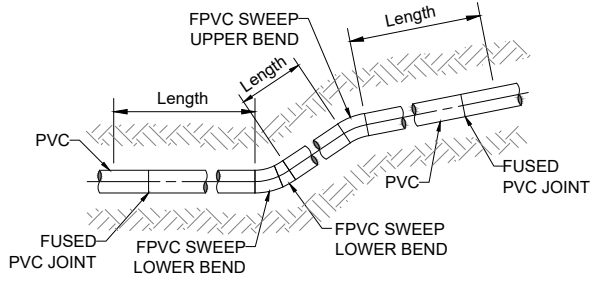


ELEVATION VIEW
FUSED JOINT RESTRAINT FOR VERTICAL SWEEP

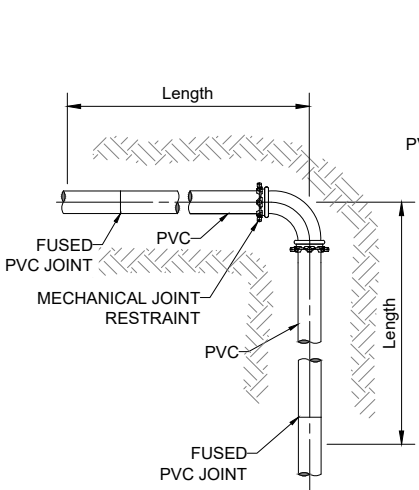


PLAN VIEW
MECHANICAL JOINT RESTRAINT
FOR HORIZONTAL BEND

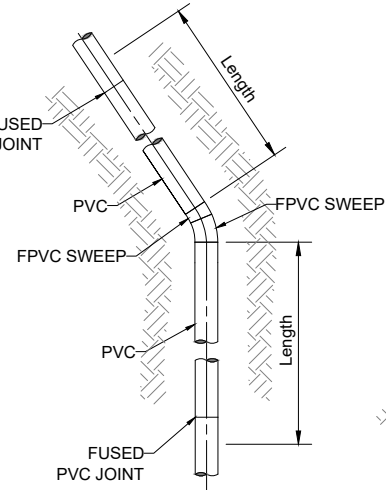


PLAN VIEW
FUSED JOINT RESTRAINT
FOR HORIZONTAL SWEEP

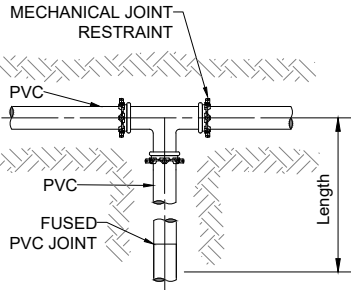


PLAN VIEW
MECHANICAL JOINT RESTRAINT
FOR TEE

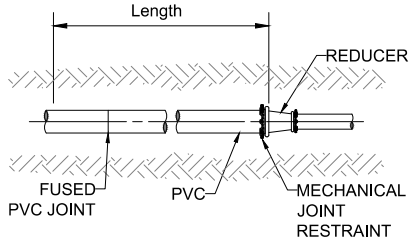

PLAN VIEW
MECHANICAL JOINT RESTRAINT
FOR REDUCERS

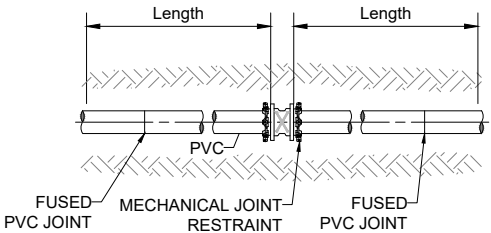

PLAN VIEW
MECHANICAL JOINT RESTRAINT
FOR GATE VALVE

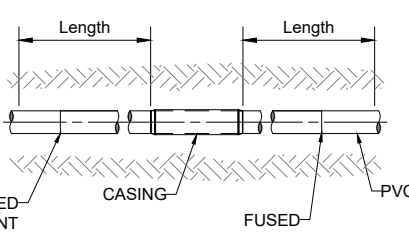

PLAN VIEW
FUSED JOINT RESTRAINT
FOR CASING

MECHANICAL / FUSED JOINT RESTRAINTS
NOT TO SCALE

Revision: Date: By: Check: Description:

SOUDER, MILLER & ASSOCIATES

5454 VANCE AVENUE, SUITE D

ALBUQUERQUE, NM 87113

Phone (505) 299-0942 Toll-Free (877) 299-0942 Fax (505) 293-3430

www.soudermiller.com

Serving the Southwest & Rocky Mountains

Albuquerque, Carlsbad, Hobbs, Farmington, Las Cruces, Roswell, Santa Fe, NM

Conter, Grand Junction, CO - Safford, AZ - Moab, UT - El Paso, TX

360/2018 6/27/2018 per mls

Engineering & Surveying

SMA

CLIENT: The Navajo Nation TOWN: Reach 26.3 To Torreon, NM

THRUST BLOCK AND MECHANICAL JOINT RESTRAINT DETAILS

NAVAJO GALLUP WATER SUPPLY PROJECT - REACH 26.3

SANDOVAL & MCKINLEY COUNTIES, NEW MEXICO

Designed: GYQ Drawn: AAV Checked: AGR

90% REVIEW
DRAFT

PRELIMINARY
NOT FOR CONSTRUCTION

THIS DRAWING IS INCOMPLETE AND NOT TO BE USED FOR CONSTRUCTION UNLESS IT IS STAMPED, SIGNED AND DATED

NOTICE OF EXTENDED PAYMENT PROVISION: THIS CONTRACT PROVIDES THE OWNER TO MAKE PAYMENT WITHIN 45 DAYS AFTER SUBMISSION OF AN UNDISPUTED REQUEST FOR PAYMENT.

811 Know what's below. Call before you dig.

Date: September 6, 2018


Scale: Horiz: NONE Vert: N/A

Project No: 6921307

Sheet: DT-3




Sheet: DT-4

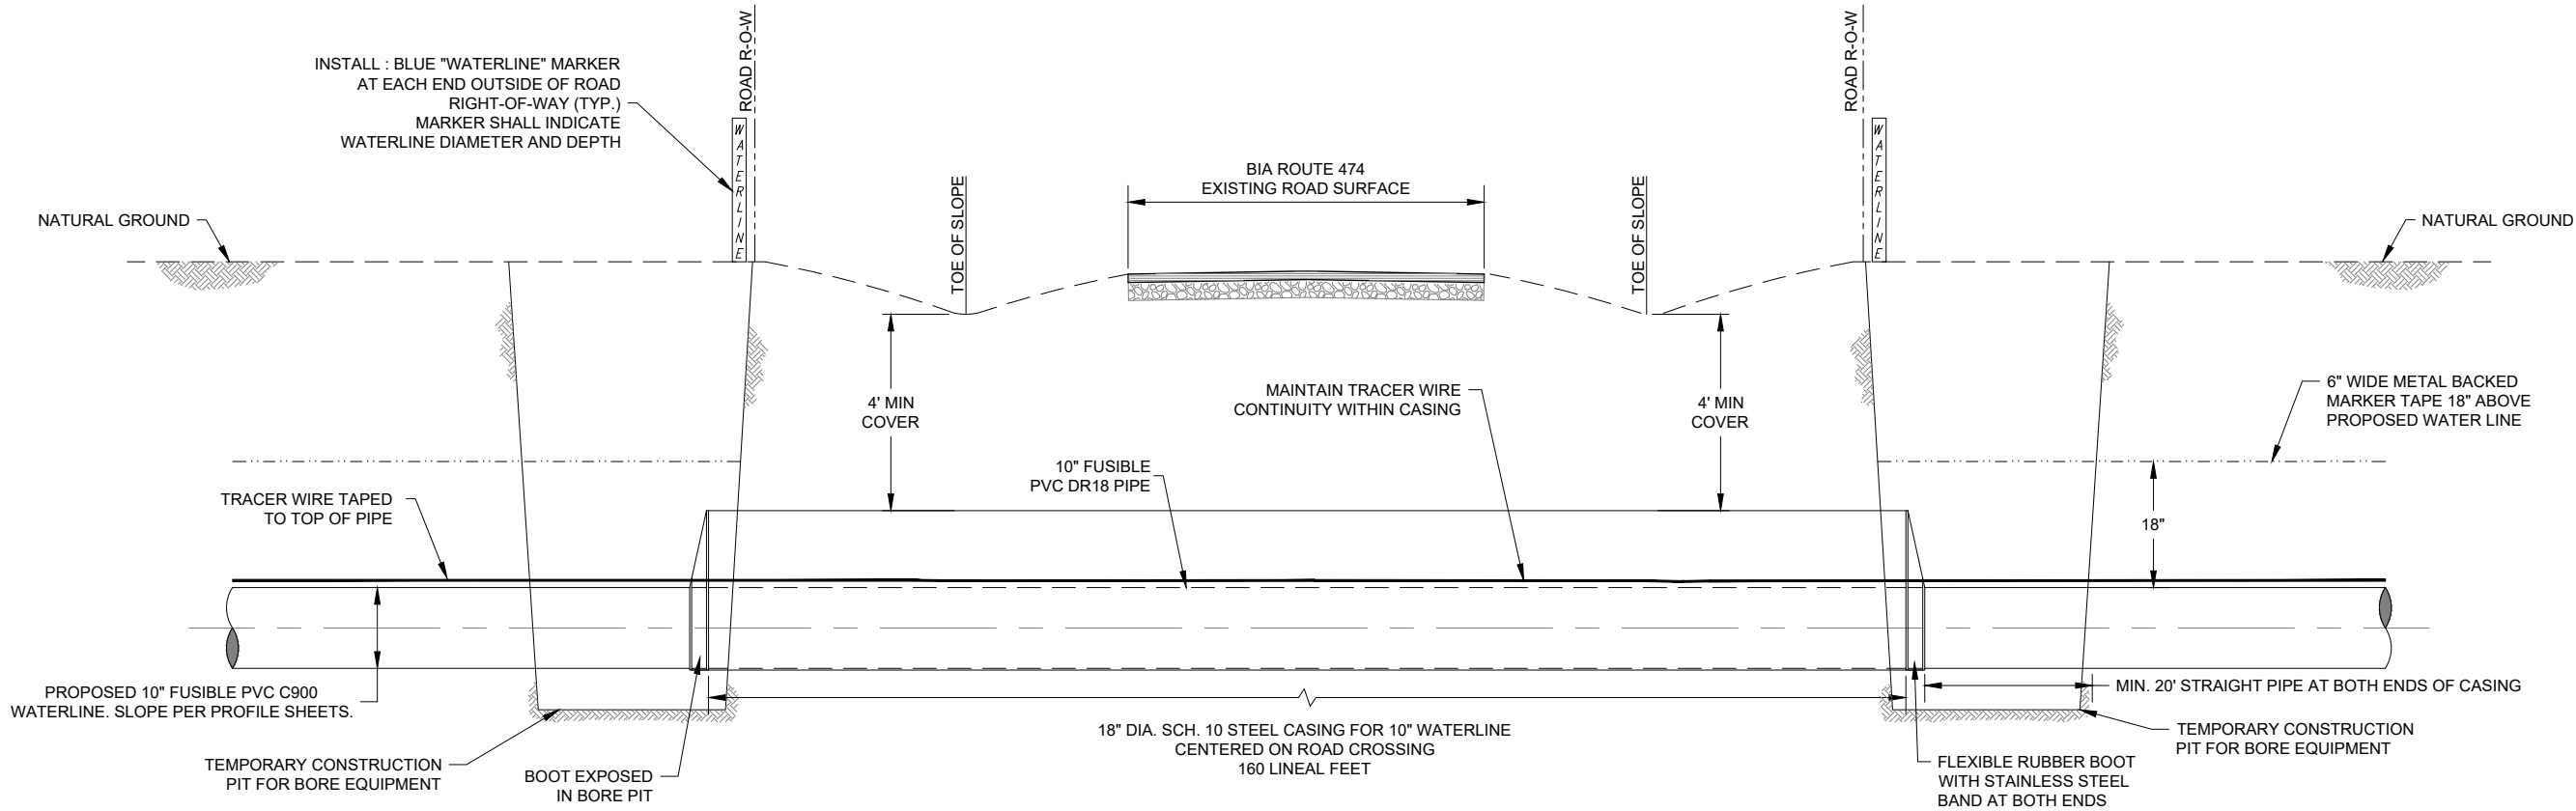

BIA ROUTE 474 BORE AND JACK ROAD CROSSING

NOT TO SCALE

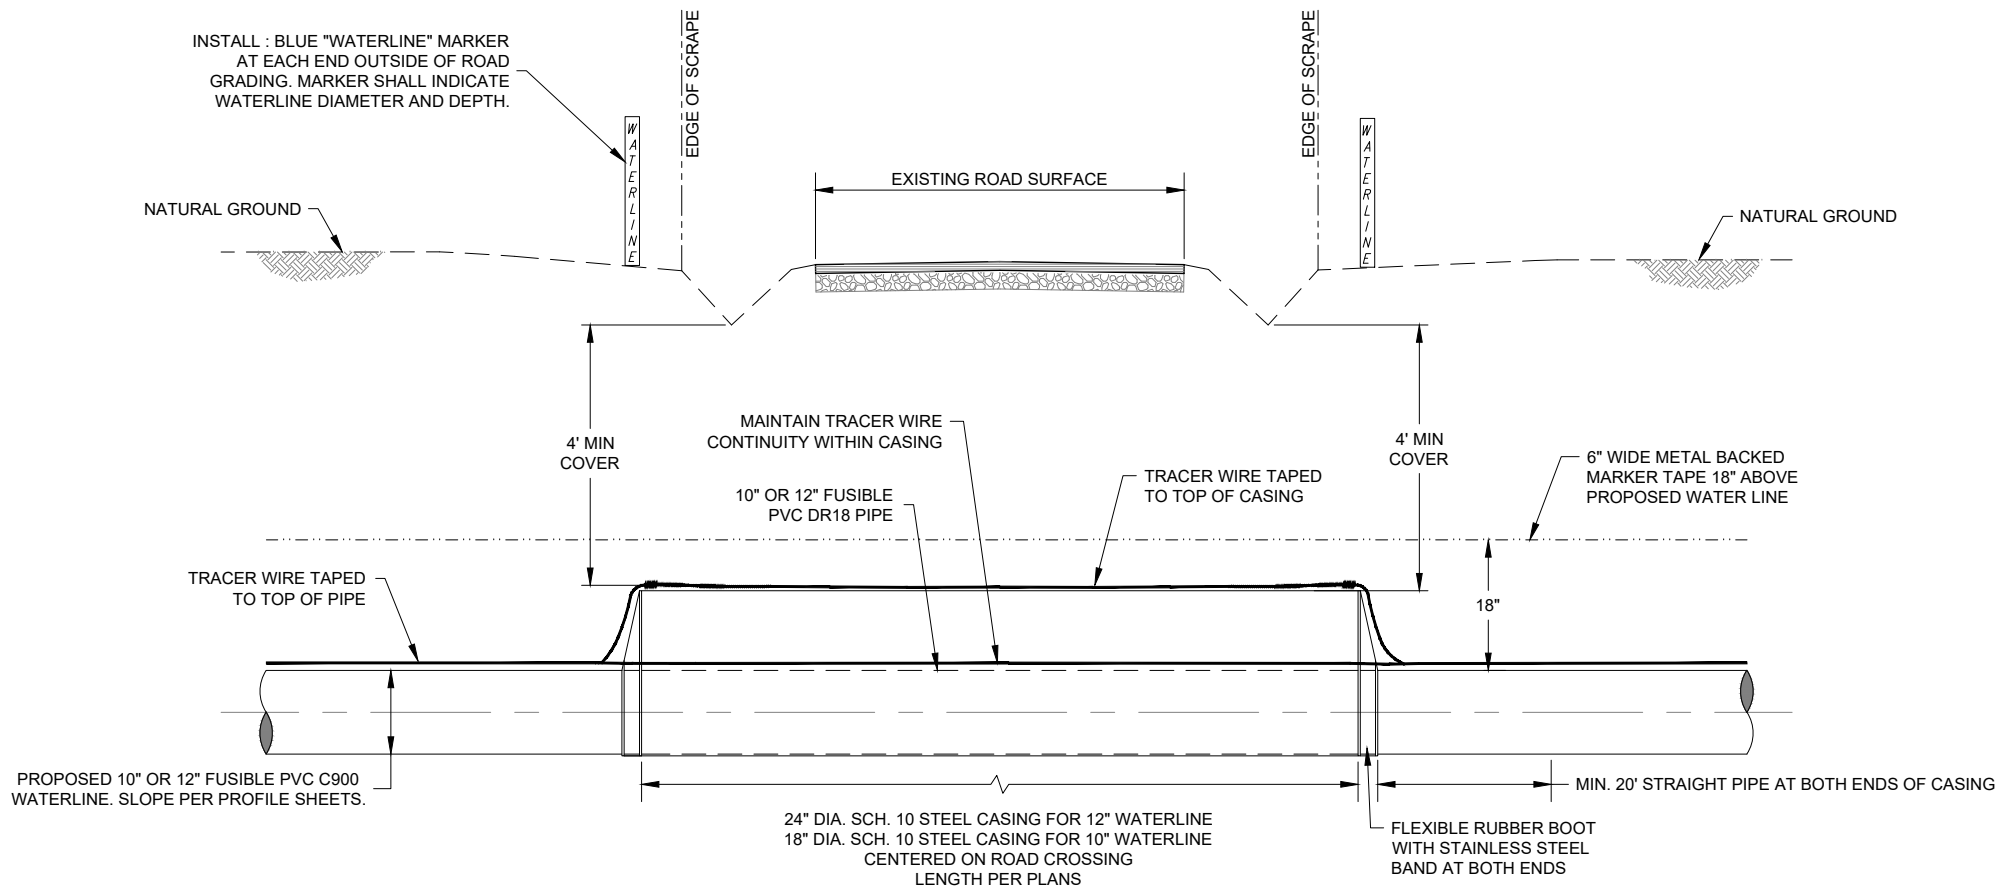

TYPICAL OPEN CUT ROAD CROSSING

NOT TO SCALE

CONSTRUCTION NOTES:

- EXCAVATIONS OUTSIDE THE ROADWAY BAR DITCH SHALL BE COMPACTED AS SPECIFIED IN THE CONSTRUCTION DOCUMENTS. EXCAVATION WITHIN THE TOE OF THE BAR DITCH SHALL BE COMPACTED TO 95% MAXIMUM DRY DENSITY (STANDARD PROCTOR).
- APPLY CATHODIC PROTECTION TO ALL BURIED METALLIC CASINGS LOCATED WITHIN CORROSIVE SOIL ZONES, AS DESIGNATED IN THE PLANS AND/OR SPECIFICATIONS.
- ALL METALLIC PIPE, WHETHER CATHODICALLY PROTECTED OR NOT, SHALL BE PROVIDED WITH CORROSION MONITORING SYSTEMS.
- TRACER WIRE CONTINUITY SHALL BE MAINTAINED ACROSS THE ROAD XING FOR BOTH OPEN - CUT & BORED CROSSINGS.
- FOR MINIMUM FUSIBLE PVC PIPE RESTRAINTS REQUIREMENTS ON EACH SIDE OF CASING, SEE TABLE SHEET DT-3.
- THE INSIDE OF THE CASING AND THE OUTSIDE OF THE CARRIER PIPE MUST BE FREE OF ANY IRREGULARITIES THAT WOULD CAUSE A POINT LOAD ON CARRIER PIPE. ENGINEER RESERVES THE RIGHT TO REQUIRE SPACERS (MAX. 10' APART) IF CASING OR CARRIER PIPE ARE NOT SUFFICIENTLY SMOOTH AND REGULAR. EXTERIOR WELD BEADS SHALL BE REMOVED FROM FUSIBLE PVC CARRIER PIPE.
- FOR SANDOVAL COUNTY, MCKINLEY COUNTY AND BIA ROADS, ADHERE TO ANY ADDITIONAL CROSSING PERMIT REQUIREMENTS.
- OPEN CUT CASINGS SHALL BE ASPHALTIC COATED PER AWW C104. BORE AND JACK CASINGS, NO COATING REQUIRED.

Revision	Date	Description	By	Check

SMA
Engineering & Surveying
Serving the Southwest & Rocky Mountains
Albuquerque, Carlsbad, Hobbs, Farmington, Las Cruces, Roswell, Santa Fe, NM
Cortez, Grand Junction, CO - Safford, AZ - Moab, UT - El Paso, TX

SOUDER, MILLER & ASSOCIATES
5454 VENCE AVENUE, SUITE D
ALBUQUERQUE, NM 87113
Phone (505) 299-0942 Toll-Free (877) 299-0942 Fax (505) 293-3430
www.soudermiller.com

CLIENT: The Navajo Nation
TOWN: Reach 26.3 To Turren, NM

CASED ROAD CROSSING DETAIL
NAVAJO GALLUP WATER SUPPLY
PROJECT - REACH 26.3
SANDOVAL & MCKINLEY COUNTIES, NEW MEXICO

Designed	Drawn	Checked
GMM	AAV	AGR

90% REVIEW
DRAFT

PRELIMINARY
NOT FOR CONSTRUCTION

THIS DRAWING IS INCOMPLETE
AND NOT TO BE USED FOR
CONSTRUCTION UNLESS IT IS
STAMPED, SIGNED AND DATED

NOTICE OF EXTENDED
PAYMENT PROVISION:
THIS CONTRACT ALLOWS THE
OWNER TO MAKE PAYMENT
WITHIN 45 DAYS AFTER
SUBMISSION OF
AN UNDISPUTED REQUEST
FOR PAYMENT.

811

Know what's
below.
Call before
you dig.


Date: September 27, 2018

Scale: Horiz: NONE
Vert: N/A


Project No: 6921307

Sheet: DT-5

1. CONTRACTOR SHALL SCRIBE ALL CONCRETE VALVE COLLARS, PER DETAILS "B" & "C" THIS SHEET. CONCRETE SHALL BE SCRIBED PRIOR TO CURING OR ETCHED AFTER CURING WITH 4" GRINDER.
2. AFFIX WARNING PLACARD TO VALVE BOX COVER INSIDE METER CAN FOR ALL MAINLINE VALVES.
3. AFFIX ALUMINUM VALVE IDENTIFICATION PLATES TO ALL SITE VALVE COLLARS, PER DETAILS "B" & "C" THIS SHEET. REFER TO SHEET C-30 FOR SITE VALVE-SPECIFIC LABELING.
4. ALL MATERIALS SHALL BE WORKING PRESSURE RATED TO AT LEAST THE PRESSURE RATING OF THE PIPE, UNLESS OTHERWISE NOTED.
5. ALL BURIED VALVES SHALL BE COATED WITH FUSION BONDED EPOXY, INTERIOR AND EXTERIOR.
6. NOTE VALVE ENDS SHALL BE FL x FL, MJ x MJ, OR FL x MJ AS INDICATED ON PLANS.
7. APPLY CATHODIC PROTECTION TO ALL BURIED METALLIC PRESSURE-BEARING COMPONENTS LOCATED WITHIN CORROSIVE SOIL ZONES, AS DESIGNATED IN THE PLANS AND/OR SPECIFICATIONS.
8. FLANGES SHALL BE ANSI CLASS 125 (IRON).
9. INSTALL CARSONITE VALVE MARKERS ON BOTH SIDES OF VALVE, 3'-0" FROM CENTER OF VALVE. SEE DETAIL, SHT. DT-2.

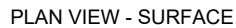



DETAIL "A" TYPICAL TANK SITE VALVE BOX, COLLAR AND
VALVE ID PLACARD DETAIL - USE WITHOUT WARNING PLACARD
NOT TO SCALE

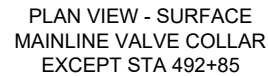


DETAIL "B" TYPICAL MAINLINE VALVE BOX, COLLAR AND
VALVE ID PLACARD DETAIL - USE WITH WARNING PLACARD
NOT TO SCALE



DETAIL "C" TYPICAL WARNING PLACARD DETAIL
NOT TO SCALE

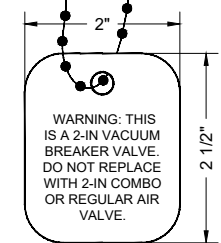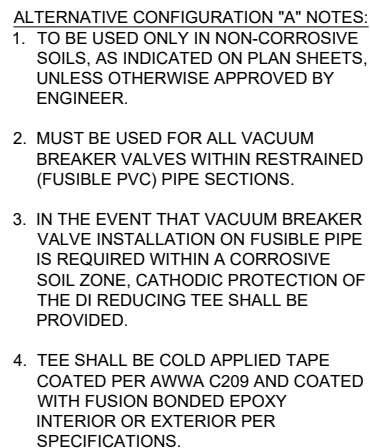

VALVE WARNING TAG DETAIL
(HANG FROM 2" VACUUM BREAKER VALVE)

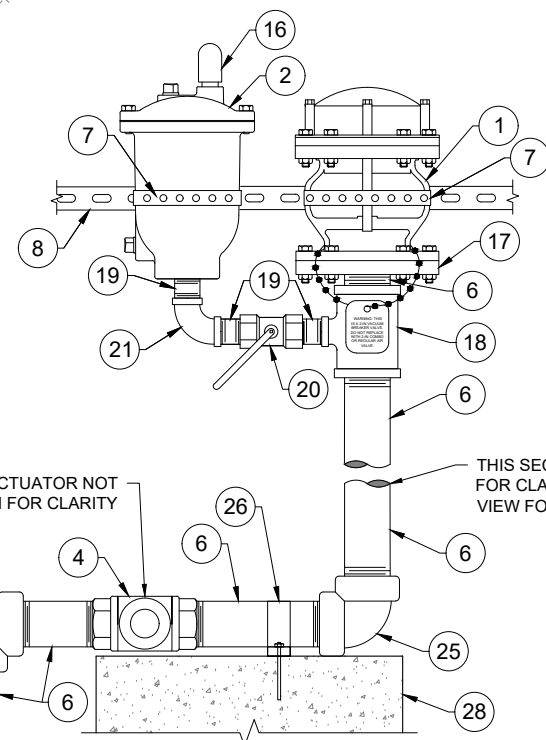


ELEVATION VIEW
VACUUM BREAKER VALVE AND PLUMBING DETAIL
N.T.S.

KEYED NOTES - 2" VACUUM BREAKER WITH 1" AIR RELEASE VALVE	
Item No.	Description
1	2" VALMATIC MODEL NO. 1852VB.3XFSVH VACUUM BREAKER VALVE W/ SCREENED HOOD, ANSI CLASS 250 FLANGE, 400 psi WP
2	1" VALMATIC MODEL NO. 38HPDISVH AIR RELEASE VALVE, 500 psi WP
3	12" x 2" OR 10" x 2" TAPPING SADDLE, D.I. W/ FUSION BONDED NYLON COATING, SS 304 DUAL STRAPS AND SS 304 BOLT KIT, FNPT, ROMAC 202 NS, OAE, 350 psi WP
4	2" BALL VALVE, SS 304, STANDARD PORT, NPT, W/ AUMA WORM GEARBOX W/ SQUARE OPERATING NUT, 1500 psi
5	4" FREEZE PREVENTION DRAFT DAMPENER. VALMATIC FROSTSAFE MODEL #1504, OAE
6	2" NIPPLE, SS 304, NPT
7	GALVANIZED PERFORATED METAL HANGER STRAP
8	1 5/8" GALVANIZED UNI-STRUT (ADJUST AS NEEDED TO FIT BOTH VALVES AND PIPING)
9	2" SS 304 ANCHOR BOLTS, NUTS AND FENDER WASHERS (2x EACH SIDE)
10	2" STD. GALVANIZED IRON PIPE, THREADED END (PIPE EXTERIOR COLD-APPLIED TAPE COATED)
11	2" STD. GALVANIZED IRON PIPE (PIPE EXTERIOR PAINTED BLUE)
12	NOT USED
13	2" GALVANIZED IRON LONG RADIUS WELDED RETURN (PIPE EXTERIOR PAINTED BLUE)
14	4" FLANGED x 2" WELDED GALVANIZED IRON REDUCER (PIPE EXTERIOR PAINTED BLUE)
15	2" GALVANIZED IRON 90° ELBOW, THREADED (PIPE EXTERIOR COLD-APPLIED TAPE COATED)
16	1/2" DOWN SPOUT W/ SCREEN, SCHEDULE 80 PVC
17	2" FLANGE (THREADED), ANSI CLASS 300, SS 304, FLAT FACE
18	2" x 2" x 1" REDUCING TEE, SS 304, NPT, SCHEDULE 40
19	1" x 2" LENGTH NIPPLE, SS 304, NPT
20	1" BALL VALVE, SS 304, NPT, 2000 psi
21	1" 90° ELBOW, SS 304, NPT, SCHEDULE 40
22	12" x 12" x 4" OR 10" x 10" x 4" MJ x MJ REDUCING TEE, D.I., 350 psi WP
23	4" x 2" TAPPED THREADED MJ PLUG, D.I., 350 psi, FBE COATED
24	4" GALVANIZED IRON COMPANION FLANGE, DRILLED TO FIT
25	2" 90° ELBOW, SS 304, NPT, SCHEDULE 40
26	1" WIDE PIPE STRAP, BOLT TO SUPPORT BLOCK (3" BOLTS)
27	VARMINT SCREEN
28	CONCRETE SUPPORT BLOCK, SOLID 8" x 8" x 16"
29	36" DIA. PLASTIC (METER) PIT WITH REMOVABLE FROST LID
30	20" METER PIT LOCKING COVER(CAST IRON)WITH FROST PROOF INNER LID

NOTES:



1. ALL FLANGES SHALL BE FLAT FACED, UNLESS OTHERWISE NOTED.
2. ALL NON-STAINLESS METALLIC PIPE IN CONTACT WITH SOIL SHALL BE COLD APPLIED TAPE-COATED PER AWWA C209.
3. VACUUM BREAKER TO BE LOCATED IN FIELD BY ENGINEER.
4. COIL TRACER WIRE ON INSIDE WALLS AT TOP OF METER PIT.
5. ALL STAINLESS STEEL PIPE AND FITTINGS SHALL HAVE A WORKING PRESSURE OF AT LEAST 350 psi, UNLESS OTHERWISE NOTED.
6. REMOVE ALL PVC CUTTINGS FROM INSIDE MAIN LINE AFTER TAPPING.
7. CONTRACTOR SHALL ATTACH PLACARD TO ALL VACUUM BREAKER METER BOX LIDS, INFORMATION AS FOLLOWS: PIPE STATION, VALVE SIZE, "VB / ARV", PIPE SIZE AND MATERIAL. SEE DETAIL, THIS SHEET.
8. DO NOT TAP FUSIBLE OR RESTRAINED PIPE. USE ALTERNATIVE CONFIGURATION "A" IN LIEU OF TAPPING.
9. APPLY CATHODIC PROTECTION TO ALL NON-STAINLESS METALLIC COMPONENTS IN CONTACT WITH SOIL LOCATED WITHIN CORROSIVE SOIL ZONES, AS DESIGNATED IN THE PLANS AND/OR SPECIFICATIONS.
10. ALL MATERIALS RATED TO AT LEAST THE PIPE PRESSURE RATING UNLESS OTHERWISE NOTED.
11. PIPE SECTION SHALL NOT BE BENT AT VACUUM BREAKER INSTALLATION LOCATIONS, SEE DETAIL THIS SHEET.
12. ENSURE ALL BALL VALVE HANDLES ARE UNIMPEDED THROUGH THEIR FULL RANGE OF MOTION.
13. PROVIDE MIN. 3" HORIZONTAL CLEARANCE ON ALL SIDES AROUND 2" BALL VALVE OPERATING NUT.

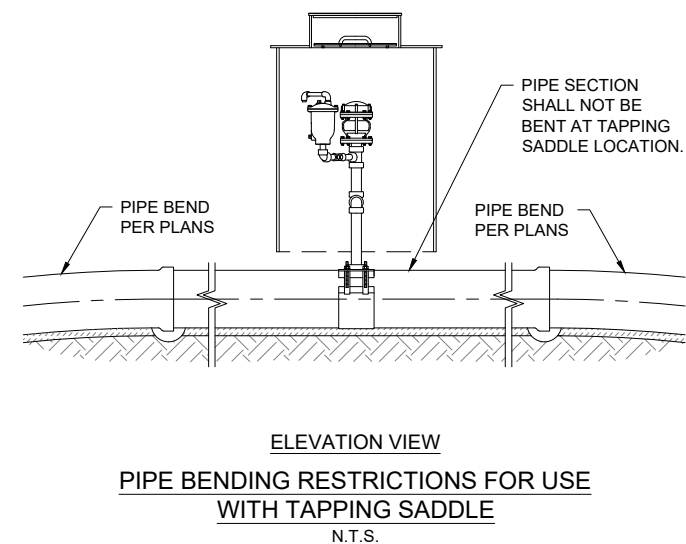



NOTE:
CONCRETE SHALL BE SCRIBED
PRIOR TO CURING OR ETCHED
AFTER CURING WITH A 4" GRINDER.

COLLAR SCRIBING DETAIL
NOT TO SCALE

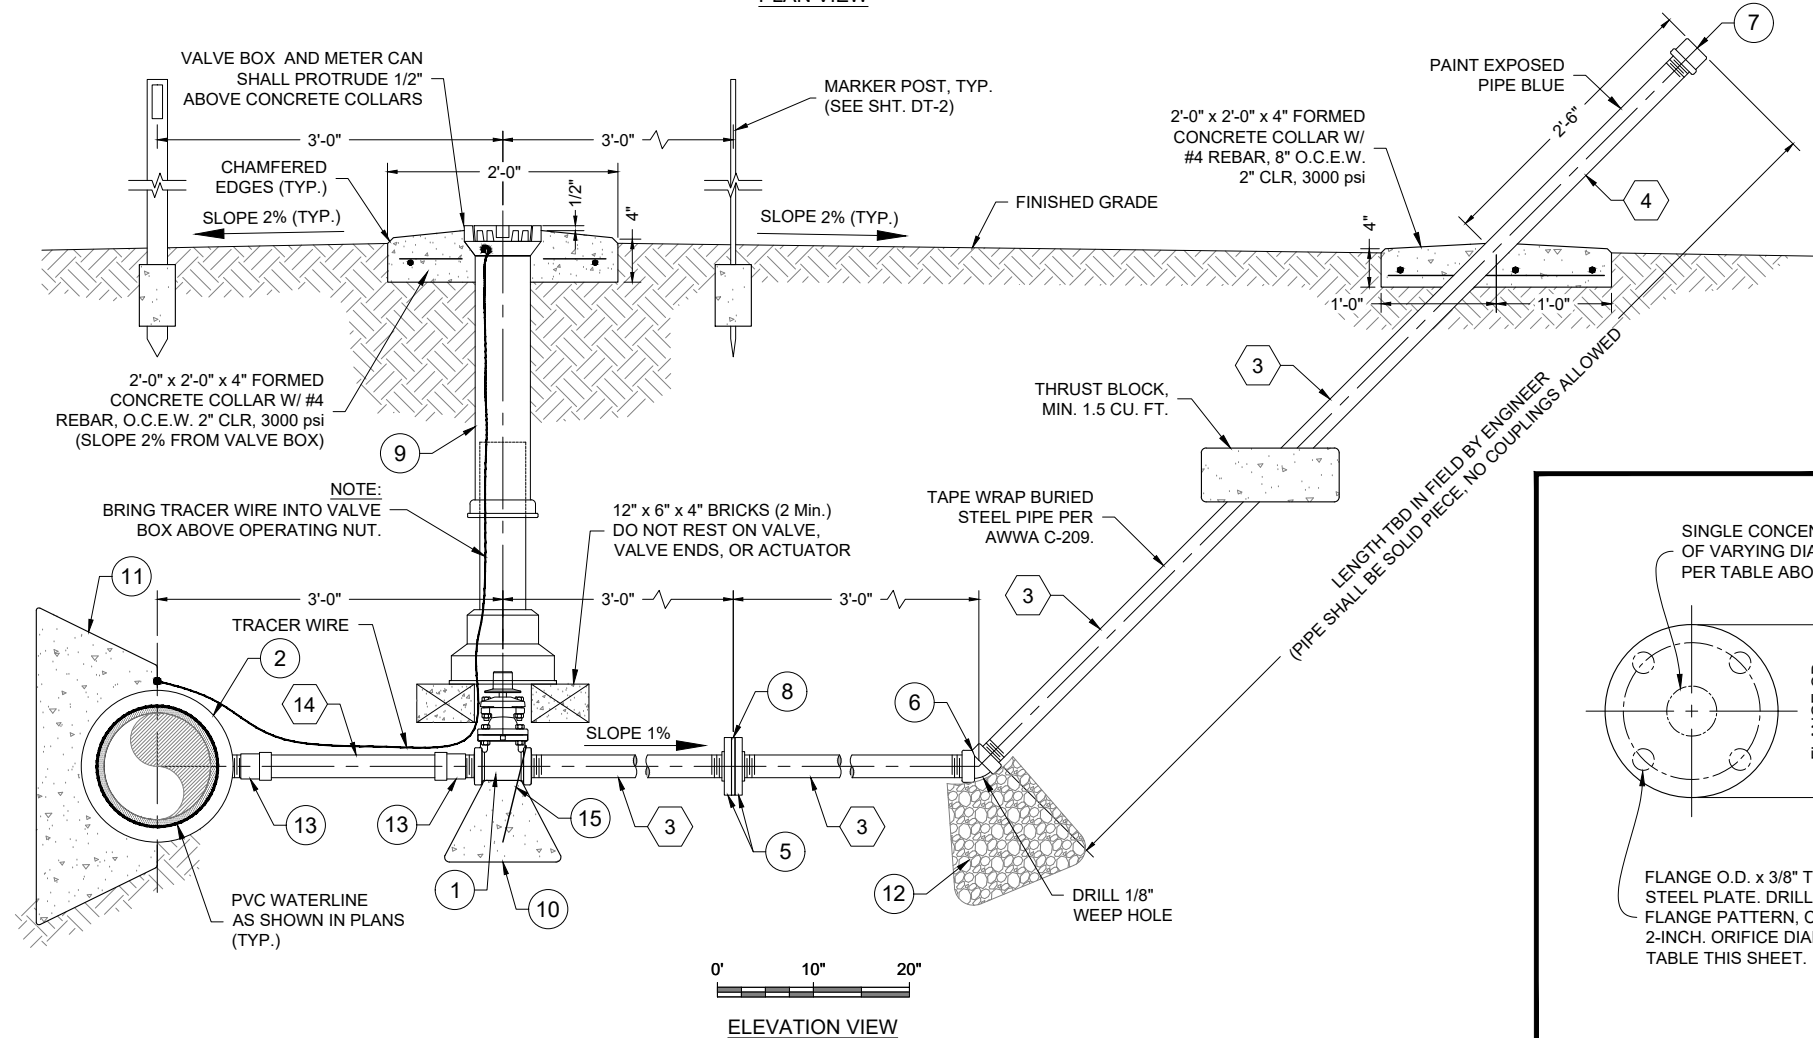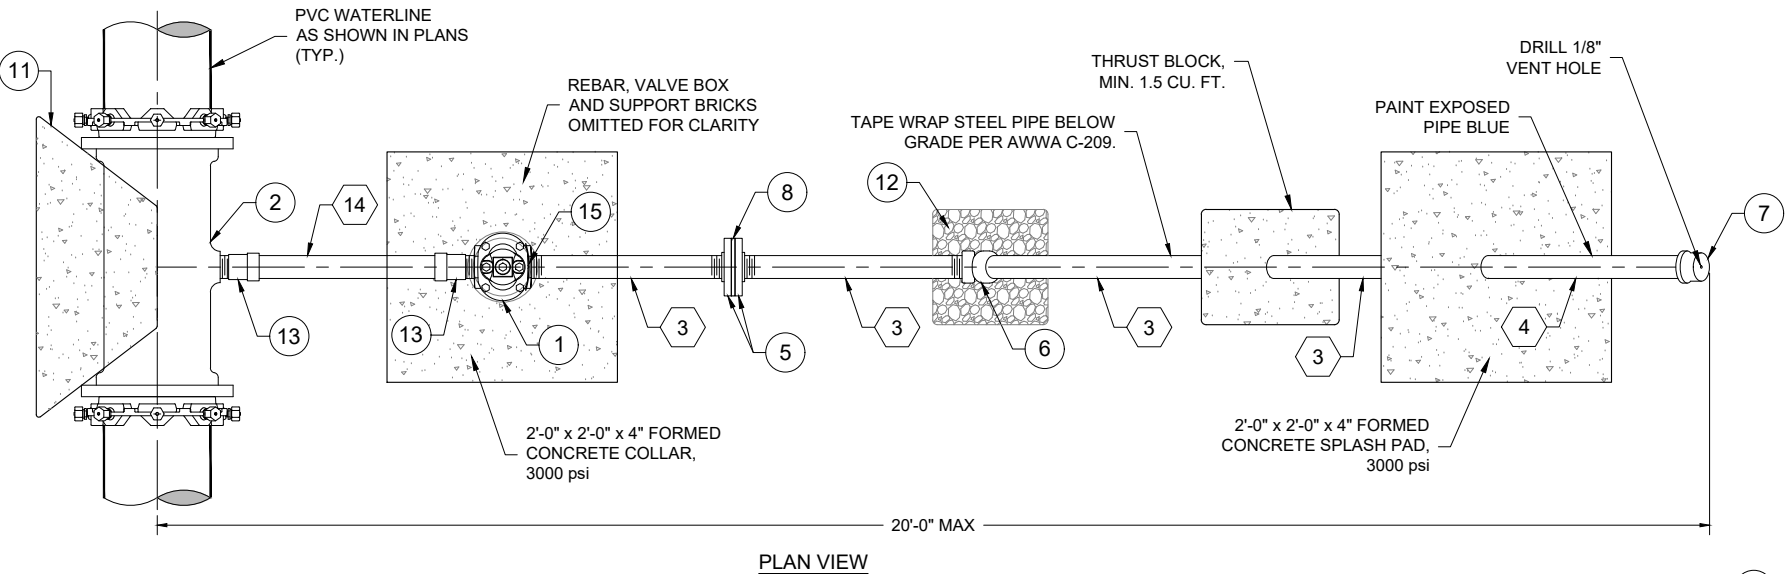

2" FLUSH VALVE WITH ABOVE-GRADE DISCHARGE DETAIL

KEYED NOTES - 2" FLUSH VALVE WITH ABOVE GRADE DISCHARGE


Item No.	DESCRIPTION
1	2" GATE VALVE, FBE COATED, NPT, W/ 2" OPERATING NUT, 250 psi
2	10" x 2" MJ TAPPED TEE, D.I., 350 psi
3	2" G.I. PIPE, STANDARD WALL, NPT, TAPE COATED BELOW GRADE
4	2" G.I. PIPE, STANDARD WALL, NPT, PAINTED BLUE ABOVE GRADE
5	2" G.I.-HUB, FLAT FACED, COMPANION FLANGE, NPT, SS 304, ANSI CLASS 300
6	2" G.I. 45° ELL, NPT, 300 psi
7	2" G.I. CAP, NPT, 300 psi, W/ 1/8" VENT HOLE
8	3/8" THK. STAINLESS STEEL ORIFICE PLATE, ANSI CLASS 300 DRILLING PATTERN (SEE TABLE THIS SHEET FOR ORIFICE SIZE)
9	VALVE BOX SLIP TYPE WITH LOCKING CAST IRON COVER (SEE DETAIL DT-6)
10	1'-0" x 1'-0" x 1'-0" CONCRETE BLOCK, 3000 psi
11	THRUST BLOCK (SEE DETAIL DT-3)
12	ROUNDED ROCK (1.5 CU. YD.)
13	2" ADAPTER, PVC, SLIP-GASKET x NPT, SDR-21, 200 psi
14	2" PVC, SDR-21, 200 psi
15	#4 REBAR RESTRAINT

- NOTES:
- ALL FLANGES SHALL BE ANSI CLASS 300 (STEEL).
 - ALL NON STAINLESS STEEL PIPE AND FITTINGS SHALL BE TWO-PART EPOXY COATED, INTERIOR AND EXTERIOR. ALL NON STAINLESS METALLIC PIPE IN CONTACT WITH SOIL SHALL ALSO BE COLD APPLIED TAPE-COATED PER AWWA C-209 AND SPECIFICATIONS.
 - ORIENTATION AND LOCATION OF OUTLET TO BE DETERMINED IN FIELD BY ENGINEER.
 - APPLY CATHODIC PROTECTION TO ALL BURIED METALLIC WATER-CARRYING COMPONENTS LOCATED WITHIN CORROSIVE SOIL ZONES, AS DESIGNATED IN THE PLANS AND/OR SPECIFICATIONS.
 - ALL STEEL PIPE AND FITTINGS SHALL BE STANDARD WALL.
 - ALL COMPONENTS SHALL REMAIN WITHIN THE 40' PERMANENT RIGHT-OF-WAY.
 - ALL MATERIALS RATED TO AT LEAST MAINLINE PIPE PRESSURE RATING, UNLESS OTHERWISE NOTED.
 - SEE TABLE THIS SHEET FOR ORIFICE PLATE DRILLING AND FLUSH VALVE TYPE REQUIREMENTS.


SUMMARY OF FLUSH VALVE ORIFICE PLATE DRILLING

Station	Elevation	Flush Valve Size	Orifice Plate Hole Ø (in.)
51+41	6934	2"	1.46
118+38	6952	2"	1.46
283+09	6818	2"	1.46
382+93	6780	2"	1.46
433+71	6773	2"	1.46
492+58	6758	6" / 4"	2.38

- NOTES:
- HOLE TO BE DRILLED CENTERED ON THE ORIFICE PLATE.
 - SEE SHT. C-32 FOR 6" ORIFICE PLATE CONNECTION DETAILS.

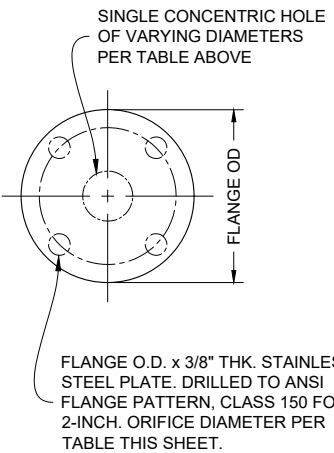

ORIFICE PLATE
NOT TO SCALE

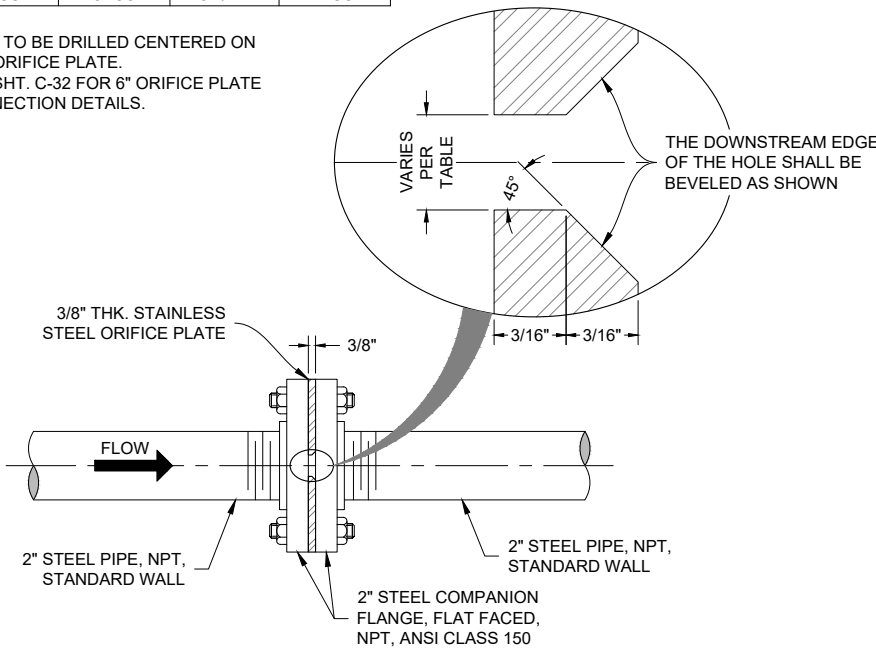

2" FLUSH VALVE

ORIFICE PLATE ASSEMBLY
NOT TO SCALE

Revision	Date	By	CHK'd

SMA
Souder, Miller & Associates
5454 VANCE AVENUE NE, SUITE D
ALBUQUERQUE, NM 87113
Phone (505) 299-0942 Toll-Free (877) 299-0942 Fax (505) 293-3430
www.soudermiller.com
Serving the Southwest & Rocky Mountains
Albuquerque, Carlsbad, Hobbs, Farmington, Las Cruces, Roswell, Santa Fe, NM
Cortez, Grand Junction, CO - Safford, AZ - Moab, UT - El Paso, TX

CLIENT: The Navajo Nation
TOWN: Reach 26.3 To Turren, NM
2 INCH FLUSH WITH ORIFICE AND
ABOVE-GRADE DISCHARGE DETAIL
NAVAJO GALLUP WATER SUPPLY
PROJECT - REACH 26.3
SANDOVAL & MCKINLEY COUNTIES, NEW MEXICO

Designed TTT	Drawn AAV	Checked AGR
-----------------	--------------	----------------

90% REVIEW
DRAFT
PRELIMINARY
NOT FOR CONSTRUCTION

THIS DRAWING IS INCOMPLETE
AND NOT TO BE USED FOR
CONSTRUCTION UNLESS IT IS
STAMPED, SIGNED AND DATED

NOTICE OF EXTENDED
PAYMENT PROVISION:
THIS CONTRACT ALLOWS THE
OWNER TO MAKE PAYMENT
WITHIN 45 DAYS AFTER
SUBMISSION OF
AN UNDISPUTED REQUEST
FOR PAYMENT.


811 Know what's
below.
Call before
you dig.

Date: September 27, 2018


Scale: Horiz: AS SHOWN
Vert: N/A

Project No: 6921307

Sheet: DT-8

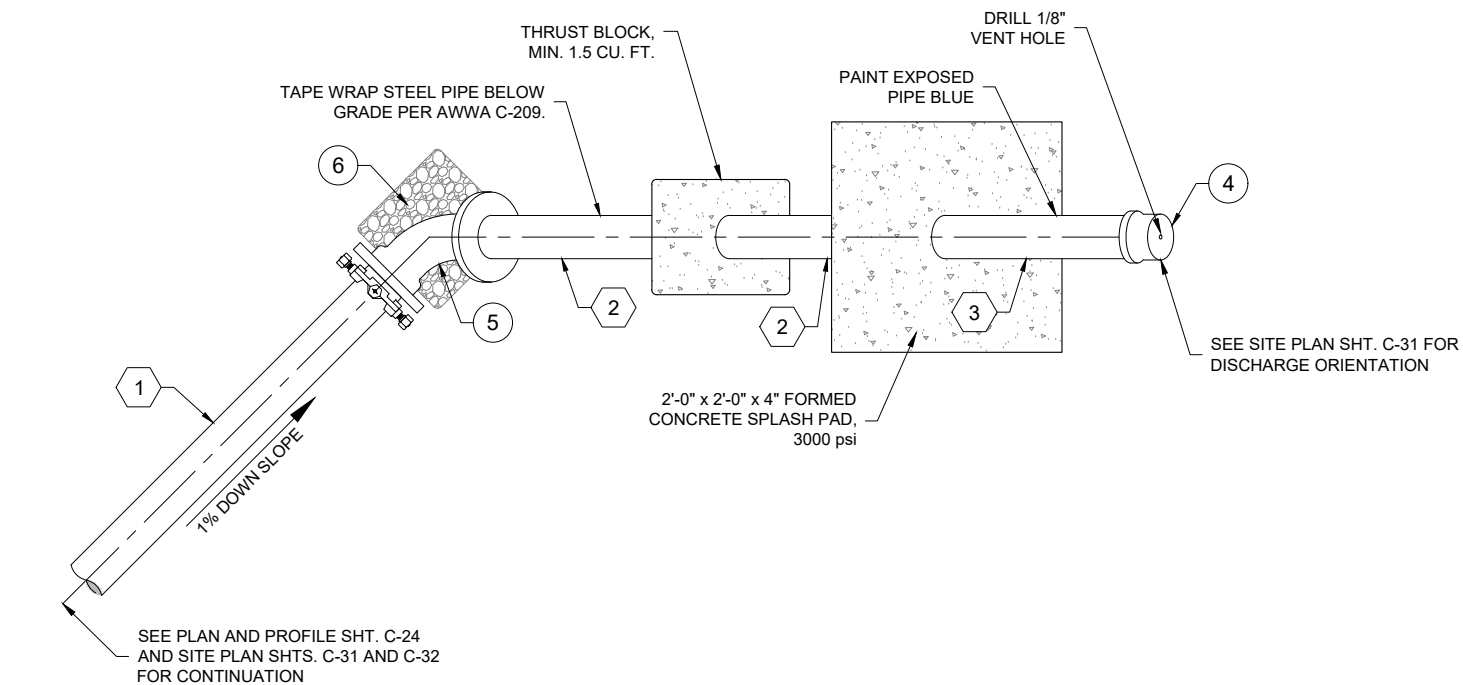

PLAN VIEW

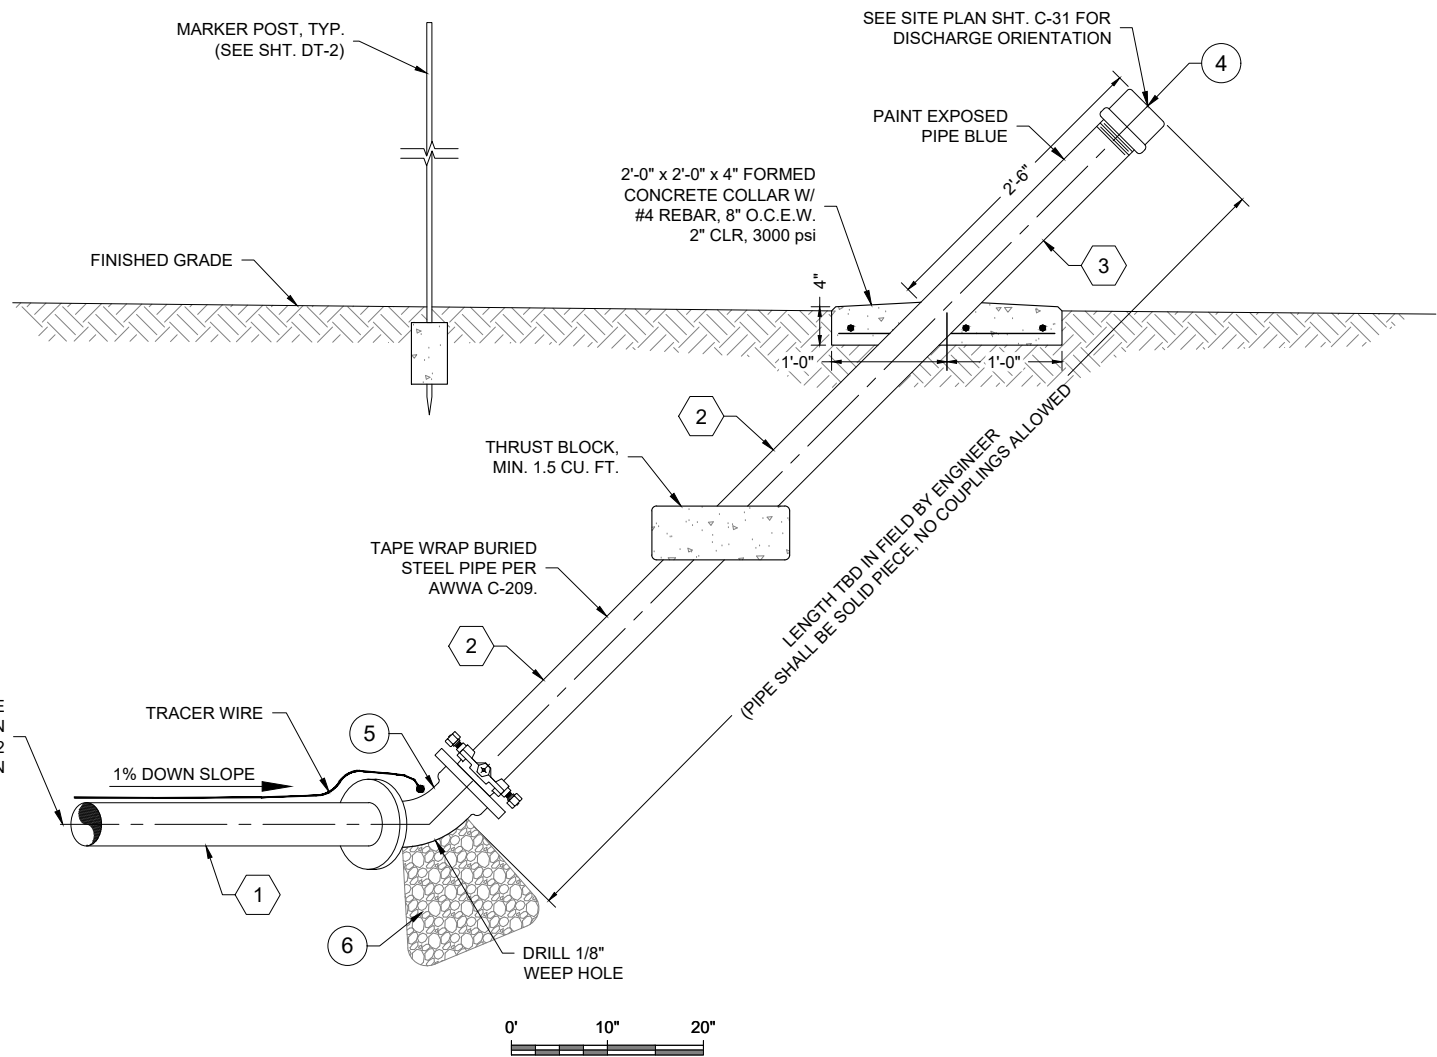

ELEVATION VIEW

4" FLUSH VALVE ABOVE-GRADE DISCHARGE DETAIL

KEYED NOTES - 4" FLUSH VALVE ABOVE GRADE DISCHARGE	
Item No.	DESCRIPTION
1	4" PVC, DR-18
2	4" G.I. PIPE, STANDARD WALL, PE x NPT, TAPE COATED BELOW GRADE
3	4" G.I. PIPE, STANDARD WALL, PE x NPT, PAINTED BLUE ABOVE GRADE
4	4" G.I. CAP, NPT, 300 psi, W/ 1/8" VENT HOLE
5	4" 45° MJ ELL, D.I., 350 psi (ROTATED 45° TOWARDS FINISHED GRADE)
6	ROUNDED ROCK (1.5 CU. YD.)

- NOTES:
1. APPLY CATHODIC PROTECTION TO ALL BURIED METALLIC WATER-CARRYING COMPONENTS LOCATED WITHIN CORROSIVE SOIL ZONES, AS DESIGNATED IN THE PLANS AND/OR SPECIFICATIONS.
 2. ALL STEEL PIPE AND FITTINGS SHALL BE STANDARD WALL.
 3. ALL COMPONENTS SHALL REMAIN WITHIN THE 40' PERMANENT RIGHT-OF-WAY.
 4. ALL MATERIALS RATED TO AT LEAST MAINLINE PIPE PRESSURE RATING, UNLESS OTHERWISE NOTED.
 5. MECHANICAL JOINTS OMITTED FROM ISOMETRIC VIEWS FOR CLARITY.

CLIENT: The Navajo Nation

TOWN: Reach 26.3 To Turren, NM

4 INCH FLUSH VALVE ABOVE-GRADE DISCHARGE DETAIL

NAVAJO GALLUP WATER SUPPLY PROJECT - REACH 26.3

SANDOVAL & MCKINLEY COUNTIES, NEW MEXICO

Designed
TTT

Drawn
AAV

Checked
AGR

90%
REVIEW
DRAFT

PRELIMINARY
NOT FOR CONSTRUCTION

THIS DRAWING IS INCOMPLETE
AND NOT TO BE USED FOR
CONSTRUCTION UNLESS IT IS
STAMPED, SIGNED AND DATED

NOTICE OF EXTENDED
PAYMENT PROVISION:
THIS CONTRACT ALLOWS THE
OWNER TO MAKE PAYMENT
WITHIN 45 DAYS AFTER
SUBMISSION OF
AN UNDISPUTED REQUEST
FOR PAYMENT.

811

Know what's
below.
Call before
you dig.

Date: September 27, 2018

Scale: Horiz: AS SHOWN
Vert: N/A

Project No: 6921307

Sheet: DT-9

By: CLK/c

Date: 9/27/2018

Revision: 1

Description: 4" FLUSH VALVE ABOVE GRADE DISCHARGE DETAIL

SOUDEY, MILLER & ASSOCIATES
5454 VANCE AVENUE NE, SUITE D
ALBUQUERQUE, NM 87113
Phone (505) 299-0942 Toll-Free (877) 299-0942 Fax (505) 293-3430
www.soudermiller.com
Serving the Southwest & Rocky Mountains
Albuquerque, Carlsbad, Hobbs, Farmington, Las Cruces, Roswell, Santa Fe, NM
Cortez, Grand Junction, CO - Safford, AZ - Moab, UT - El Paso, TX

9/27/2018 5:08:54 PM

Item No.	Description
1	6" FL x FL PRESSURE REDUCING VALVE, CLASS 150, 250 psi
2	6" FL x FL H-STYLE STRAINER, CLA-VAL MODEL X43H, CLASS 150, 250 psi
3	6" DISMANTLING JOINT, FBE COATED W/ 304 SS BOLTS, ROMAC MODEL DJ400, CLASS E FLANGE, 275 psi
4	6" FL x FL PRESSURE RELIEF VALVE, CLASS 150, 250 psi
5	6" FL x FL TEE, DI, 350 psi
6	6" FL x PE DUCTILE IRON PIPE, 350 psi
7	6" PVC DR 18 PIPE
8	6" MJ x MJ GATE VALVE, 350 psi (SEE DETAIL, DT-6)
9	6" FL x FL GATE VALVE, 350 psi, HAND WHEEL ACTUATOR
10	6" x 4" MJ REDUCING TEE, DI, 350 psi
11	6" x 2" TAPPED BLIND FLANGE, DI

12	4" PE x NPT G.I. PIPE STANDARD WALL
13	4" x 2" G.I. REDUCER, NPT, 350 psi
14	2" PRESSURE REDUCING VALVE, NPT, 400 psi
15	2" FL x FL H-STYLE STRAINER, CLA-VAL MODEL X43H, CLASS 150, 250 psi
16	2" GATE VALVE, NPT, 350 psi (SEE DETAIL, DT-6)
17	2" GATE VALVE, NPT, 350 psi, HAND WHEEL ACTUATOR
18	2" G.I. PIPE, STANDARD WALL, NPT
19	2" G.I. - HUB, FLAT FACED, COMPANION FLANGE, NPT, SS 304, ANSI CLASS 150
20	2" G.I. 90° ELL, NPT, 350 psi
21	1/2" VALMATIC MODEL NO. 22 AIR RELEASE VALVE, 300 psi WP
22	1/2" DOWN SPOUT W/ SCREEN, SCHEDULE 80 PVC
23	ADJUSTABLE PIPE SUPPORT W/ U-SHAPED CRADLE
24	ALUMINUM LADDER W/ SAFETY POST ANCHORED TO VAULT OPENING AND FLOOR (SHIPPED LOOSE)


1. ALL MATERIALS RATED TO AT LEAST MAINLINE PIPE PRESSURE RATING, UNLESS OTHERWISE NOTED.
2. FLANGES SHALL BE ANSI CLASS 125 (IRON).
3. COIL TRACER WIRE ON INSIDE WALLS OF VAULT.
4. SOME PIPE SUPPORTS NOT SHOWN FOR CLARITY.
5. ENSURE ALL BALL VALVE HANDLES ARE UNIMPEDED THROUGH THEIR FULL RANGE OF MOTION.
6. ALL NON-STAINLESS METALLIC PIPE AND FITTINGS IN CONTACT WITH SOIL SHALL BE COLD APPLIED TAPE WRAPPED PER AWWA C209.
7. SEE SHEET C-32 FOR PLACARD DETAILS



Item No.	Description
1	6" FL x FL PRESSURE REDUCING VALVE, CLASS 150, 250 psi
2	6" FL x FL H-STYLE STRAINER, CLA-VAL MODEL X43H, CLASS 150, 250 psi
3	6" DISMANTLING JOINT, FBE COATED W/ 304 SS BOLTS, ROMAC MODEL DJ400, CLASS E FLANGE, 275 psi
4	6" FL x FL PRESSURE RELIEF VALVE, CLASS 150, 250 psi
5	6" FL x FL TEE, DI, 350 psi
6	6" FL x PE DUCTILE IRON PIPE, 350 psi
7	6" PVC DR 18 PIPE
8	6" MJ x MJ GATE VALVE, 350 psi (SEE DETAIL, DT-6)
9	6" FL x FL GATE VALVE, 350 psi, HAND WHEEL ACTUATOR
10	6" x 4" MJ REDUCING TEE, DI, 350 psi
11	6" x 2" TAPPED BLIND FLANGE, DI

12	4" PE x NPT G.I. PIPE STANDARD WALL
13	4" x 2" G.I. REDUCER, NPT, 350 psi
14	2" PRESSURE REDUCING VALVE, NPT, 400 psi
15	2" FL x FL H-STYLE STRAINER, CLA-VAL MODEL X43H, CLASS 150, 250 psi
16	2" GATE VALVE, NPT, 350 psi (SEE DETAIL, DT-6)
17	2" GATE VALVE, NPT, 350 psi, HAND WHEEL ACTUATOR
18	2" G.I. PIPE, STANDARD WALL, NPT
19	2" G.I. - HUB, FLAT FACED, COMPANION FLANGE, NPT, SS 304, ANSI CLASS 150
20	2" G.I. 90° ELL, NPT, 350 psi
21	1/2" VALMATIC MODEL NO. 22 AIR RELEASE VALVE, 300 psi WP
22	1/2" DOWN SPOUT W/ SCREEN, SCHEDULE 80 PVC
23	ADJUSTABLE PIPE SUPPORT W/ U-SHAPED CRADLE
24	ALUMINUM LADDER W/ SAFETY POST ANCHORED TO VAULT OPENING AND FLOOR (SHIPPED LOOSE)

1. ALL MATERIALS RATED TO AT LEAST MAINLINE PIPE PRESSURE RATING, UNLESS OTHERWISE NOTED.
2. FLANGES SHALL BE ANSI CLASS 125 (IRON).
3. COIL TRACER WIRE ON INSIDE WALLS OF VAULT.
4. SOME PIPE SUPPORTS NOT SHOWN FOR CLARITY.
5. ENSURE ALL BALL VALVE HANDLES ARE UNIMPEDED THROUGH THEIR FULL RANGE OF MOTION.
6. ALL NON-STAINLESS METALLIC PIPE AND FITTINGS IN CONTACT WITH SOIL SHALL BE COLD APPLIED TAPE WRAPPED PER AWWA C209.
7. SEE SHEET C-32 FOR PLACARD DETAILS

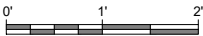

© Copyright 2018 Souder, Miller & Associates - All Rights Reserved

Revision	Date	Description	By	Chkd
Cutter 26.3 PRV Valve Details.dwg				
9/27/2018 5:24:00PM aiv				

SMA
Engineering & Environmental
Surveying

SOUDER, MILLER & ASSOCIATES
3454 VINE AVENUE, NE, SUITE D
ALBUQUERQUE, NM 87113

Phone (505) 299-0942 Toll-Free (877) 290-0942 Fax (505) 293-3434
www.soudermiller.com

Serving the Southwest & Rocky Mountains
Albuquerque, Carlsbad, Hobbs, Farmington, Las Cruces, Roswell, Santa Fe, NM;
Colorado, Grand Junction, CO; Salt Lake City, UT; Phoenix, AZ; El Paso, TX.

CLIENT: The Navajo Nation
TOWN: Reach 26.3 To Tureen, NM

**6 INCH CONTROL VALVE WITH PRESSURE
RELIEF VAULT DETAIL (2 of 2)**

**NAVAJO GALLUP WATER SUPPLY
PROJECT - REACH 26.3**

SANDOVAL & MCKINLEY COUNTIES, NEW MEXICO

Designed TTT	Drawn AAV	Checked AGR
-----------------	--------------	----------------

90% REVIEW
DRAFT

PRELIMINARY
NOT FOR CONSTRUCTION

THIS DRAWING IS INCOMPLETE
AND NOT TO BE USED FOR
CONSTRUCTION UNLESS IT IS
STAMPED, SIGNED AND DATED

**NOTICE OF EXTENDED
PAYMENT PROVISION:**
THIS CONTRACT ALLOWS THE
OWNER TO MAKE PAYMENT
WITHIN 45 DAYS AFTER
SUBMISSION OF
AN UNDISPUTED REQUEST
FOR PAYMENT.




Date: September 27, 2018


Scale: Horiz: 1" = 2'
Vert: N/A

Project No: 6921307

Sheet: DT-11

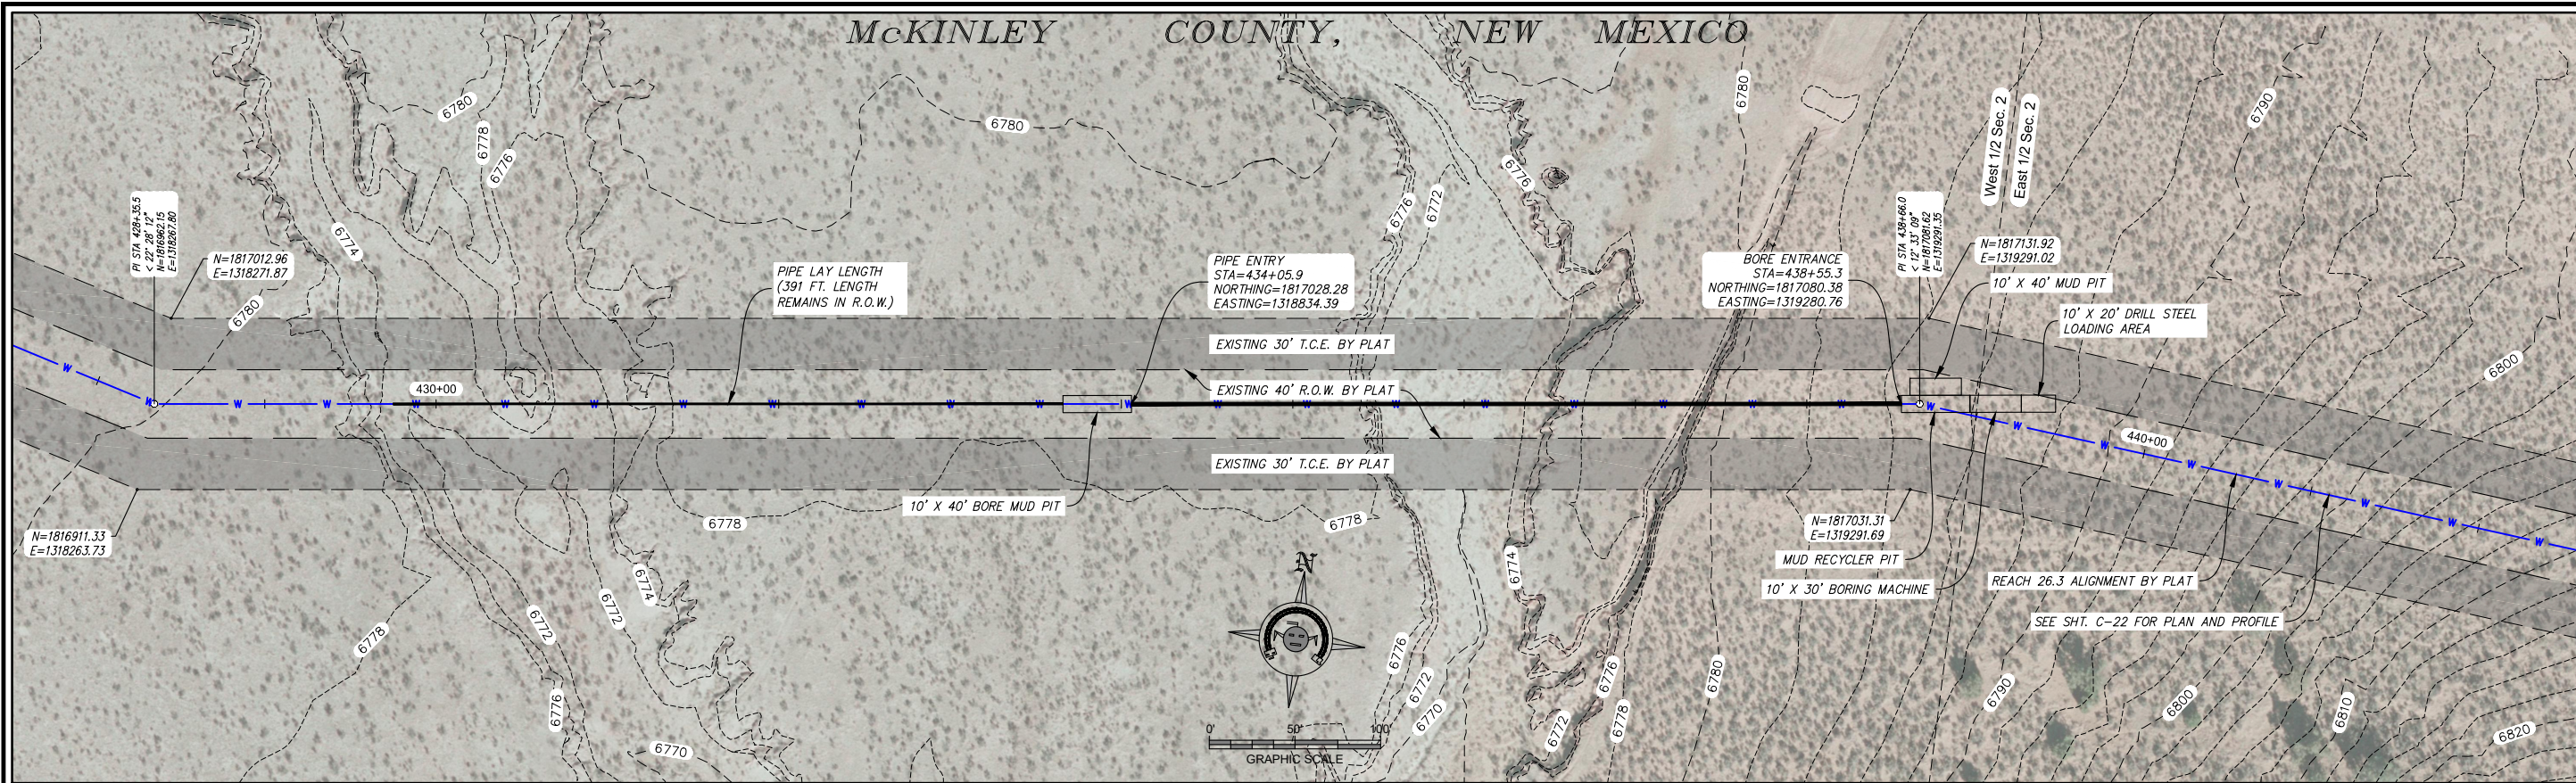

PLAN VIEW

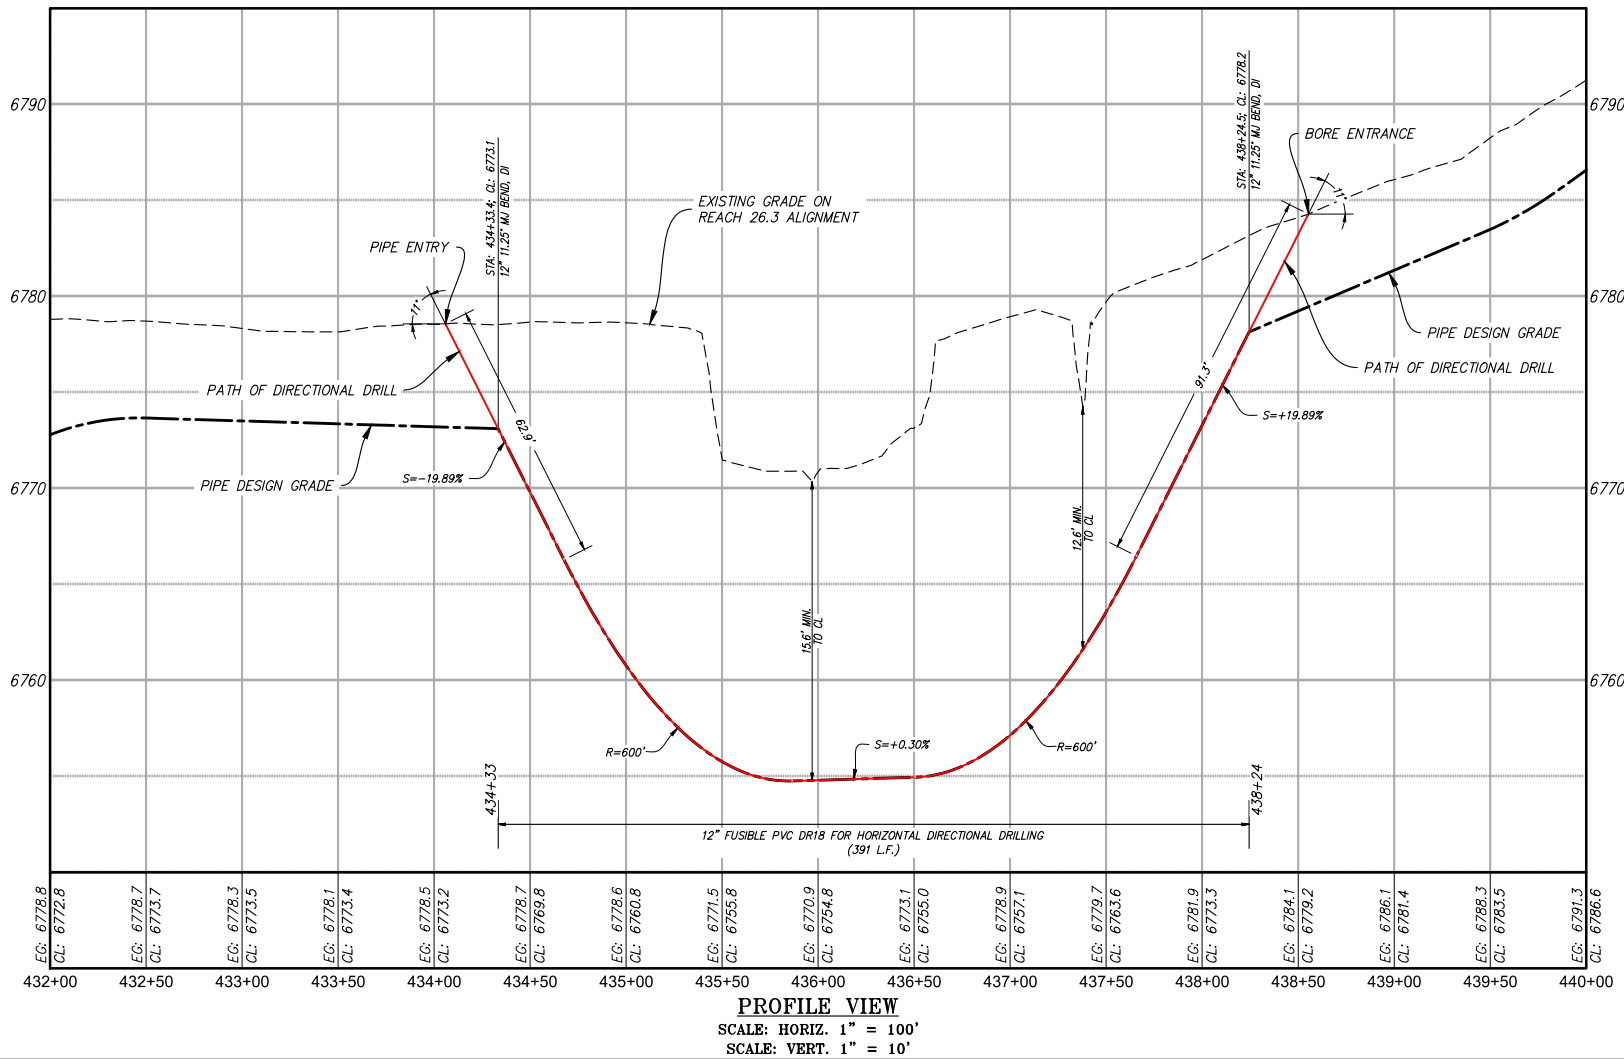

- NOTES:
1. MINIMUM ALLOWABLE BEND RADIUS = 500'
 2. FUSIBLE PVC PIPE TO BE PRESSURE TESTED ABOVE GROUND PRIOR TO INSTALLATION PER TECHNICAL SPECIFICATIONS.

Revision	Date	Description	By	CHK'd

SMA
Souder, Miller & Associates
5454 VANCE AVENUE NE, SUITE D
ALBUQUERQUE, NM 87113
Phone (505) 299-0942 Toll-Free (877) 299-0942 Fax (505) 293-3430
www.soudermiller.com
Serving the Southwest & Rocky Mountains
Albuquerque, Carlsbad, Hobbs, Farmington, Las Cruces, Roswell, Santa Fe, NM
Concepcion, Grand Junction, CO - Safford, AZ - Moab, UT - El Paso, TX

CLIENT: The Navajo Nation
TOWN: Reach 26.3 To Tarron, NM
WASH CROSSING STA 435+97
PIPELINE HDD DETAIL
NAVAJO GALLUP WATER SUPPLY
PROJECT - REACH 26.3
SANDOVAL & MCKINLEY COUNTIES, NEW MEXICO

Designed	Drawn	Checked
TTT	AAV	AGR

90% REVIEW
DRAFT

PRELIMINARY
NOT FOR CONSTRUCTION

THIS DRAWING IS INCOMPLETE
AND NOT TO BE USED FOR
CONSTRUCTION UNLESS IT IS
STAMPED, SIGNED AND DATED

NOTICE OF EXTENDED
PAYMENT PROVISION:
THIS CONTRACT PROVIDES THE
OWNER TO MAKE PAYMENT
WITHIN 45 DAYS AFTER
SUBMISSION OF
AN UNDISPUTED REQUEST
FOR PAYMENT.

811 Know what's
below.
Call before
you dig.

Date: September 27, 2018


Scale: Horiz: 1" = 100'
Vert: 1" = 10'

Project No: 6921307

Sheet: DT-14

KEYED NOTES - PRESSURE TRANSDUCER VAULT	
Item No.	Description
1	2" STEEL PIPE, NPT, SCHEDULE 40
2	2" TEE, SS 304, NPT, SCHEDULE 40
3	2" x 1" REDUCING BUSHING, SS 304, NPT, SCHEDULE 40
4	1" SS 304 PIPE, NPT, SCHEDULE 40
5	1" CROSS, SS 304, NPT, SCHEDULE 40
6	1" 90° ELL, SS 304, NPT, SCHEDULE 40
7	1" x 1/2" REDUCING BUSHING, SS 304, NPT, SCHEDULE 40
8	1/2" SS 304 PIPE, NPT, SCHEDULE 40
9	AIR RELEASE VALVE, 1/2" VALMATIC 15ASV, 175 psi W/ 1/2" SS 304 BALL VALVE, 1500 psi & 1/2" SCHEDULE 80 PVC RETURN (SECURED TO UNISTRUT SUPPORT)
10	VERTICAL MOUNT PRESSURE TRANSDUCER 0-30 psi, AMETEK 88C, W/ 1/2" SS 304 BALL VALVE, 2000 psi (SECURED TO UNISTRUT SUPPORT)
11	PRESSURE GAUGE 0-25 psi W/ 1/4" SS 304 BALL VALVE, 2000 psi, 1" x 1/4" SS 304 REDUCING BUSHING & 1/4" SS 304 PIPE, NPT
12	ADJUSTABLE PIPE SUPPORT W/ U-SHAPED CRADLE

NOTE:
1. ALL STAINLESS STEEL PIPE AND FITTINGS SHALL HAVE A WORKING
PRESSURE OF AT LEAST 350 psi, UNLESS OTHERWISE NOTED.

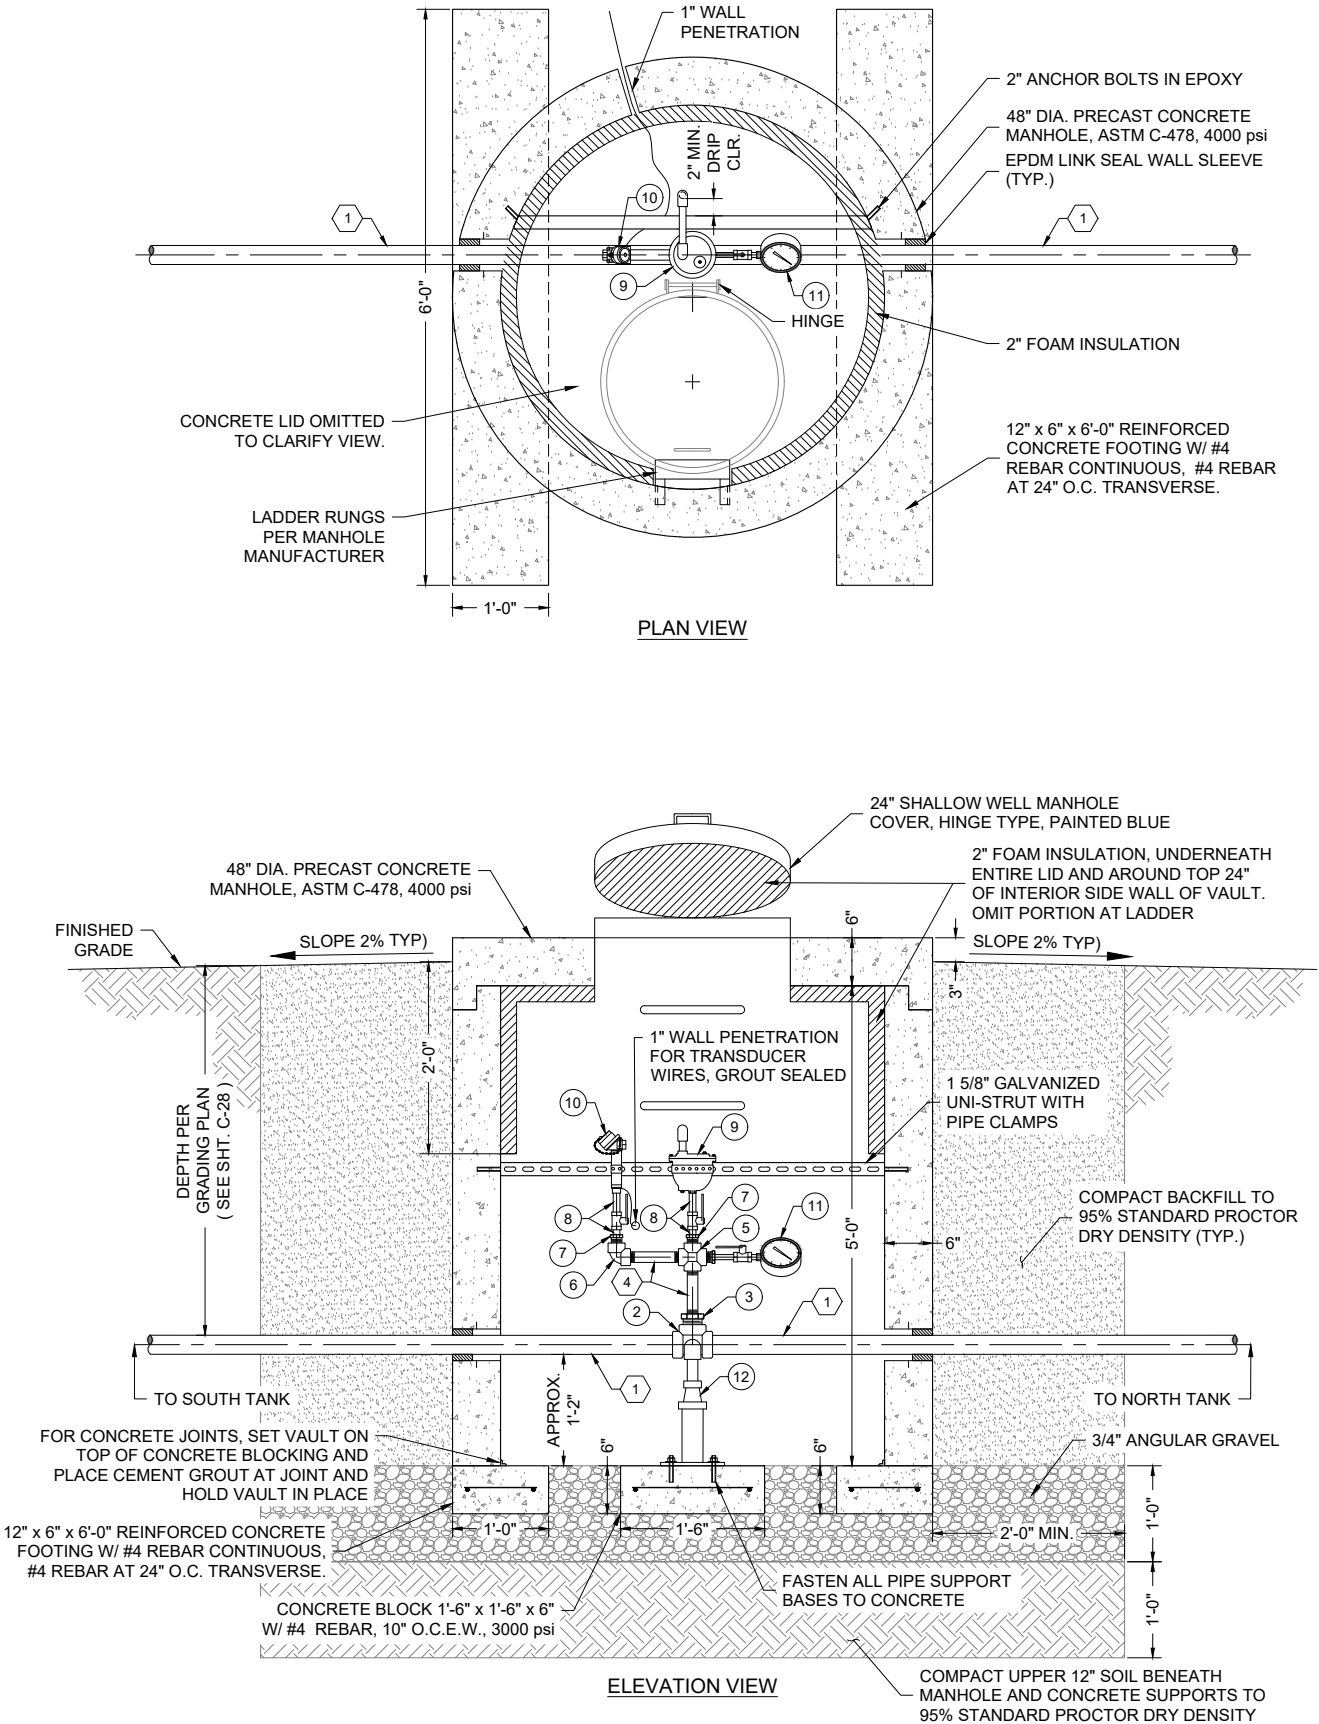

PRESSURE TRANSDUCER VAULT DETAIL

Revision

Date

Description

By

CHK'd

SMA

Engineering & Environmental Surveying

Souder, Miller & Associates

5454 VENCE AVENUE NE, SUITE D

ALBUQUERQUE, NM 87113

Phone (505) 299-0942 Toll-Free (877) 299-0942 Fax (505) 293-3430

www.soudermiller.com

Serving the Southwest & Rocky Mountains

Albuquerque, Carlsbad, Hobbs, Farmington, Las Cruces, Roswell, Santa Fe, NM

Cortez, Grand Junction, CO - Safford, AZ - Moab, UT - El Paso, TX

CLIENT: The Navajo Nation

TOWN: Reach 26.3 To Turreon, NM

TRANSUDER VAULT DETAIL

NAVAJO GALLUP WATER SUPPLY

PROJECT - REACH 26.3

SANDOVAL & MCKINLEY COUNTIES, NEW MEXICO

Designed

Drawn

Checked

TTT

AAV

AGR

90% REVIEW

DRAFT

PRELIMINARY

NOT FOR CONSTRUCTION

THIS DRAWING IS INCOMPLETE AND NOT TO BE USED FOR CONSTRUCTION UNLESS IT IS STAMPED, SIGNED AND DATED

NOTICE OF EXTENDED PAYMENT PROVISION: THIS CONTRACT ALLOWS THE OWNER TO MAKE PAYMENT WITHIN 45 DAYS AFTER SUBMISSION OF AN UNDISPUTED REQUEST FOR PAYMENT.

811

Know what's below. Call before you dig.

Date: September 27, 2018

Scale: Horiz: AS SHOWN



Vert: N/A

Project No: 6921307

Sheet: DT-15

Item No.	Description
1	2" BALL CURB VALVE, FNPT, MINNEAPOLIS PATTERN, MUELLER B-20287, OAE WP 300 psi, OAE (COVER PAINTED BLUE)
2	2" STEEL PIPE, NPT, SCHEDULE 40 (SEE NOTE #2, THIS SHEET)
3	2" 90° ELL, WELDED STEEL (SEE NOTE #2, THIS SHEET)
4	CURB STOP BOX, EXTENSION TYPE MUELLER H-10302, OAE W/ MUELLER STATIONARY ROD WHICH EXTENDS 2'-4" BELOW CURB BOX LID, TOP PAINTED BLUE

1. ALL MATERIALS, FITTINGS, AND APPURTENANCES SHALL BE RATED TO AT LEAST 150 psi, UNLESS OTHERWISE NOTED.
2. FOR USE WITH WELDED TANKS, STEEL PIPES AND FITTINGS SHALL BE INTERIOR COATED SAME AS TANK INTERIOR AND EXTERIOR COATED WITH COAL TAR EPOXY. FOR USE WITH GLASS FUSED TANKS, STEEL PIPES AND FITTINGS SHALL BE SS 304. ALL NON-STAINLESS METALLIC PIPE AND WELDED FITTINGS SHALL BE COLD-APPLIED TAPE-COATED, PER SPECIFICATIONS.
3. ALL STEEL PIPE AND FITTINGS SHALL BE STANDARD WALL, UNLESS OTHERWISE NOTED.

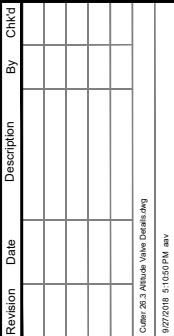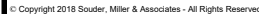

SMA
Engineers • Environmental
Surveying

SOLDER, MILLER & ASSOCIATES
5455 VENCE AVENUE, SUITE D
ALBUQUERQUE, NM 87131

Phone (505) 299-0942 Toll-Free (877) 299-0942 Fax (505) 299-3430
www.soldermiller.com

Serving the Southwest & Rocky Mountains
Albuquerque, Carlsbad, Hobbs, Farmington, Las Cruces, Roswell, Santa Fe, NM
Corona, Grand Junction, CO • Salt Lake City, UT • Mesa, AZ • Phoenix, AZ
Dallas, TX

CLIENT: The Navajo Nation
TOWN: Reach 26.3 To Tureen, NM

**SENSOR LINE & YARD HYDRANT
DETAILS**

**NAVAJO GALLUP WATER SUPPLY
PROJECT - REACH 26.3**

SANDOVAL & MCKINLEY COUNTIES, NEW MEXICO

Designed TTT	Drawn AAV	Checked AGR
-----------------	--------------	----------------

90% REVIEW
DRAFT

PRELIMINARY
NOT FOR CONSTRUCTION

THIS DRAWING IS INCOMPLETE
AND NOT TO BE USED FOR
CONSTRUCTION UNLESS IT IS
STAMPED, SIGNED AND DATED

**NOTICE OF EXTENDED
PAYMENT PROVISION:**
THIS CONTRACT ALLOWS THE
OWNER TO MAKE PAYMENT
WITHIN 45 DAYS AFTER
SUBMISSION OF
AN UNDISPUTED REQUEST
FOR PAYMENT.



**Know what's
below.
Call before
you dig.**

Date: September 27, 2018



Scale: Horiz: AS SHOWN
Vert: N/A

Project No: 6921307

Sheet: DT-16

NOTES:

1. FOUNDATION AND TANK STRUCTURAL DESIGN DRAWINGS AND CALCULATIONS (SEALED BY NEW MEXICO LICENSED PROFESSIONAL ENGINEER) TO BE PROVIDED BY TANK MANUFACTURER. FOUNDATION SHALL BE EITHER CONCRETE OR STEEL RING, BASED ON LICENSED TANK MANUFACTURER'S DESIGN.
2. FOUNDATIONS SHOWN IN DRAWING ARE FOR REFERENCE ONLY. DIAMETER OF FOUNDATION TO BE BASED ON TANK MANUFACTURER'S P.E.'s DESIGNED FOUNDATION.
3. SUB-FOUNDATION PER GEOTECHNICAL INVESTIGATION REPORT (REFER TO GEOTEST REPORT NO. 1-71108 DATED 1-8-2018).
4. TANK COLOR SHALL BE CARLSBAD CANYON TAN.
5. TANK APPURTENANCES SHOWN IN ELEVATION VIEW HAVE BEEN ROTATED INTO VIEW FOR DEPICTION PURPOSES.
6. IF WELDED STEEL TANKS ARE USED, ALL BURIED STEEL PIPE, WELDED FITTINGS AND OTHER COMPONENTS SHALL BE EXTERIOR COATED W/ COAL TAR EPOXY AND COLD APPLIED TAPE COATING PER SPECIFICATIONS, AND INTERIOR COATED TO MATCH TANK INTERIOR SIDE WALL.
- 6A. IF GLASS-FUSED STEEL TANKS ARE USED, ALL 8-INCH STEEL PIPE AND FITTINGS SHALL COLD APPLIED TAPE WRAPPED PER SPECIFICATIONS. ALL 2-INCH STEEL PIPES AND FITTINGS SHALL BE SS 304.
7. WITHIN 5' OF TANK FOUNDATION ALL PIPE SHALL BE STEEL. ALL STEEL PIPE AND FITTINGS UNDERNEATH AND WITHIN 5' OF TANKS OR BUILDINGS SHALL BE SHOP WELDED AND COATED, X-RAY TESTED AND PRESSURE TESTED PRIOR TO POURING FOUNDATIONS. SHOP COATING SHALL BE APPLIED AFTER WELDING.
8. ALL STEEL PIPE AND FITTINGS SHALL BE STANDARD WALL UNLESS OTHERWISE NOTED.
9. ALL BASE AND OVERFLOW ELEVATIONS PROVIDED IN THESE DRAWINGS ARE APPROXIMATE. CONTRACTOR SHALL FIELD SURVEY ELEVATION OF OVERFLOW WEIRS AND ENSURE BOTH TANK'S WEIR ELEVATIONS MATCH WITHIN A TOLERANCE OF $\pm 1/2$ INCHES.
10. ALL STEEL PIPE FLANGES SHALL BE ANSI CLASS 150.
11. EXACT ORIENTATION OF ALL TANK FEATURES AND PIPE PENETRATIONS TO BE DETERMINED IN THE FIELD BY THE ENGINEER. TANK MANUFACTURER SHALL CONFIRM ALL LOCATIONS W/ ENGINEER PRIOR TO FABRICATION. SOME FEATURES MAY BE ROTATED IN ELEVATION VIEW FOR CLARITY.
12. FOUNDATION AND FLOOR SLOPE UPWARDS 1% TOWARD CENTER TO PREVENT "OILCANNING".
13. ALL SITE-CAST CONCRETE SHALL BE MADE WITH TYPE V (ALKALI RESISTIVE) CEMENT AND SHALL ATTAIN A MINIMUM COMPRESSIVE STRENGTH OF 3,000 psi WITHIN 28 DAYS. THE MIX DESIGN SHOULD INCLUDE 5% ($\pm 1\%$) AIR ENTRAINMENT AND SHOULD BE PLACED AND CURED IN ACCORDANCE WITH THE ACI MANUAL OF CONCRETE PRACTICE, VOLUMES 1 THRU 5. SLUMP AT THE TIME OF PLACEMENT SHOULD NOT EXCEED FOUR (4) INCHES, AND MECHANICAL VIBRATION SHOULD BE EMPLOYED FOR CONSOLIDATION TO ELIMINATE VOIDS AND HONEYCOMBING.

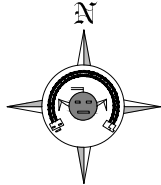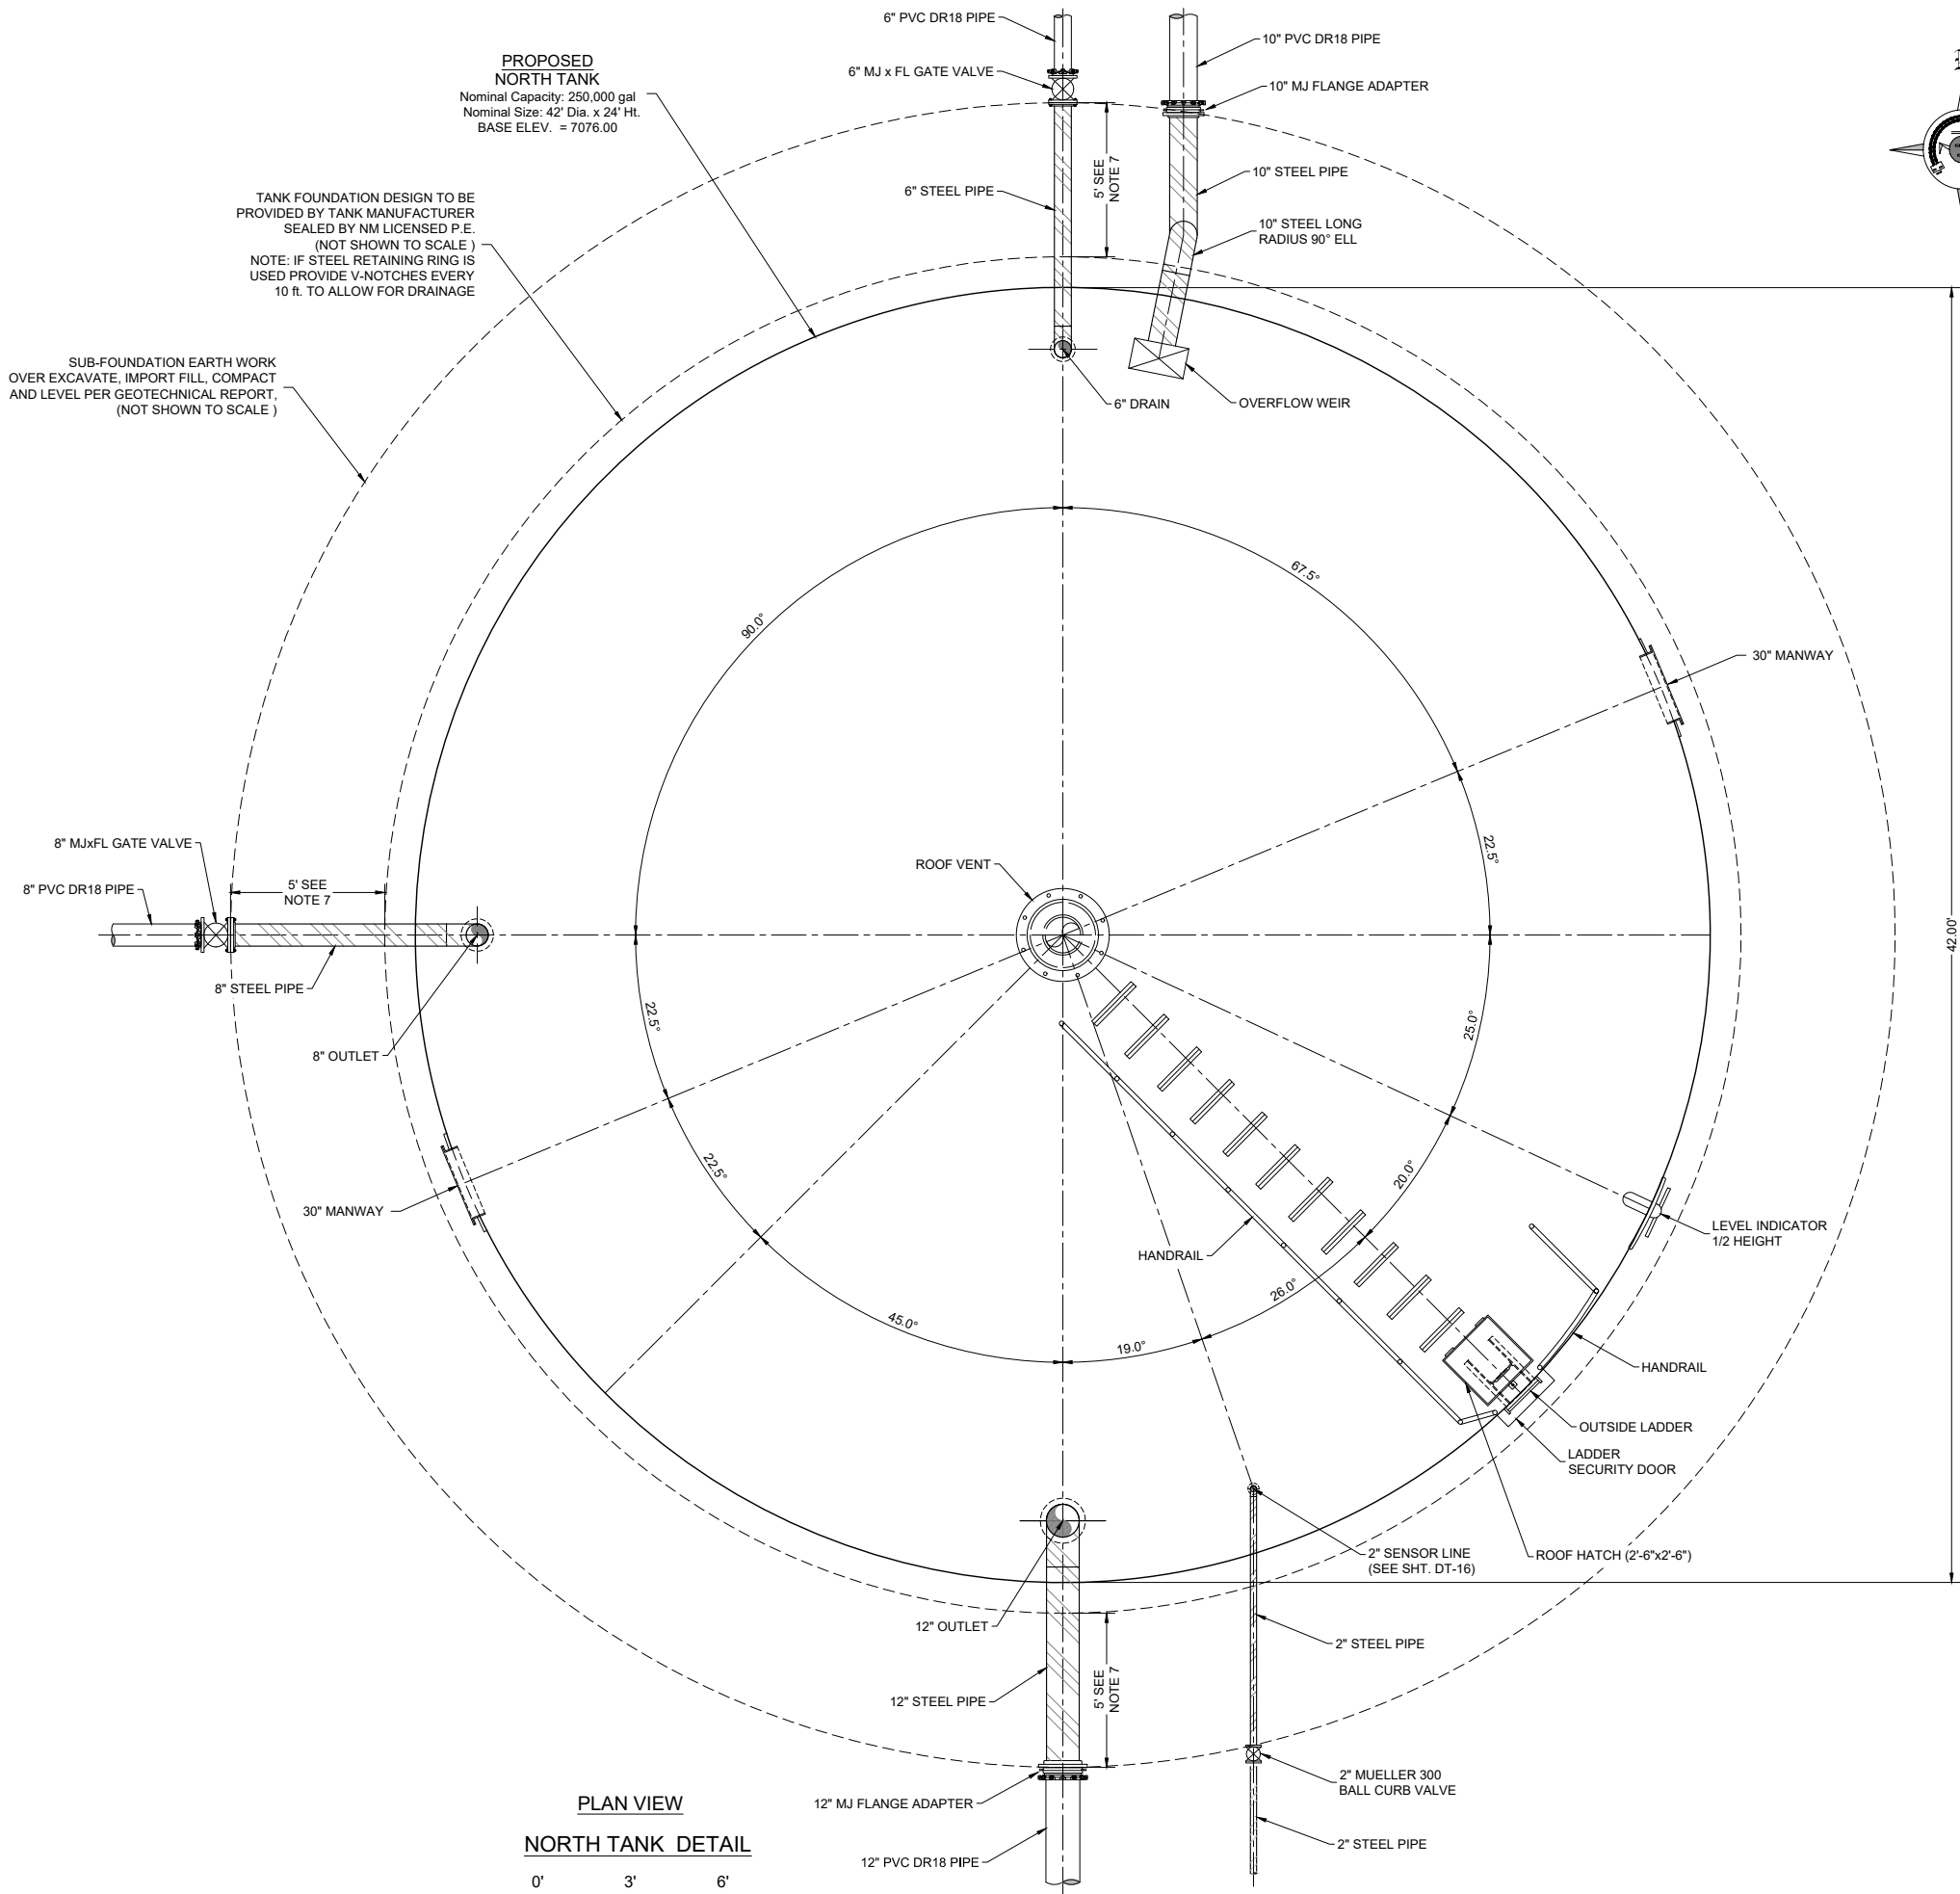

Revision	Date	Description	By	CHK'd

Scale: Horiz: 1" = 6'
Vert: N/A

Project No: 6921307

Sheet: DT-17

SMA
Engineering & Environmental Surveying

SOUDER, MILLER & ASSOCIATES
5454 VENCE AVENUE NE, SUITE D
ALBUQUERQUE, NM 87113
Phone (505) 299-0942 Toll-Free (877) 299-0942 Fax (505) 293-3430
www.soudermiller.com

Serving the Southwest & Rocky Mountains
Albuquerque, Carlsbad, Hobbs, Farmington, Las Cruces, Roswell, Santa Fe, NM
Cortez, Grand Junction, CO - Safford, AZ - Moab, UT - El Paso, TX

CLIENT: The Navajo Nation TOWN: Reach 26.3 To Turreon, NM

NORTH TANK DETAILS (1 of 2)
NAVAJO GALLUP WATER SUPPLY
PROJECT - REACH 26.3
SANDOVAL & MCKINLEY COUNTIES, NEW MEXICO

Designed TTT Drawn AAV Checked AGR

90% REVIEW
DRAFT

PRELIMINARY
NOT FOR CONSTRUCTION

THIS DRAWING IS INCOMPLETE AND NOT TO BE USED FOR CONSTRUCTION UNLESS IT IS STAMPED, SIGNED AND DATED

NOTICE OF EXTENDED PAYMENT PROVISION:
THIS CONTRACT ALLOWS THE OWNER TO MAKE PAYMENT WITHIN 45 DAYS AFTER SUBMISSION OF AN UNDISPUTED REQUEST FOR PAYMENT.

811 Know what's below. Call before you dig.


Date: September 27, 2018

Scale: Horiz: 1" = 6'
Vert: N/A

Project No: 6921307



Sheet: DT-17

1. FOUNDATION AND TANK STRUCTURAL DESIGN DRAWINGS AND CALCULATIONS (SEALED BY NEW MEXICO-LICENSED PROFESSIONAL ENGINEER) TO BE PROVIDED BY TANK MANUFACTURER. FOUNDATION SHALL BE EITHER CONCRETE OR STEEL RING, BASED ON LICENSED TANK MANUFACTURER'S DESIGN.
2. FOUNDATIONS SHOWN IN DRAWING ARE FOR REFERENCE ONLY. DIAMETER OF FOUNDATION TO BE BASED ON TANK MANUFACTURER'S P.E.'S DESIGNED FOUNDATION.
3. SUB-FOUNDATION PER GEOTECHNICAL INVESTIGATION REPORT (REFER TO GEOTEST REPORT NO. 1-71108 DATED 1-8-2018).
4. TANK COLOR SHALL BE CARLSBAD CANYON TAN.
5. TANK APPURTENANCES SHOWN IN ELEVATION VIEW HAVE BEEN ROTATED INTO VIEW FOR DEPICTION PURPOSES.
6. IF WELDED STEEL TANKS ARE USED, ALL BURIED STEEL PIPE, WELDED FITTINGS AND OTHER COMPONENTS SHALL BE EXTERIOR COATED W/ COAL TAR EPOXY AND COLD APPLIED TAPE COATING PER SPECIFICATIONS, AND INTERIOR COATED TO MATCH TANK INTERIOR SIDE WALL.
- 6A. IF GLASS-FUSED STEEL TANKS ARE USED, ALL 8-INCH STEEL PIPE AND FITTINGS SHALL COLD APPLIED TAPE WRAPPED PER SPECIFICATIONS. ALL 2-INCH STEEL PIPES AND FITTINGS SHALL BE SS 304.
7. WITHIN 5' OF TANK FOUNDATION ALL PIPE SHALL BE STEEL. ALL STEEL PIPE AND FITTINGS UNDERNEATH AND WITHIN 5' OF TANKS OR BUILDINGS SHALL BE SHOP WELDED AND COATED. X-RAY TESTED AND PRESSURE TESTED PRIOR TO POURING FOUNDATIONS. SHOP COATING SHALL BE APPLIED AFTER WELDING.
8. ALL STEEL PIPE AND FITTINGS SHALL BE STANDARD WALL UNLESS OTHERWISE NOTED.
9. ALL BASE AND OVERFLOW ELEVATIONS PROVIDED IN THESE DRAWINGS ARE APPROXIMATE. CONTRACTOR SHALL FIELD SURVEY ELEVATION OF OVERFLOW WEIRS AND ENSURE BOTH TANK'S WEIR ELEVATIONS MATCH WITHIN A TOLERANCE OF $\pm 1/2$ INCHES.
10. ALL STEEL PIPE FLANGES SHALL BE ANSI CLASS 150.
11. EXACT ORIENTATION OF ALL TANK FEATURES AND PIPE PENETRATIONS TO BE DETERMINED IN THE FIELD BY THE ENGINEER. TANK MANUFACTURER SHALL CONFIRM ALL LOCATIONS W/ ENGINEER PRIOR TO FABRICATION. SOME FEATURES MAY BE ROTATED IN ELEVATION VIEW FOR CLARITY.
12. FOUNDATION AND FLOOR SLOPE UPWARDS 1% TOWARD CENTER TO PREVENT "OILCANNING".
13. ALL SITE-CAST CONCRETE SHALL BE MADE WITH TYPE V (ALKALI RESISTIVE) CEMENT AND SHALL ATTAIN A MINIMUM COMPRESSIVE STRENGTH OF 3,000 psi WITHIN 28 DAYS. THE MIX DESIGN SHOULD INCLUDE 5% ($\pm 1\%$) AIR ENTRAINMENT AND SHOULD BE PLACED AND CURED IN ACCORDANCE WITH THE ACI MANUAL OF CONCRETE PRACTICE, VOLUMES 1 THRU 5. SLUMP AT THE TIME OF PLACEMENT SHOULD NOT EXCEED FOUR (4) INCHES, AND MECHANICAL VIBRATION SHOULD BE EMPLOYED FOR CONSOLIDATION TO ELIMINATE VOIDS AND HONEYCOMBING.

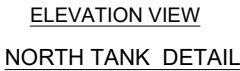

NOTES:

1. FOUNDATION AND TANK STRUCTURAL DESIGN DRAWINGS AND CALCULATIONS (SEALED BY NEW MEXICO-LICENSED PROFESSIONAL ENGINEER) TO BE PROVIDED BY TANK MANUFACTURER. FOUNDATION SHALL BE EITHER CONCRETE OR STEEL RING, BASED ON LICENSED TANK MANUFACTURER'S DESIGN.
2. FOUNDATIONS SHOWN IN DRAWING ARE FOR REFERENCE ONLY. DIAMETER OF FOUNDATION TO BE BASED ON TANK MANUFACTURER'S P.E.'s DESIGNED FOUNDATION.
3. SUB-FOUNDATION PER GEOTECHNICAL INVESTIGATION REPORT (REFER TO GEOTEST REPORT NO. 1-71108 DATED 1-8-2018).
4. TANK COLOR SHALL BE CARLSBAD CANYON TAN.
5. TANK APPURTENANCES SHOWN IN ELEVATION VIEW HAVE BEEN ROTATED INTO VIEW FOR DEPICTION PURPOSES.
6. IF WELDED STEEL TANKS ARE USED, ALL BURIED STEEL PIPE, WELDED FITTINGS AND OTHER COMPONENTS SHALL BE EXTERIOR COATED W/ COAL TAR EPOXY AND COLD APPLIED TAPE COATING PER SPECIFICATIONS, AND INTERIOR COATED TO MATCH TANK INTERIOR SIDE WALL.
- 6A. IF GLASS-FUSED STEEL TANKS ARE USED, ALL 8-INCH STEEL PIPE AND FITTINGS SHALL COLD APPLIED TAPE WRAPPED PER SPECIFICATIONS. ALL 2-INCH STEEL PIPES AND FITTINGS SHALL BE SS 304.
7. WITHIN 5' OF TANK FOUNDATION ALL PIPE SHALL BE STEEL. ALL STEEL PIPE AND FITTINGS UNDERNEATH AND WITHIN 5' OF TANKS OR BUILDINGS SHALL BE SHOP WELDED AND COATED, X-RAY TESTED AND PRESSURE TESTED PRIOR TO POURING FOUNDATIONS. SHOP COATING SHALL BE APPLIED AFTER WELDING.
8. ALL STEEL PIPE AND FITTINGS SHALL BE STANDARD WALL UNLESS OTHERWISE NOTED.
9. ALL BASE AND OVERFLOW ELEVATIONS PROVIDED IN THESE DRAWINGS ARE APPROXIMATE. CONTRACTOR SHALL FIELD SURVEY ELEVATION OF OVERFLOW WEIRS AND ENSURE BOTH TANK'S WEIR ELEVATIONS MATCH WITHIN A TOLERANCE OF ±1/2 INCHES.
10. ALL STEEL PIPE FLANGES SHALL BE ANSI CLASS 150.
11. EXACT ORIENTATION OF ALL TANK FEATURES AND PIPE PENETRATIONS TO BE DETERMINED IN THE FIELD BY THE ENGINEER. TANK MANUFACTURER SHALL CONFIRM ALL LOCATIONS W/ ENGINEER PRIOR TO FABRICATION. SOME FEATURES MAY BE ROTATED IN ELEVATION VIEW FOR CLARITY.
12. FOUNDATION AND FLOOR SLOPE UPWARDS 1% TOWARD CENTER TO PREVENT "OILCANNING".
13. ALL SITE-CAST CONCRETE SHALL BE MADE WITH TYPE V (ALKALI RESISTIVE) CEMENT AND SHALL ATTAIN A MINIMUM COMPRESSIVE STRENGTH OF 3,000 psi WITHIN 28 DAYS. THE MIX DESIGN SHOULD INCLUDE 5% (±1%) AIR ENTRAINMENT AND SHOULD BE PLACED AND CURED IN ACCORDANCE WITH THE ACI MANUAL OF CONCRETE PRACTICE, VOLUMES 1 THRU 5. SLUMP AT THE TIME OF PLACEMENT SHOULD NOT EXCEED FOUR (4) INCHES, AND MECHANICAL VIBRATION SHOULD BE EMPLOYED FOR CONSOLIDATION TO ELIMINATE VOIDS AND HONEYCOMBING.

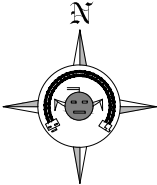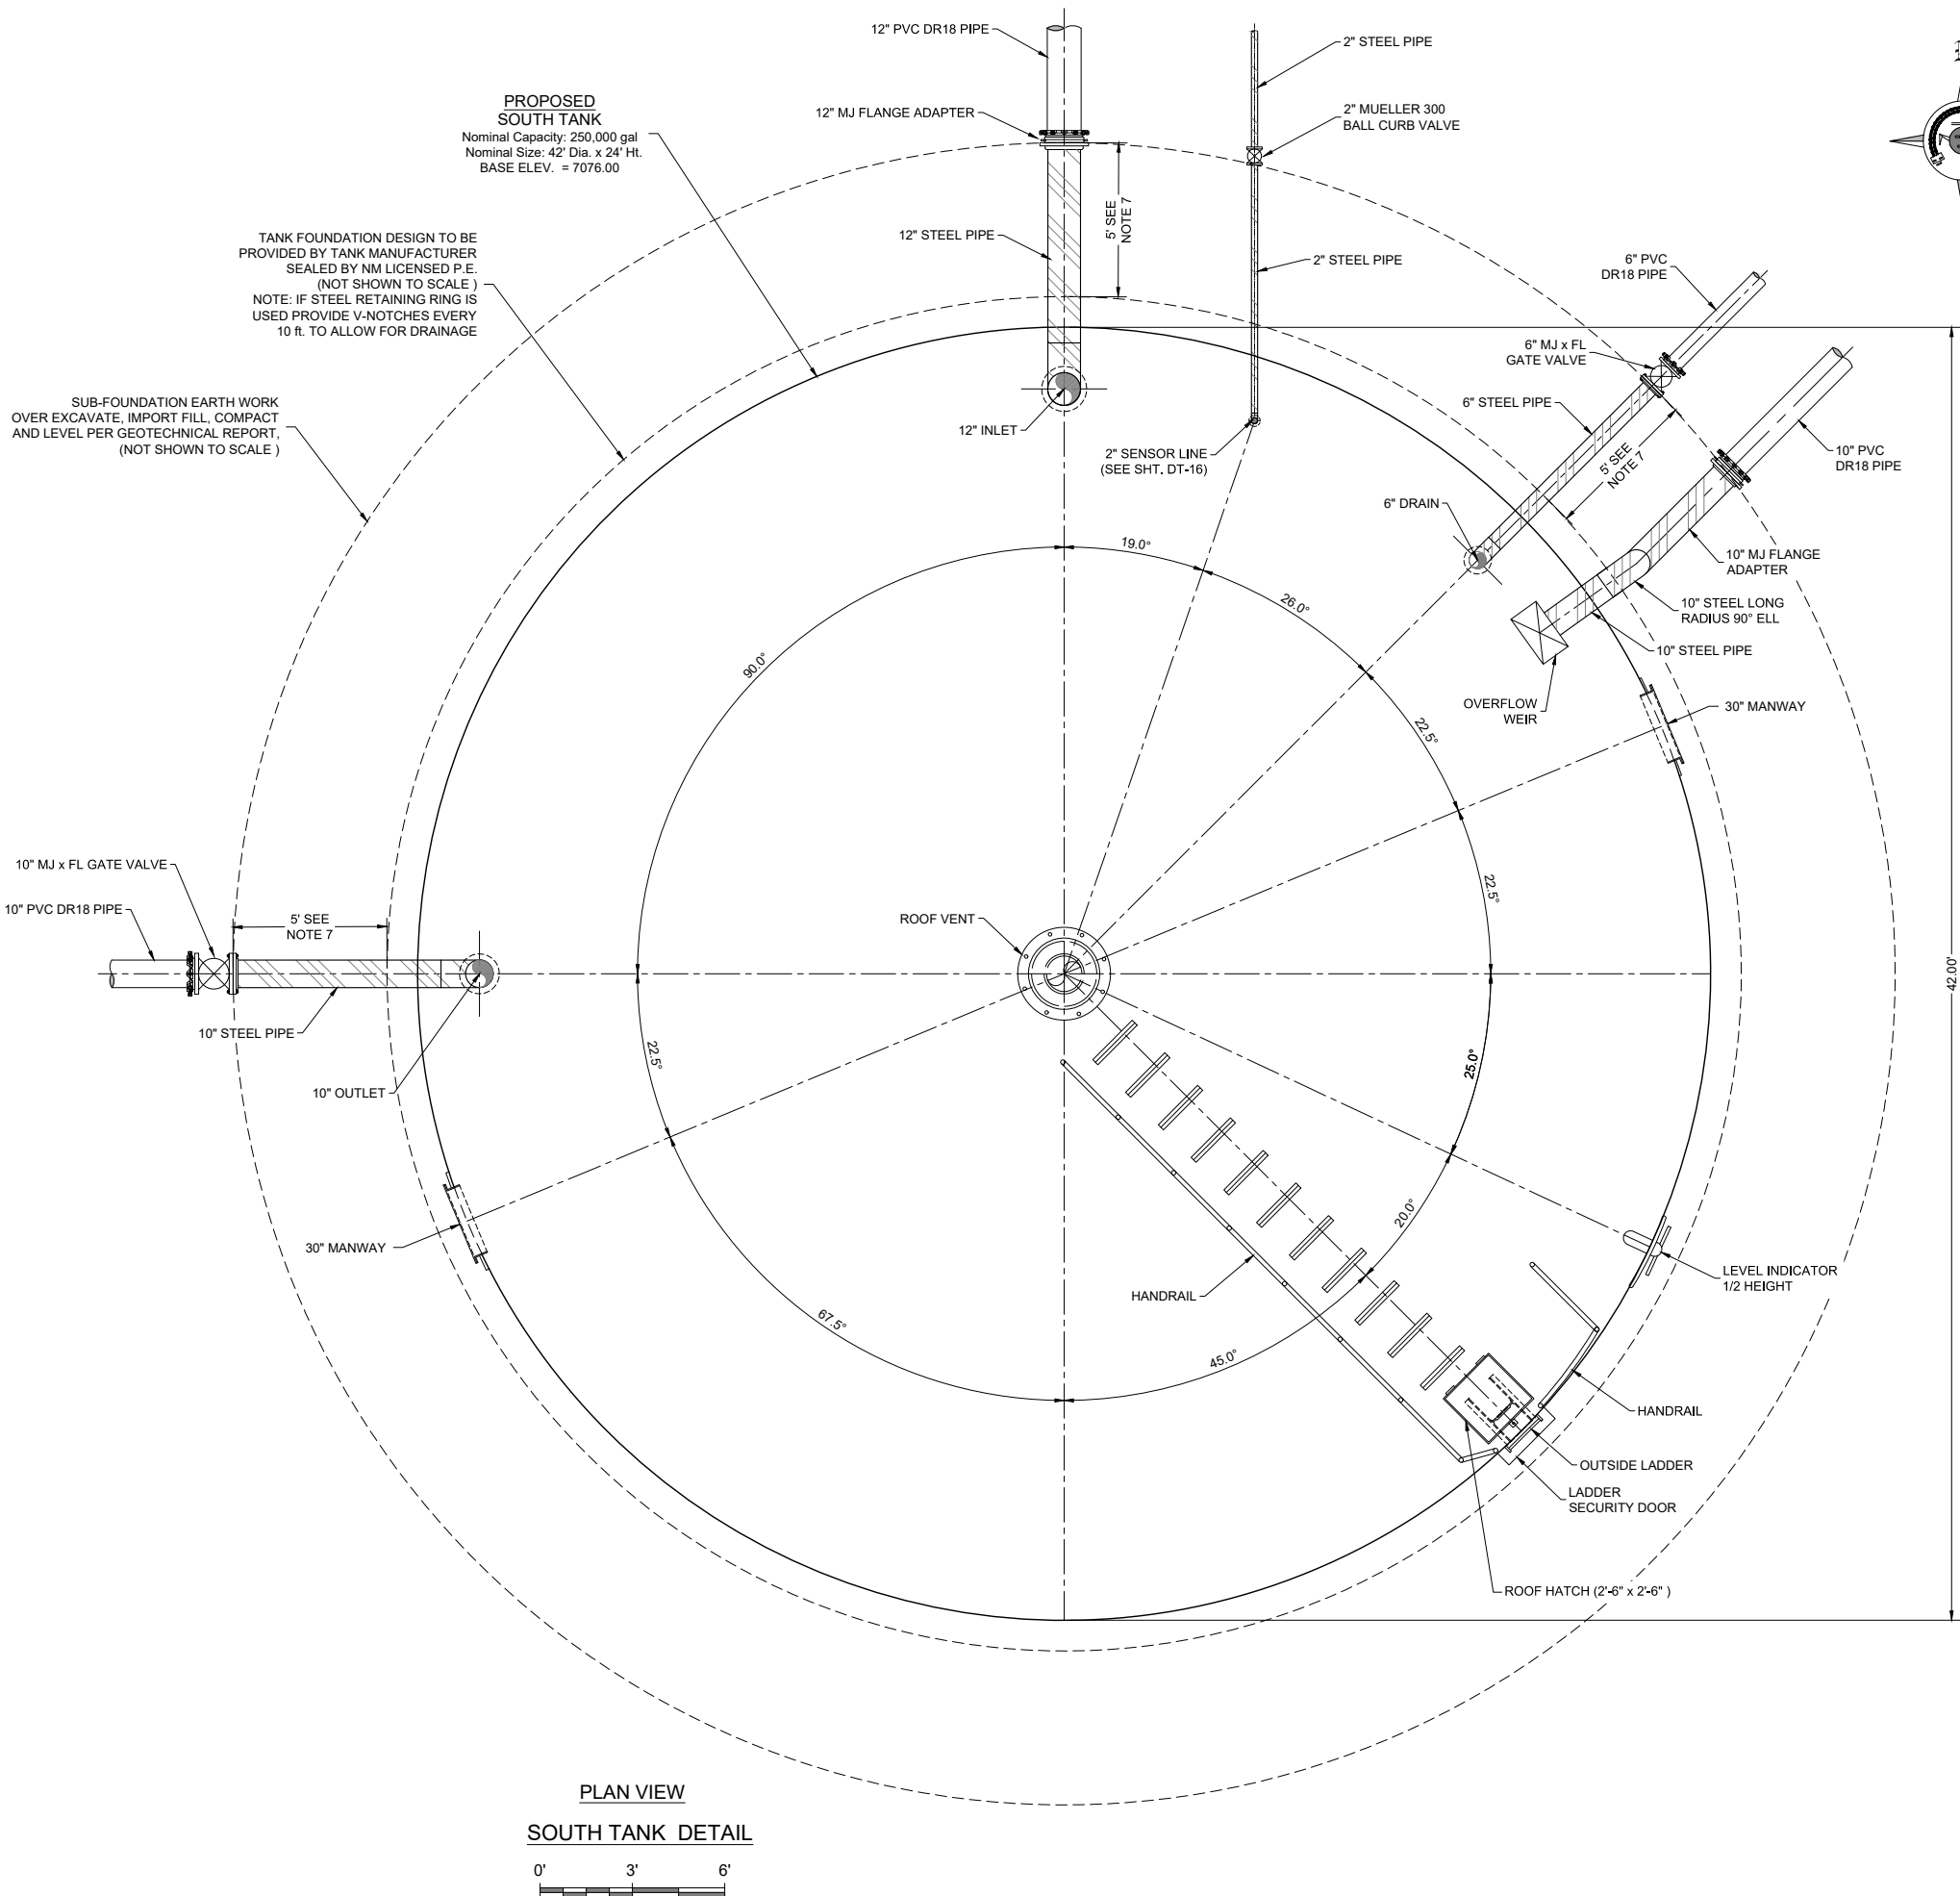

Revision	Date	Description	By	Chk'd

Client: 26.3 Tank Details.dwg
10/27/2018 5:16:55PM aw

SMA
Engineering & Environmental Surveying

SOUDER, MILLER & ASSOCIATES
5454 VENCE AVENUE NE, SUITE D
ALBUQUERQUE, NM 87113
Phone (505) 299-0942 Toll-Free (877) 299-0942 Fax (505) 293-3430
www.soudermiller.com

Serving the Southwest & Rocky Mountains
Albuquerque, Carlsbad, Hobbs, Farmington, Las Cruces, Roswell, Santa Fe, NM
Cortez, Grand Junction, CO - Safford, AZ - Moab, UT - El Paso, TX

CLIENT: The Navajo Nation TOWN: Reach 26.3 To Turren, NM

SOUTH TANK DETAILS (1 of 2)
NAVAJO GALLUP WATER SUPPLY
PROJECT - REACH 26.3
SANDOVAL & MCKINLEY COUNTIES, NEW MEXICO

Designed TTT	Drawn AAV	Checked AGR
-----------------	--------------	----------------

90% REVIEW
DRAFT

PRELIMINARY
NOT FOR CONSTRUCTION

THIS DRAWING IS INCOMPLETE
AND NOT TO BE USED FOR
CONSTRUCTION UNLESS IT IS
STAMPED, SIGNED AND DATED

**NOTICE OF EXTENDED
PAYMENT PROVISION:**
THIS CONTRACT ALLOWS THE
OWNER TO MAKE PAYMENT
WITHIN 45 DAYS AFTER
SUBMISSION OF
AN UNDISPUTED REQUEST
FOR PAYMENT.

811 Know what's
below.
Call before
you dig.

Date: September 27, 2018


Scale: Horiz: 1" = 6'
Vert: N/A

Project No: 6921307

Sheet: **DT-19**


NOTES:

1. FOUNDATION AND TANK STRUCTURAL DESIGN DRAWINGS AND CALCULATIONS (SEALED BY NEW MEXICO-LICENSED PROFESSIONAL ENGINEER) TO BE PROVIDED BY TANK MANUFACTURER. FOUNDATION SHALL BE EITHER CONCRETE OR STEEL RING, BASED ON LICENSED TANK MANUFACTURER'S DESIGN.
2. FOUNDATIONS SHOWN IN DRAWING ARE FOR REFERENCE ONLY. DIAMETER OF FOUNDATION TO BE BASED ON TANK MANUFACTURER'S P.E.'s DESIGNED FOUNDATION.
3. SUB-FOUNDATION PER GEOTECHNICAL INVESTIGATION REPORT (REFER TO GEOTEST REPORT NO. 1-71108 DATED 1-8-2018).
4. TANK COLOR SHALL BE CARLSBAD CANYON TAN.
5. TANK APPURTENANCES SHOWN IN ELEVATION VIEW HAVE BEEN ROTATED INTO VIEW FOR DEPICTION PURPOSES.
6. IF WELDED STEEL TANKS ARE USED, ALL BURIED STEEL PIPE, WELDED FITTINGS AND OTHER COMPONENTS SHALL BE EXTERIOR COATED W/ COAL TAR EPOXY AND COLD APPLIED TAPE COATING PER SPECIFICATIONS, AND INTERIOR COATED TO MATCH TANK INTERIOR SIDE WALL.
- 6A. IF GLASS-FUSED STEEL TANKS ARE USED, ALL 8-INCH STEEL PIPE AND FITTINGS SHALL COLD APPLIED TAPE WRAPPED PER SPECIFICATIONS. ALL 2-INCH STEEL PIPES AND FITTINGS SHALL BE SS 304.
7. WITHIN 5' OF TANK FOUNDATION ALL PIPE SHALL BE STEEL. ALL STEEL PIPE AND FITTINGS UNDERNEATH AND WITHIN 5' OF TANKS OR BUILDINGS SHALL BE SHOP WELDED AND COATED, X-RAY TESTED AND PRESSURE TESTED PRIOR TO POURING FOUNDATIONS. SHOP COATING SHALL BE APPLIED AFTER WELDING.
8. ALL STEEL PIPE AND FITTINGS SHALL BE STANDARD WALL UNLESS OTHERWISE NOTED.
9. ALL BASE AND OVERFLOW ELEVATIONS PROVIDED IN THESE DRAWINGS ARE APPROXIMATE. CONTRACTOR SHALL FIELD SURVEY ELEVATION OF OVERFLOW WEIRS AND ENSURE BOTH TANK'S WEIR ELEVATIONS MATCH WITHIN A TOLERANCE OF $\pm 1/2$ INCHES.
10. ALL STEEL PIPE FLANGES SHALL BE ANSI CLASS 150.
11. EXACT ORIENTATION OF ALL TANK FEATURES AND PIPE PENETRATIONS TO BE DETERMINED IN THE FIELD BY THE ENGINEER. TANK MANUFACTURER SHALL CONFIRM ALL LOCATIONS W/ ENGINEER PRIOR TO FABRICATION. SOME FEATURES MAY BE ROTATED IN ELEVATION VIEW FOR CLARITY.
12. FOUNDATION AND FLOOR SLOPE UPWARDS 1% TOWARD CENTER TO PREVENT "OILCANNING".
13. ALL SITE-CAST CONCRETE SHALL BE MADE WITH TYPE V (ALKALI RESISTIVE) CEMENT AND SHALL ATTAIN A MINIMUM COMPRESSIVE STRENGTH OF 3,000 psi WITHIN 28 DAYS. THE MIX DESIGN SHOULD INCLUDE 5% ($\pm 1\%$) AIR ENTRAINMENT AND SHOULD BE PLACED AND CURED IN ACCORDANCE WITH THE ACI MANUAL OF CONCRETE PRACTICE, VOLUMES 1 THRU 5. SLUMP AT THE TIME OF PLACEMENT SHOULD NOT EXCEED FOUR (4) INCHES, AND MECHANICAL VIBRATION SHOULD BE EMPLOYED FOR CONSOLIDATION TO ELIMINATE VOIDS AND HONEYCOMBING.

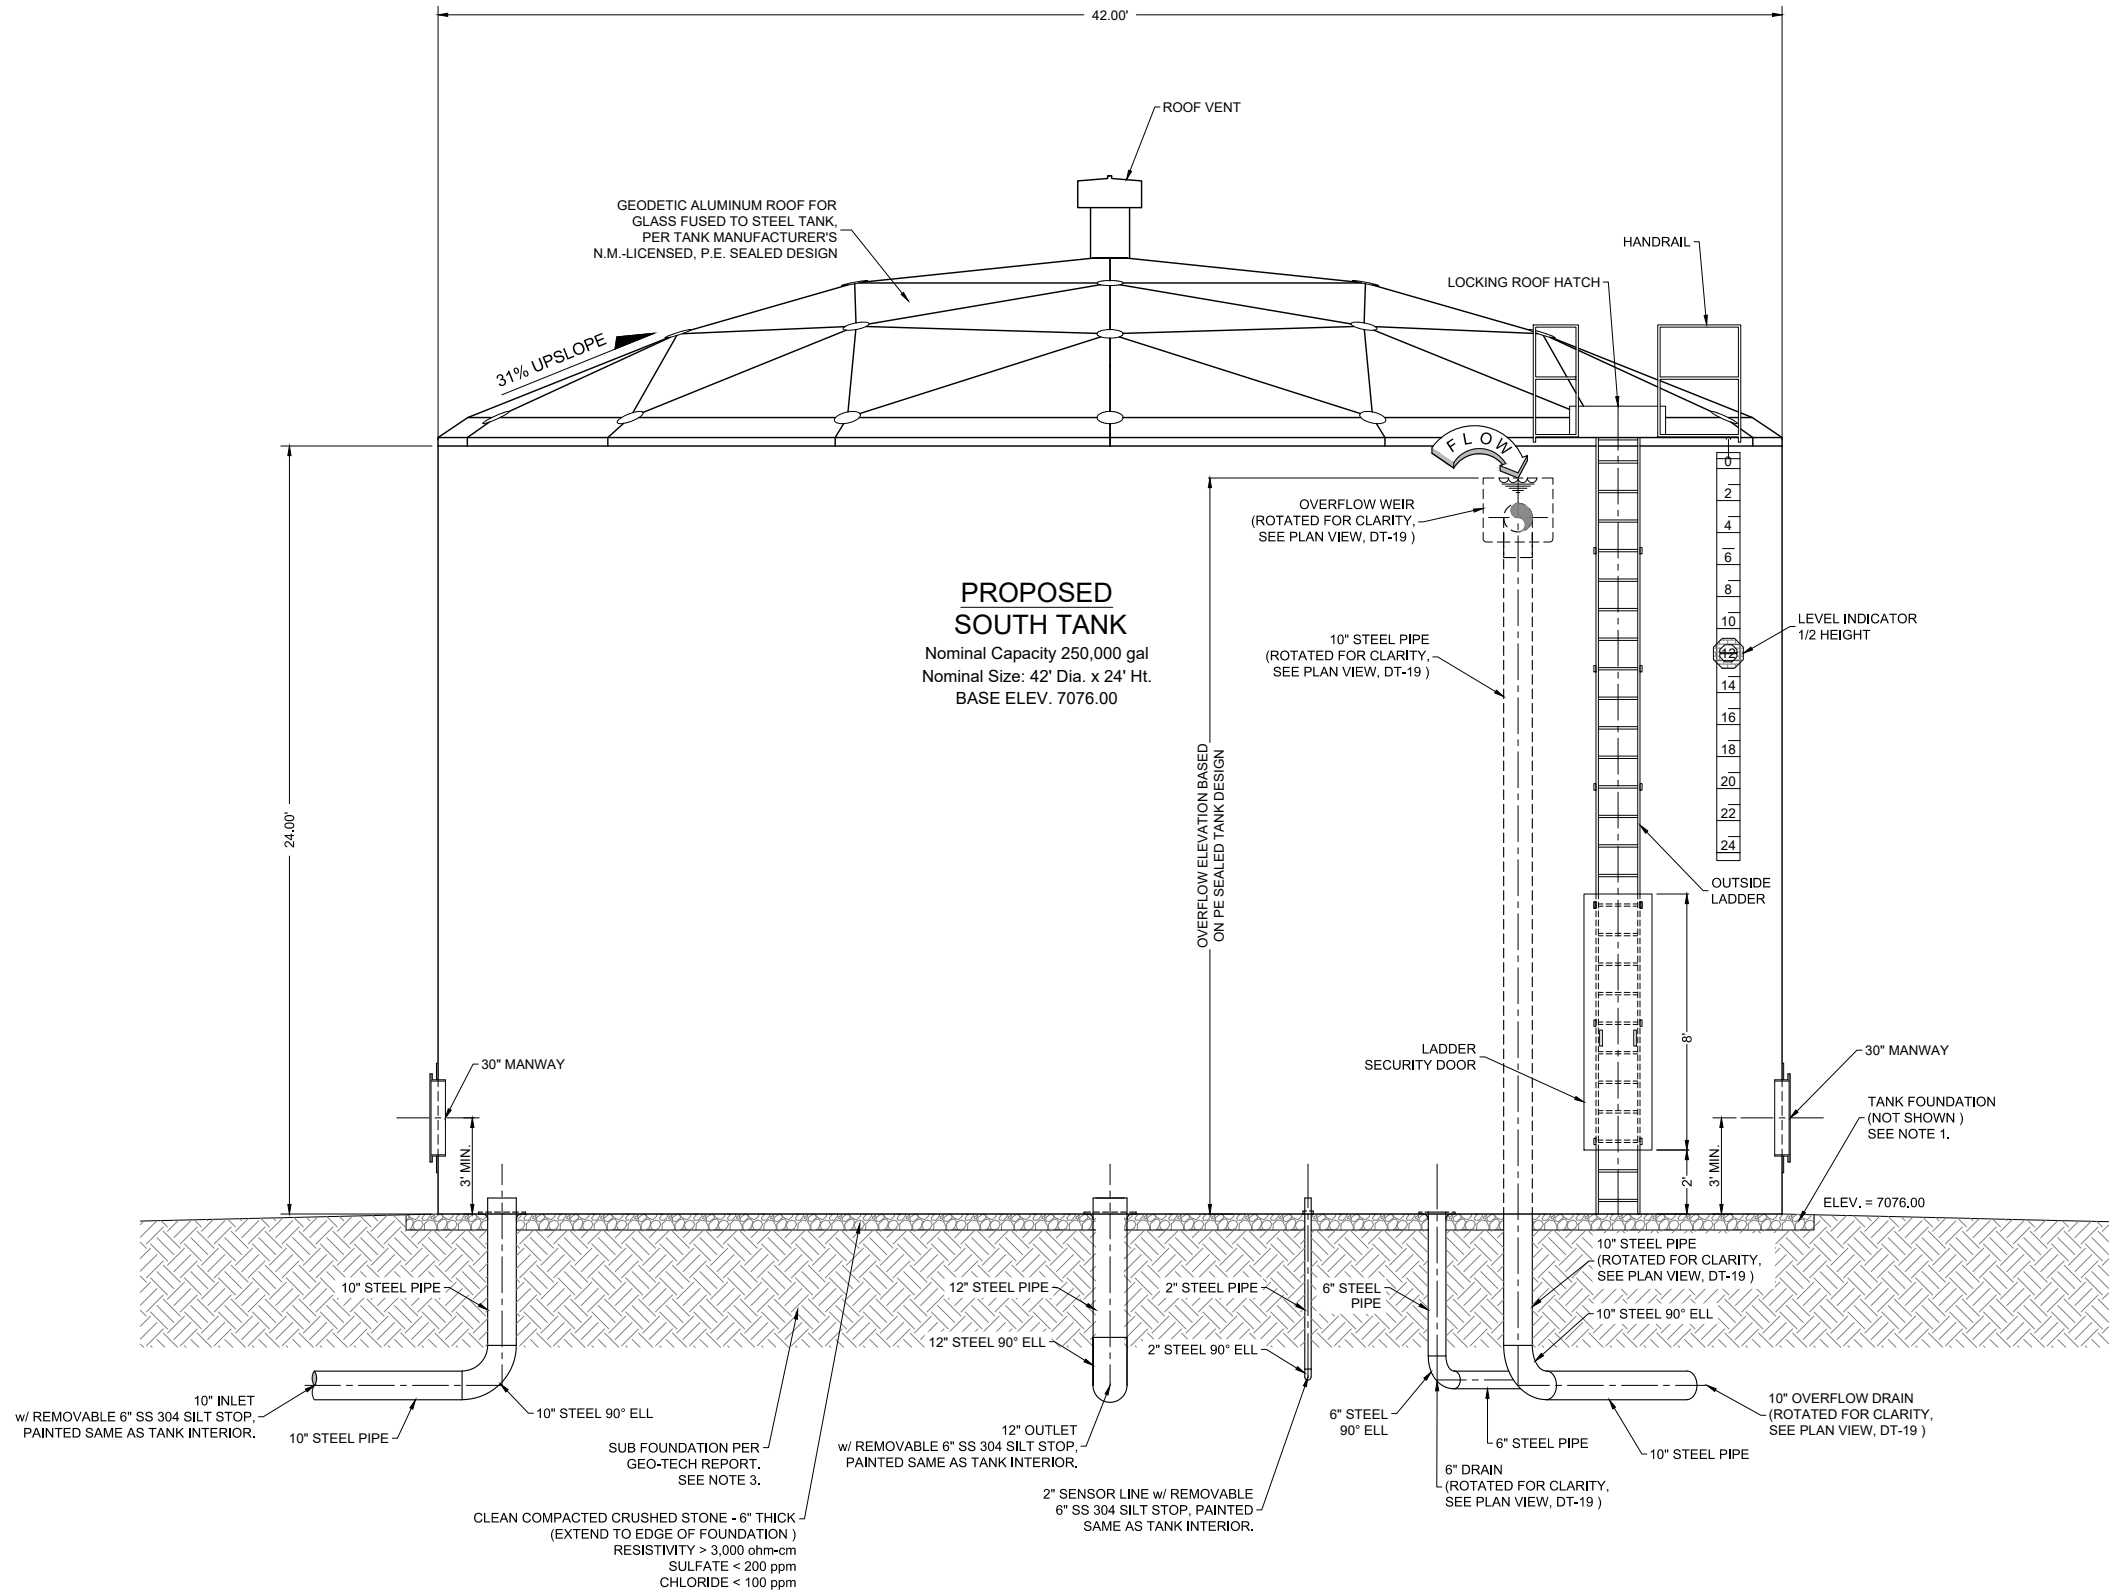

ELEVATION VIEW

SOUTH TANK DETAIL

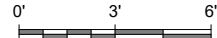

Revision	Date	Description	By	Check

SMA
Engineering & Environmental
Surveying

SOUDER, MILLER & ASSOCIATES
5454 VENCE AVENUE, SUITE D
ALBUQUERQUE, NM 87113
Phone (505) 299-0942 Toll-Free (877) 299-0942 Fax (505) 293-3430
www.soudermiller.com
Serving the Southwest & Rocky Mountains
Albuquerque, Carlsbad, Hobbs, Farmington, Las Cruces, Roswell, Santa Fe, NM
Conter, Grand Junction, CO - Safford, AZ - Moab, UT - El Paso, TX

CLIENT: The Navajo Nation TOWN: Reach 26.3 To Tonnore, NM

SOUTH TANK DETAILS (2 of 2)
NAVAJO GALLUP WATER SUPPLY
PROJECT - REACH 26.3
SANDOVAL & MCKINLEY COUNTIES, NEW MEXICO

Designed	Drawn	Checked
TTT	AAV	AGR

90% REVIEW
DRAFT

PRELIMINARY
NOT FOR CONSTRUCTION

THIS DRAWING IS INCOMPLETE
AND NOT TO BE USED FOR
CONSTRUCTION UNLESS IT IS
STAMPED, SIGNED AND DATED

**NOTICE OF EXTENDED
PAYMENT PROVISION:**
THIS CONTRACT ALLOWS THE
OWNER TO MAKE PAYMENT
WITHIN 45 DAYS AFTER
SUBMISSION OF
AN UNDISPUTED REQUEST
FOR PAYMENT.


811 Know what's
below.
Call before
you dig.

Date: September 27, 2018

Scale: Horiz: 1" = 6'
Vert: N/A


Project No: 6921307

Sheet: **DT-20**

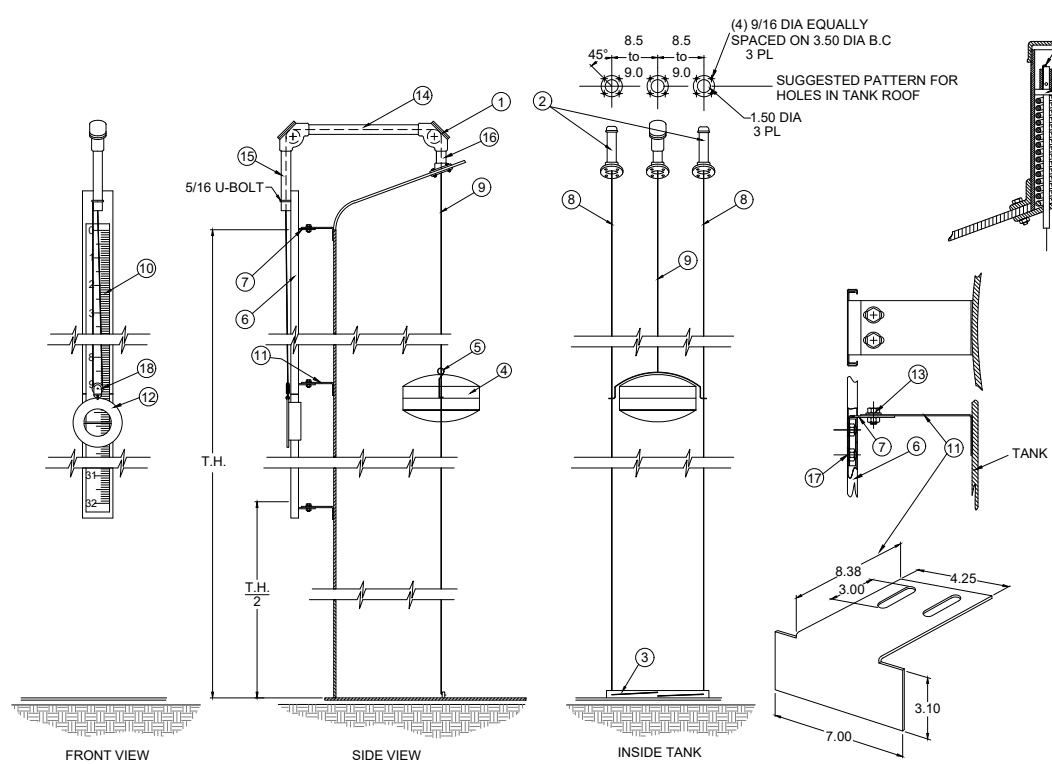


TYPICAL HALF HEIGHT LIQUID INDICATOR DETAILS
NOT TO SCALE

ITEM	NAME	MATERIAL
1	ELBOW, 90°	TEMPERATURE ULTEM PULLEY A356 ALUMINUM WITH HIGH
2	TOP ANCHOR TENSIONER	WITH STAINLESS STEEL SPRING HDG STEEL TENSIONER ASSEMBLY
3	BOTTOM ANCHOR	STAINLESS STEEL ANGLE
4	S/S FLOAT- 16#	WELD, FOAM FILLED .045H STAINLESS STEEL
5	CABLE FASTENERS	304 STAINLESS STEEL CRIMP & THIMBLE
6	GAUGE BOARD	16 GA HDG "C" CHANNEL
7	STD. TP BRACKETS	STAINLESS STEEL
8	FLOAT GUIDE WIRE	1/8" - 304 STAINLESS STEEL
9	FLOAT CABLE	3/32" - 304 STAINLESS STEEL
10	GAGE TAPE	ADHESIVE BACKED VINYL
11	BRACKET	STAINLESS STEEL
12	ROUND TARGET-9.5#	RED, POWDER COATED, DUCT. IRON
13	BOLT & NUT SETS	304 STAINLESS STEEL
14	PIPE (INCLUDED IN KIT)	1-1/2" x 16 HDG PIPE
15	PIPE (INCLUDED IN KIT)	1-1/2" x 14 HDG PIPE W/ PLUG
16	PIPE (INCLUDED IN KIT)	1-1/2" x 4 HDG PIPE
17	TRUSS HEAD S/S BOLTS, NYLOC NUTS & WASHERS	
18	1/2 TRAVEL PULLEY	STAINLESS STEEL

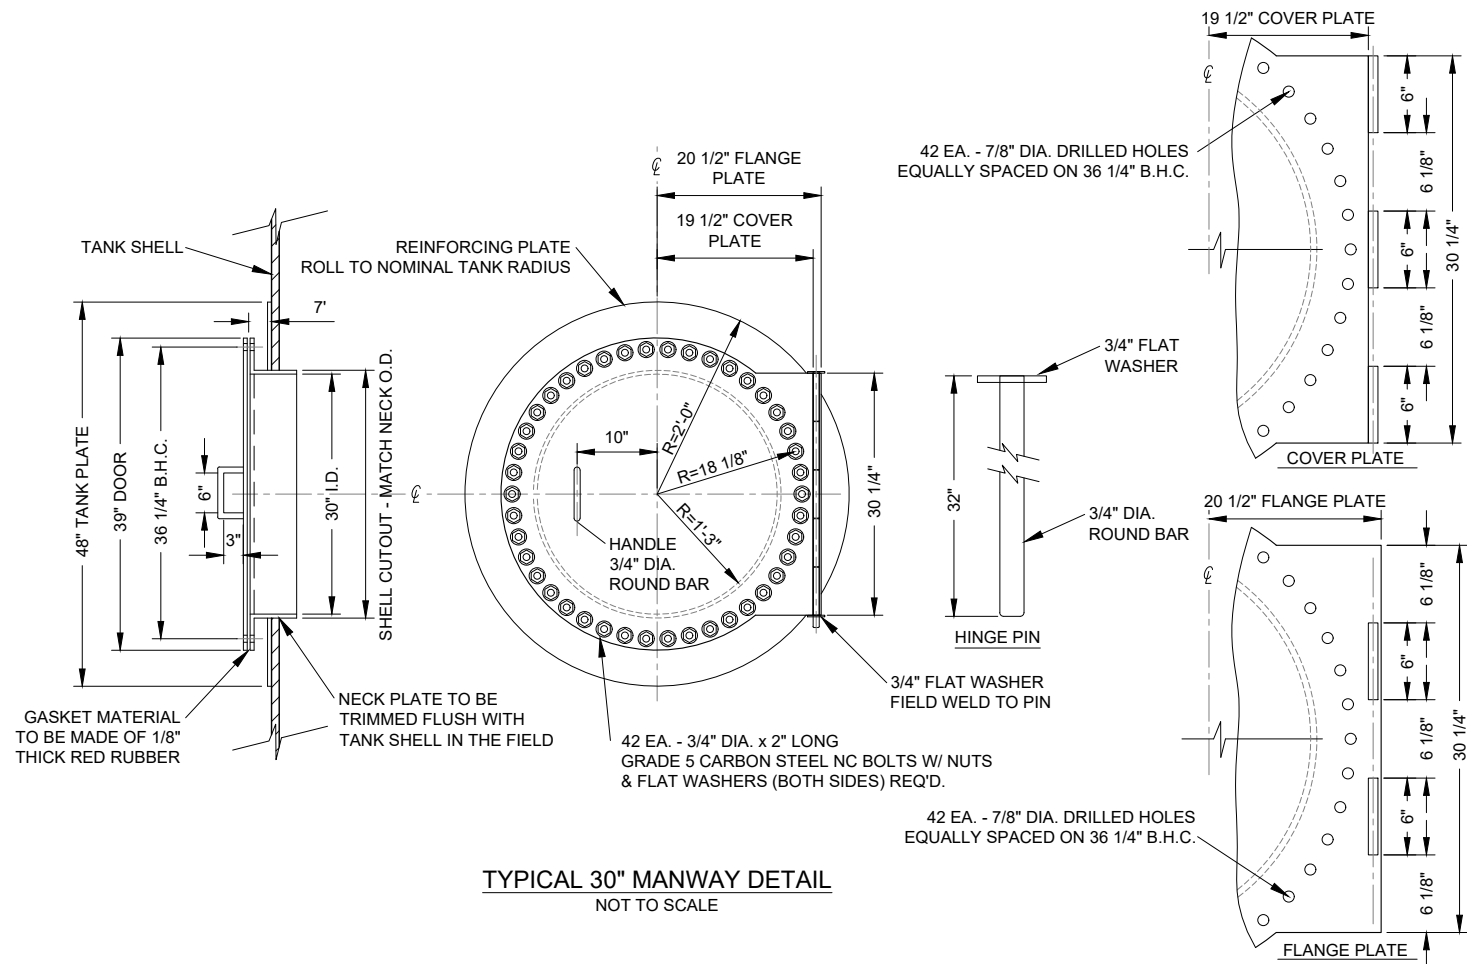


TYPICAL 30" MANWAY DETAIL
NOT TO SCALE

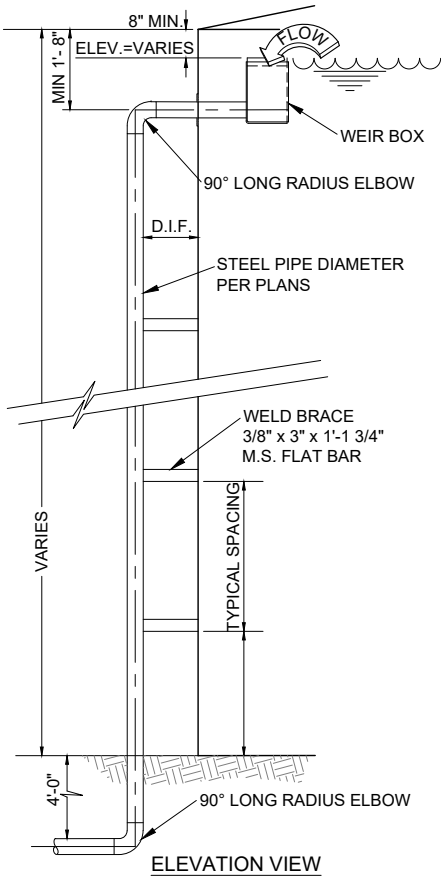

TYPICAL TANK OVERFLOW DETAIL
NOT TO SCALE

SEE TANK PLAN AND ELEVATION SHEETS DT-17 THRU DT-20, FOR PIPE SIZE, HEIGHT AND ELEVATION.

- NOTE:
- DIMENSIONS INDICATING SEPARATION BETWEEN WEIR FROM ROOF ARE MINIMUMS ONLY. ACTUAL DIMENSIONS MAY BE GREATER TO ACCOMMODATE SLOSH WAVE, AS CALCULATED BY TANK MANUFACTURER.
 - SHOP PAINT ALL RAFTER'S, SEE PAINT SCHEDULE FOR INTERIOR PRIME AND FINISH COATINGS.
 - TANK MANUFACTURER SHALL PROVIDE DESIGN CALCULATIONS AND FABRICATION DRAWINGS SEALED BY A NEW MEXICO LICENSED PROFESSIONAL ENGINEER.

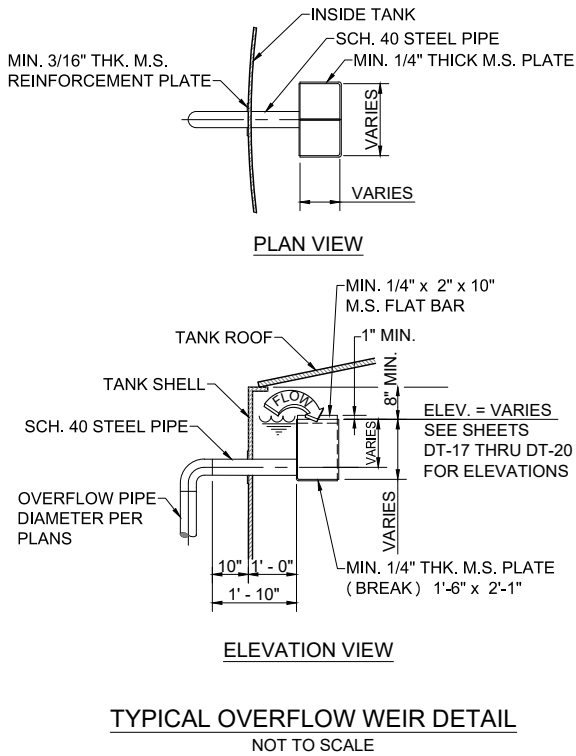

TYPICAL OVERFLOW WEIR DETAIL
NOT TO SCALE

NOTE:
DIMENSIONS OF WEIR AND APPURTENANCES PROVIDED ARE MINIMUMS. ACTUAL DIMENSIONS MAY BE LARGER TO PROVIDE FOR DESIGN FLOW RATES SPECIFIED IN THE TECHNICAL SPECIFICATIONS. ACTUAL WEIR DIMENSIONS SHALL BE PROVIDED AS PART OF THE TANK MANUFACTURER'S PROFESSIONAL ENGINEER SEALED DESIGN.

Revision	Date	Description	By	Chk'd

CLIENT: The Navajo Nation TOWN: Reach 26.3 To Torreon, NM

TYPICAL WATER STORAGE TANK DETAILS (1 of 2)

NAVAJO GALLUP WATER SUPPLY PROJECT - REACH 26.3

SANDOVAL & MCKINLEY COUNTIES, NEW MEXICO

DESIGNED: TTT DRAWN: AAV CHECKED: AGR

90% REVIEW DRAFT

PRELIMINARY NOT FOR CONSTRUCTION

THIS DRAWING IS INCOMPLETE AND NOT TO BE USED FOR CONSTRUCTION UNLESS IT IS STAMPED, SIGNED AND DATED

NOTICE OF EXTENDED PAYMENT PROVISION: THIS CONTRACT ALLOWS THE OWNER TO MAKE PAYMENT WITHIN 45 DAYS AFTER SUBMISSION OF AN UNDISPUTED REQUEST FOR PAYMENT.

811 Know what's below. Call before you dig.


Date: September 27, 2018

Scale: Horiz: NONE Vert: N/A


Project No: 6921307

Sheet: DT-21


SOUDER, MILLER & ASSOCIATES
5454 VANCE AVENUE NE, SUITE D
ALBUQUERQUE, NM 87113
Phone (505) 299-0942 Toll-Free (877) 299-0942 Fax (505) 293-3430
www.soudermiller.com
Serving the Southwest & Rocky Mountains
Albuquerque, Carlsbad, Hobbs, Farmington, Las Cruces, Roswell, Santa Fe, NM
Concepcion, Grand Junction, CO - Safford, AZ - Moab, UT - El Paso, TX
9/27/2018 5:16:59PM aw

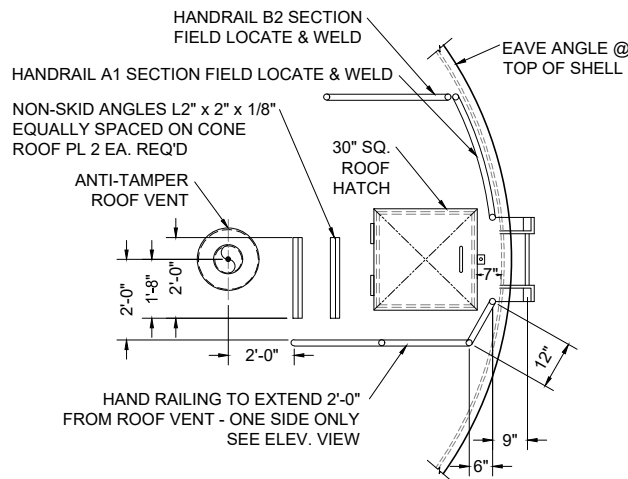


PLAN VIEW
NOT TO SCALE

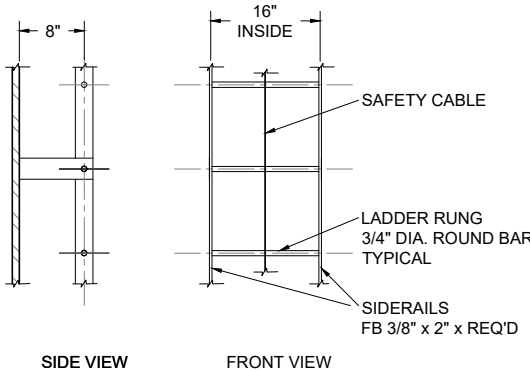


LADDER DETAILS
NOT TO SCALE

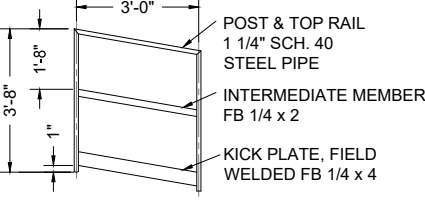


HANDRAIL B2 DETAIL
NOT TO SCALE

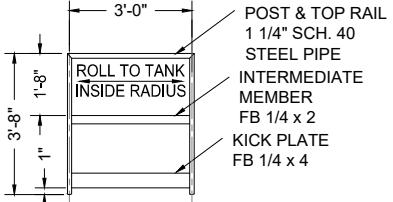


HANDRAIL A1 DETAIL - ONE REQ'D
NOT TO SCALE

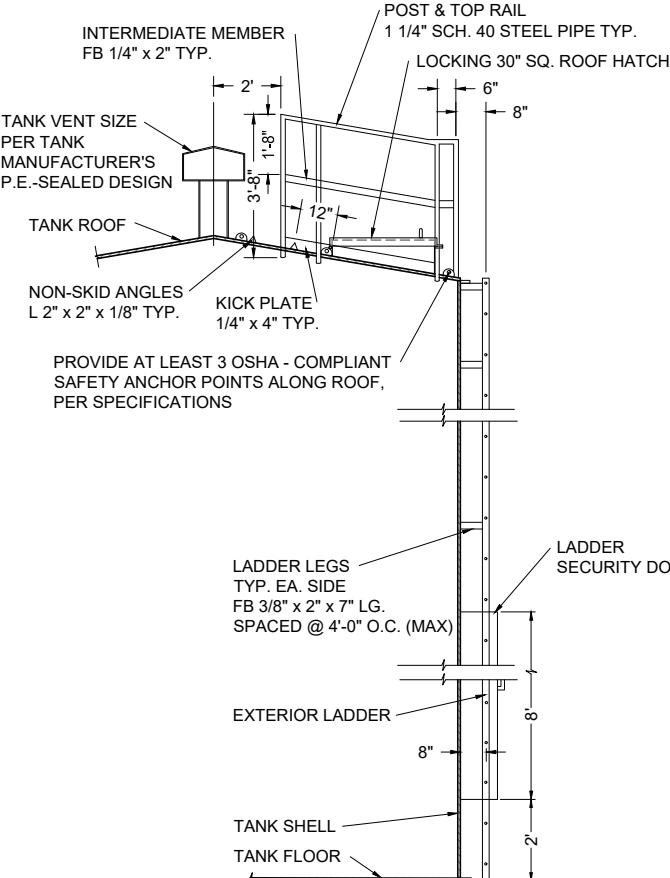

TANK CUTAWAY ELEVATION VIEW

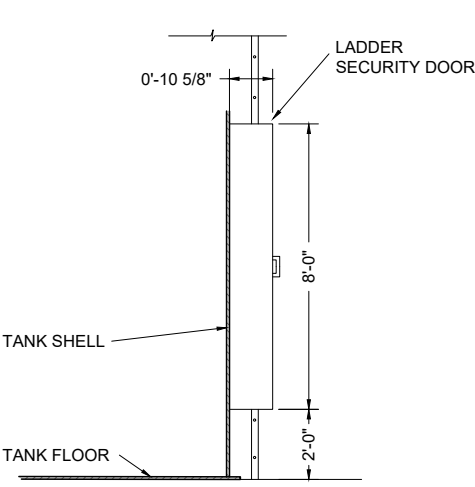


SIDE VIEW
NOT TO SCALE

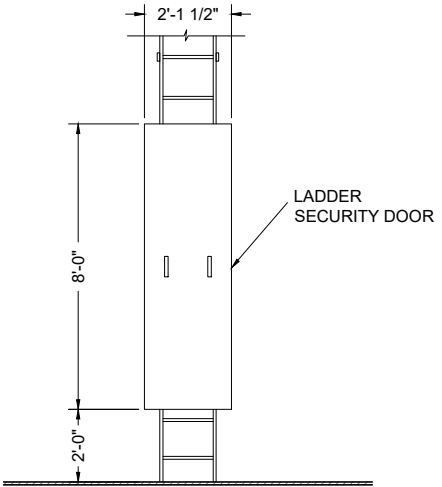

FRONT VIEW
NOT TO SCALE


LADDER SECURITY DOOR DETAILS
NOT TO SCALE

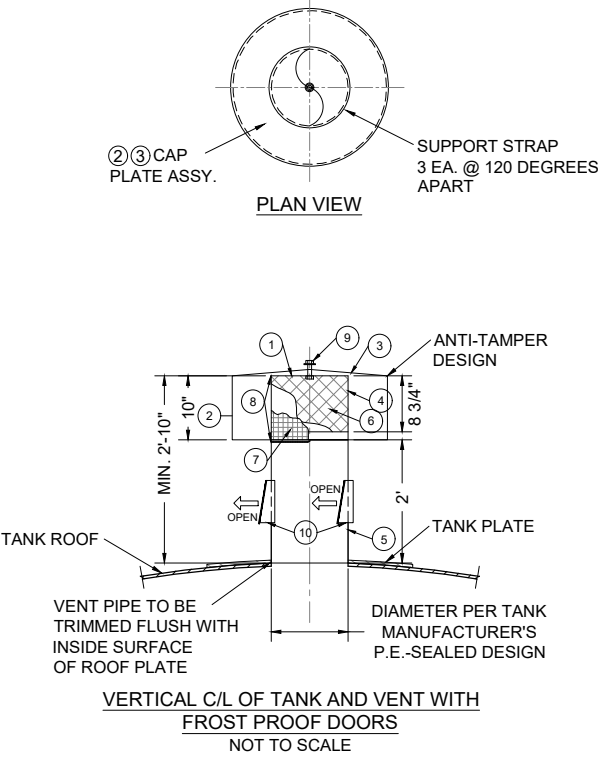

VERTICAL C/L OF TANK AND VENT WITH
FROST PROOF DOORS
NOT TO SCALE


BILL OF MATERIALS		
ITEM	QTY.	DESCRIPTION
①	1	3/16" THK. M.S. PLATE (CUT) 1' - 0" 3/4" Ø
②	1	10 GA. H.R. SHEET (ROLL) 10" x 6' - 3 3/8"
③	1	12 GA. H.R. SHEET (CUT) 2' - 0" Ø
④	3	3/16" x 1" M.S. FLAT BAR x 8 9/16"
⑤	1	1/4" THK. M.S. PLATE (ROLL) 16" x 3' - 2 1/2"
⑥	1	3/4 - #9 FLAT EXP. METAL (ROLL) 8 3/4" x 3' - 4"
⑦	1	24 MESH SCREEN (SST) 12" x 3' - 7"
⑧	2	STAINLESS STEEL WORM CLAMP (SST) 3/4" x 3' - 7"
⑨	1	1/2" x 3" HEX BOLT WITH (GRADE 2) NUT, & FLAT WASHER
⑩	4	6" x 8" FREEZE PROTECTION DOOR

VERTICAL ROOF VENT DETAIL
NOT TO SCALE

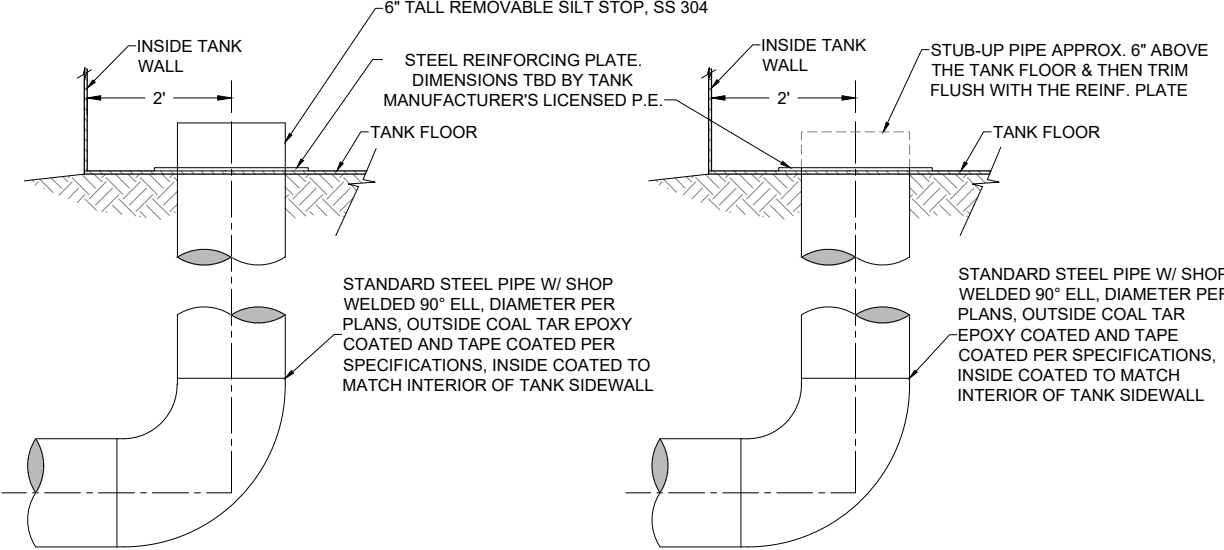


ELEVATION VIEW

2", 8", 10" OR 12" INLET / OUTLET
AND SENSOR LINE DETAIL
NOT TO SCALE

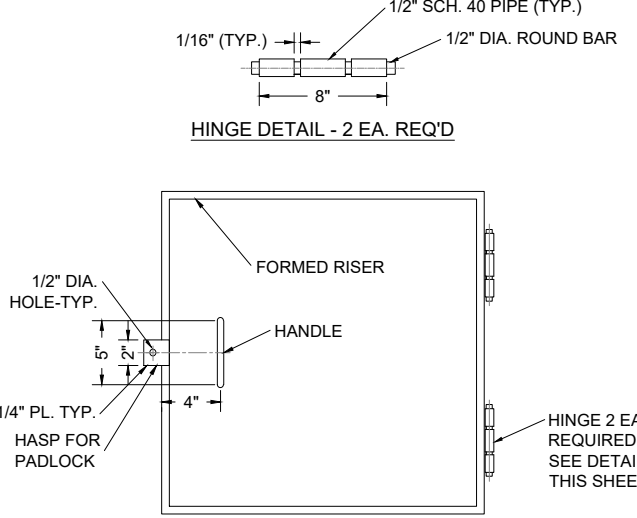

PLAN VIEW
30" SQUARE ROOF HATCH DETAIL
NOT TO SCALE

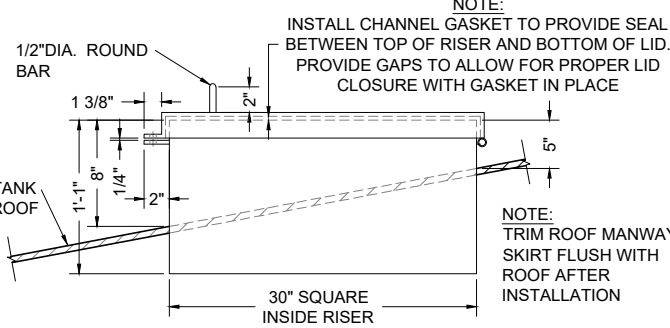

ELEVATION VIEW

30" SQUARE ROOF HATCH DETAIL
NOT TO SCALE


Revision	Date	Description	By	Check

SOUDER, MILLER & ASSOCIATES
5454 VENCE AVENUE NE, SUITE D
ALBUQUERQUE, NM 87113
Phone (505) 299-0942 Toll-Free (877) 299-0942 Fax (505) 293-3430
www.soudmiller.com
Serving the Southwest & Rocky Mountains
Albuquerque, Carlsbad, Hobbs, Farmington, Las Cruces, Roswell, Santa Fe, NM
Conter, Grand Junction, CO - Safford, AZ - Moab, UT - El Paso, TX


CLIENT: The Navajo Nation TOWN: Reach 26.3 To Torreon, NM
TYPICAL WATER STORAGE TANK DETAILS (2 of 2)
NAVAJO GALLUP WATER SUPPLY
PROJECT - REACH 26.3
SANDOVAL & MCKINLEY COUNTIES, NEW MEXICO

Designed TTT	Drawn AAV	Checked AGR
-----------------	--------------	----------------

90% REVIEW
DRAFT
PRELIMINARY
NOT FOR CONSTRUCTION
THIS DRAWING IS INCOMPLETE
AND NOT TO BE USED FOR
CONSTRUCTION UNLESS IT IS
STAMPED, SIGNED AND DATED
NOTICE OF EXTENDED
PAYMENT PROVISION:
THIS CONTRACT ALLOWS THE
OWNER TO MAKE PAYMENT
WITHIN 45 DAYS AFTER
SUBMISSION OF
AN UNDISPUTED REQUEST
FOR PAYMENT.
811 Know what's
below.
Call before
you dig.
Date: September 28, 2018
Scale: Horiz: NONE
Vert: N/A
Project No: 6921307
Sheet: DT-22

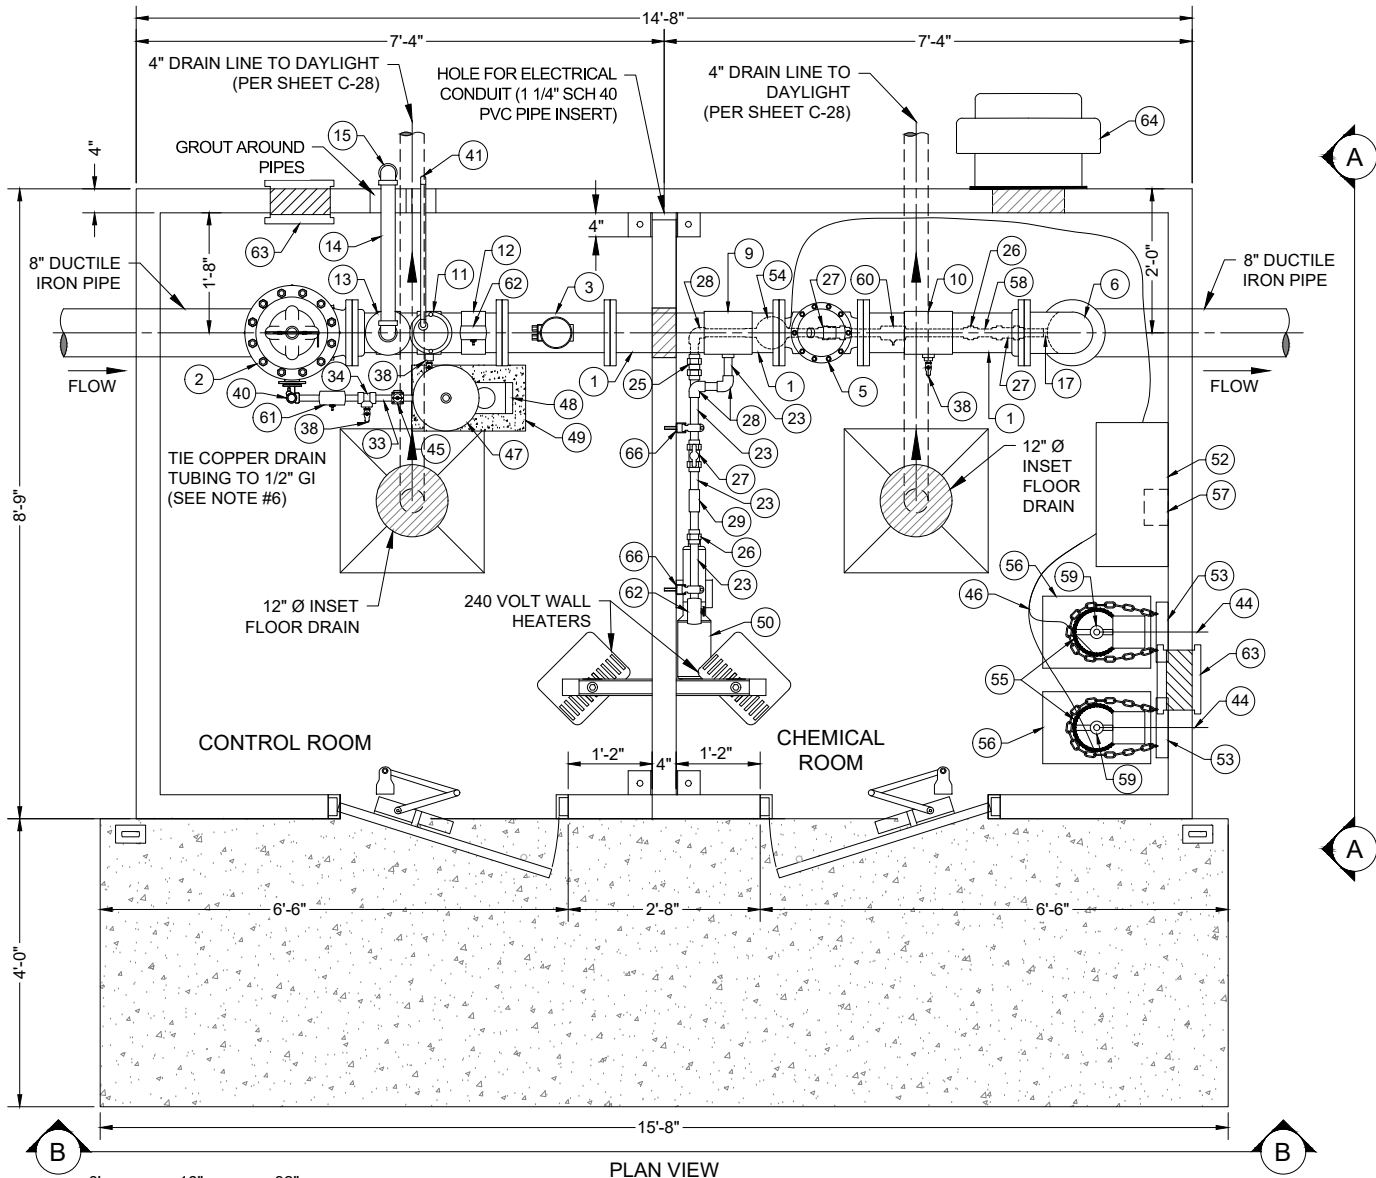

PLAN VIEW
REACH 26.3 TANK CHLORINATION SYSTEM DETAIL

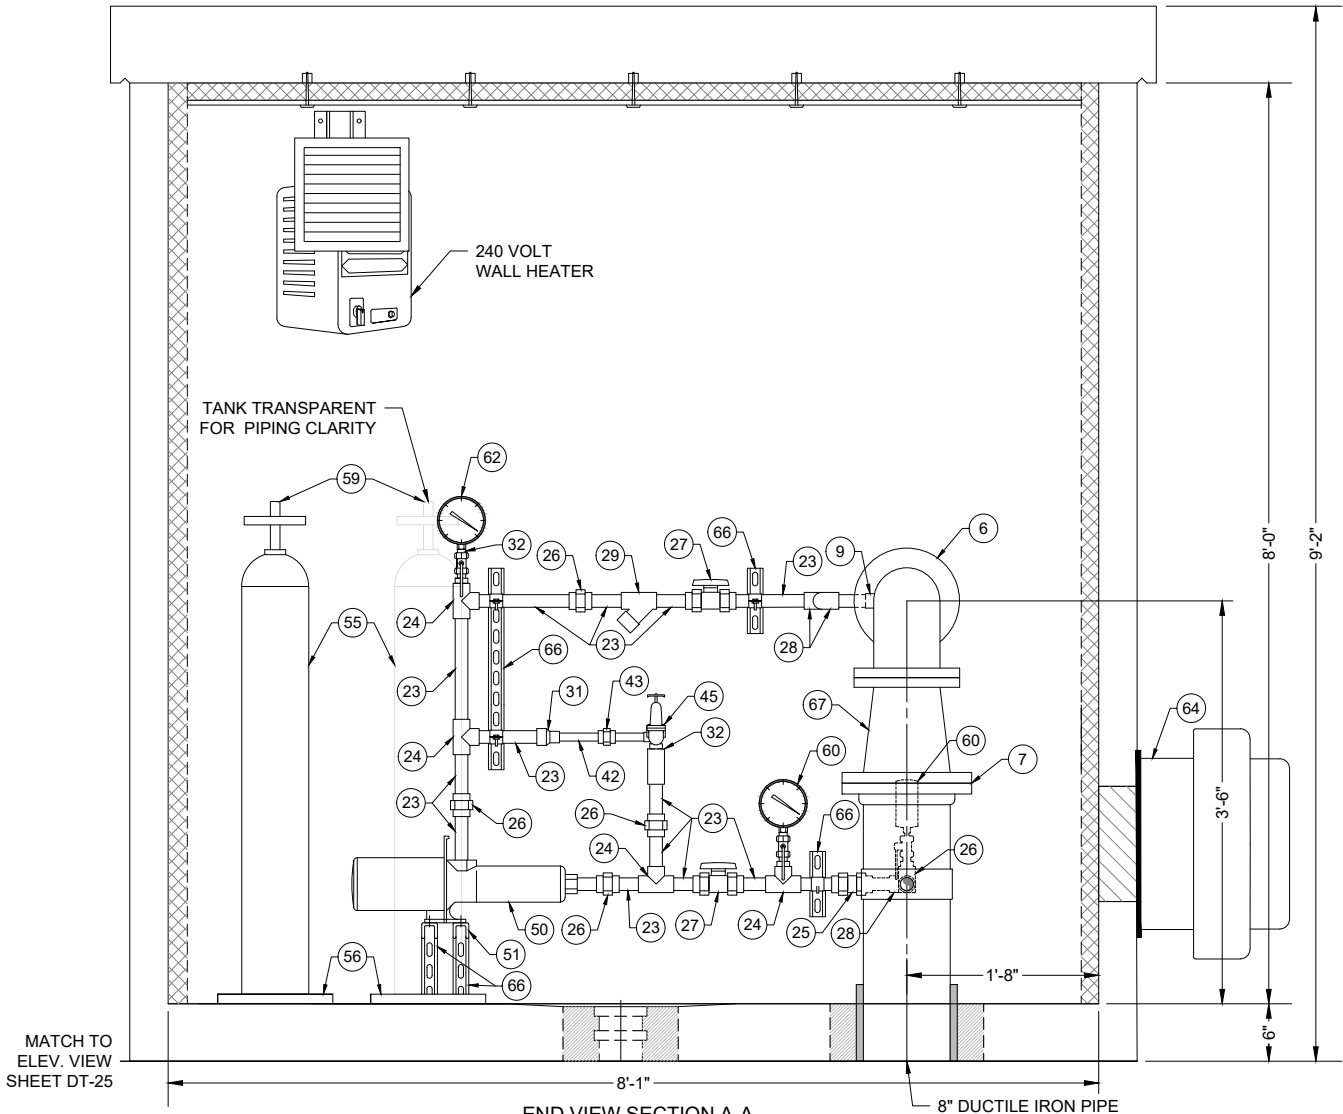

END VIEW SECTION A-A
REACH 26.3 TANK CHLORINATION SYSTEM DETAIL

1	6" DUCTILE IRON PIPE
2	6" FLANGED FULL-PORT ELECTRONIC FLOW CONTROL VALVE, CLA-VAL 131A-57 FHBYCSKCKOP-X105LCW-N (0-160 PSI INLET/OUTLET GAUGES) W/ CLA-VAL VC-22D CONTROLLER
3	6" FLANGED ELECTRONIC FLOW METER, ELSTER EVOQ4, MAINTAIN STRAIGHT PIPE >30" IN FRONT AND >12" BEHIND CENTER OF METER.
4	6" BALL VALVE, FL x FL WITH GEARED ACTUATOR. DI WITH FLANGE ISOLATION KIT.
5	4" CHECK VALVE, SURGE BUSTER SERIES 7200 (O.A.E.)
6	6" 90° FL x FL ELBOW, DI
7	8" FLANGE ISOLATION KIT
8	6" x 2" TAPPING SADDLE, DI
9	6" x 1" TAPPING SADDLE, SS 304
10	6" x 3/4" TAPPING SADDLE, SS 304
11	6" x 3/4" TAPPING SADDLE, DI
12	6" x 1/4" TAPPING SADDLE, DI
13	2" VACUUM BREAKER WITH 1" ARV ASSEMBLY, SEE DETAIL "A" (SHT. DT-24). VENT VACUUM BREAKER AND ARV OUTSIDE BUILDING.
14	2" GALVANIZED STEEL PIPE, NPT
15	2" 90° ELBOW, GALVANIZED STEEL
16	1" GALVANIZED STEEL PIPE, NPT
17	8" x 1" TAPPING SADDLE, SS 316
18	1" 90° ELBOW, GALVANIZED STEEL
19	1" 45° ELBOW, GALVANIZED STEEL
20	1" CHECK VALVE, GALVANIZED STEEL
21	1" UNION, GALVANIZED STEEL
22	1" BALL VALVE, STAINLESS STEEL
23	1" PVC SCHED 80 PIPE
24	1" TEE, PVC SCHED 80
25	1" TRUE UNION CHECK VALVE, PVC SCHED 80
26	1" UNION, PVC SCHED 80

27	1" TRUE UNION BALL VALVE, PVC SCHED 80
28	1" 90° ELBOW, PVC SCHED 80
29	1" Y-STRAINER, PVC SCHED 80
30	NOT USED
31	1" x 1/2" REDUCER, PVC SCHED 80
32	1" x 1/2" PVC BUSHING
33	3/4" GALVANIZED STEEL PIPE, NPT
34	3/4" TEE, GALVANIZED STEEL
35	3/4" 90° ELBOW, GALVANIZED STEEL
36	3/4" UNION, GALVANIZED STEEL
37	3/4" BALL VALVE, STAINLESS STEEL
38	3/4" HOSE BIB WITH VACUUM BREAKER
39	3/4" x 1/2" GALVANIZED STEEL BUSHING
40	3/4" GALVANIZED x 3/8" COPPER BUSHING, WITH 3/8" COPPER TUBING TO CONTROL VALVE PILOT TUBING
41	1/2" 90° ELL & 1/2" GALVANIZED STEEL PIPE (PAINTED BLUE) WITH DOWNSPOUT
42	1/2" PVC SCHED 80 PIPE
43	1/2" UNION, PVC SCHED 80
44	1/2" PE VENT TUBING (WALL PENETRATION MUST BE BELOW REGULATORS)
45	1/2" PRESSURE RELIEF VALVE, WATTS BP 30 (O.A.E.) PRESSURE SET TO 90 PSI
46	3/8" PE VACUUM TUBING
47	7.6 GALLON PRESSURE TANK, WELL-X-TROL WX-103 (O.A.E.), INSTALL PIPE CLAMPS/SUPPORT UNDER TANK AND ANCHOR TO WALL
48	BOOSTER PUMP WITH INTEGRATED PRESSURE SWITCH (30-50 psi) DISCHARGE PRESSURE GAUGE AND DISCHARGE CHECK VALVE, 1" NPT INLET, 3/4" NPT OUTLET, 1/4" 100 PSI PE TUBING, TP PUMP MODEL #TPA-CM1-4-AUTO, 232 PSI
49	CONCRETE PEDESTAL FOR BOOSTER PUMP, 19"L x 11"W x 12"H, (OR PER PUMP DIMENSIONS) 4000 PSI CONCRETE W/ #4 REBAR / ANCHOR BOLTS
50	BOOSTER PUMP, FRANKLIN BT4 5JBT03S4 (O.A.E.)

51	SS UNISTRUT PEDESTAL FOR CHLORINATION PUMP. DIMENSIONS TO BE DETERMINED UPON APPROVAL OF PUMP SUBMITTAL BY CONTRACTOR. 9" ABOVE FLOOR.
52	CHLORINE GAS CONTROL PANEL, WALLACE & TIERNAN S10K (O.A.E.)
53	WALL MOUNTED CHAIN BRACKET, INSTALL 40" ABOVE FLOOR, WITH SAFETY CHAIN
54	CHLORINE INJECTOR, WALLACE & TIERNAN S10K W/ 99D THROAT/TAIL PIECE (O.A.E.) W/ PVC/TEFLON DIAPHRAM VALVE ON VACUUM LINE WITH PEDESTAL. SUPPORT WITH UNISTRUTS.
55	CHLORINE GAS CYLINDER, 150 LB (DO NOT INSTALL)
56	ELECTRONIC CHLORINE CYLINDER SCALE, FORCE FLOW GR150-2 W/ FORCE FLOW SOLO G2 DIGITAL INDICATOR (O.A.E.), BOLTED TO FLOOR
57	CHLORINE GAS DETECTOR SENSOR/TRANSMITTER, WALLACE & TIERNAN ACUTEC 35 W/ AUTOTEST (O.A.E.), MOUNTED 6" ABOVE FLOOR, LOCATION TBD BY ENGINEER IN FIELD. CHLORINE GAS DETECTOR RECEIVER, WALLACE & TIERNAN ACUTEC 35 (O.A.E.) LOCATION AS INDICATED IN ELECTRICAL PLANS OR TBD BY ENGINEER IN FIELD.
58	INSERTION DIFFUSER, MTE (O.A.E.)
59	VACUUM REGULATOR, WALLACE & TIERNAN 210S (O.A.E.)
60	PRESSURE GAUGE, 0-100 PSI, WITH PVC/TEFLON DIAPHRAM SEAL AND 1/2" BALL VALVE, STAINLESS STEEL
61	PRESSURE GAUGE, 0-100 PSI, WITH ISOLATION 1/4" SS BALL VALVE
62	PRESSURE GAUGE, 0-25 PSI WITH ISOLATION 1/4" SS BALL VALVE
63	LOUVERED VENT W/ BACKDRAFT DAMPER McMASTER CARR #2039 KI, W/ EPOXY GREY PAINT
64	19 1/2" 430 CFM EXHAUST FAN WITH BACKDRAFT DAMPER
65	1 5/8" UNISTRUT, GALVANIZED STEEL, WITH PIPE SUPPORTS
66	1 5/8" UNISTRUT, STAINLESS STEEL, WITH PIPE SUPPORTS
67	8" x 6" REDUCER, FL x FL D.I., WP 250 PSI

- NOTES:
1. POSITION PRESSURE GAUGES SUCH THAT VIEW IS NOT OBSCURED BY OTHER EQUIPMENT IN FRONT.
 2. CONTRACTOR RESPONSIBLE TO PROVIDE ALL FITTINGS NECESSARY (SUCH AS BUSHINGS, FLANGES, ADAPTERS, NIPPLES, ETC.), WHETHER EXPLICITLY SHOWN OR NOT, TO COMPLETE THE INSTALLATION AS INDICATED.
 3. ALL 1" AND SMALLER PIPE TO BE SECURED WITH PIPE CLAMPS AND 1 5/8" UNISTRUTS MOUNTED TO THE WALL. ALL UNISTRUTS ATTACHED TO WALL SHALL BE IN VERTICAL POSITION. SOME PIPE SUPPORTS NOT SHOWN FOR CLARITY.
 4. 6" MINIMUM SPACING BETWEEN SCHED 80 PVC GLUED FITTINGS, UNLESS UNION IS PRESENT.
 5. ALL BOLTS, NUTS AND WASHERS IN CHEMICAL ROOM SHALL BE 316 SS.
 6. ALL VALVES WHICH MAY DISCHARGE WATER (CONTROL VALVE AND PRESSURE RELEASE VALVE) SHALL HAVE 1/2" GI DISCHARGE PIPE FROM VALVE OUTLET TO FLOOR DRAIN. DISCHARGE PIPING SHALL BE ROUTED ALONG WALL TO AVOID BLOCKING ACCESS TO OTHER COMPONENTS AND SHALL BE ATTACHED TO WALL WITH PIPE CLAMPS AND 1 5/8" UNISTRUTS FOR SUPPORT. PAINT GI PIPE BLUE. DISCHARGE PIPING NOT SHOWN FOR CLARITY.
 7. ALL MATERIALS SHALL BE RATED TO AT LEAST 125 psi, UNLESS OTHERWISE NOTED.
 8. ALL FLANGES SHALL BE ANSI CLASS 150 (STEEL) OR ANSI CLASS 125 (IRON).
 9. ALL BURIED PIPE WITHIN 5 FT OF BUILDING SHALL BE DUCTILE IRON, 350 psi WP, SOLID PIPE PIECES ONLY. NO DUCTILE IRON PIPE JOINTS ALLOWED.
 10. BURIED DUCTILE IRON PIPE FOR DRAINS AND PIPE PENETRATIONS SHALL BE AWWA C-209 COLD-APPLIED TAPE-COATED PER SPECIFICATIONS ABOVE THE BURIED ELL. ALL OTHER BURIED DUCTILE IRON PIPE AND FITTINGS SHALL BE ENCASED IN TWO LAYERS OF POLYETHYLENE, PER SPECIFICATIONS. ALL DUCTILE IRON PIPE AND FITTINGS SHALL BE TWO-PART EPOXY-COATED, PER SPECIFICATIONS.
 11. ALL STEEL COMPONENTS IN THE CHEMICAL ROOM SHALL BE SS 316, UNLESS OTHERWISE NOTED.
 12. ALL STAINLESS STEEL PIPE AND FITTINGS SHALL HAVE A WORKING PRESSURE OF AT LEAST 350 psi, UNLESS OTHERWISE NOTED.

Revision	Date	Description	By	CHK'd

SMA
Engineering & Environmental Surveying

SOUDER, MILLER & ASSOCIATES
5454 VENCE AVENUE NE, SUITE D
ALBUQUERQUE, NM 87113
Phone (505) 299-0942 Toll-Free (877) 299-0942 Fax (505) 293-3430
www.soudermiller.com

Serving the Southwest & Rocky Mountains
Albuquerque, Carlsbad, Hobbs, Farmington, Las Cruces, Roswell, Santa Fe, NM
Cortez, Grand Junction, CO - Safford, AZ - Mohave, UT - El Paso, TX

CLIENT: The Navajo Nation
TOWN: Reach 26.3 To Turreon, NM

**CHLORINATION SYSTEM
DETAILS (1 of 2)**

**NAVAJO GALLUP WATER SUPPLY
PROJECT - REACH 26.3**

SANDOVAL & MCKINLEY COUNTIES, NEW MEXICO

Designed TTT	Drawn AAV	Checked AGR
-----------------	--------------	----------------

90% REVIEW
DRAFT



PRELIMINARY
NOT FOR CONSTRUCTION

THIS DRAWING IS INCOMPLETE AND NOT TO BE USED FOR CONSTRUCTION UNLESS IT IS STAMPED, SIGNED AND DATED.

NOTICE OF EXTENDED PAYMENT PROVISION:
THIS CONTRACT ALLOWS THE OWNER TO MAKE PAYMENT WITHIN 45 DAYS AFTER SUBMISSION OF AN UNDISPUTED REQUEST FOR PAYMENT.

811 Know what's below. Call before you dig.

Date:	September 24, 2018
Scale:	Horiz: AS SHOWN Vert: N/A
Project No:	6921307
Sheet:	DT-23

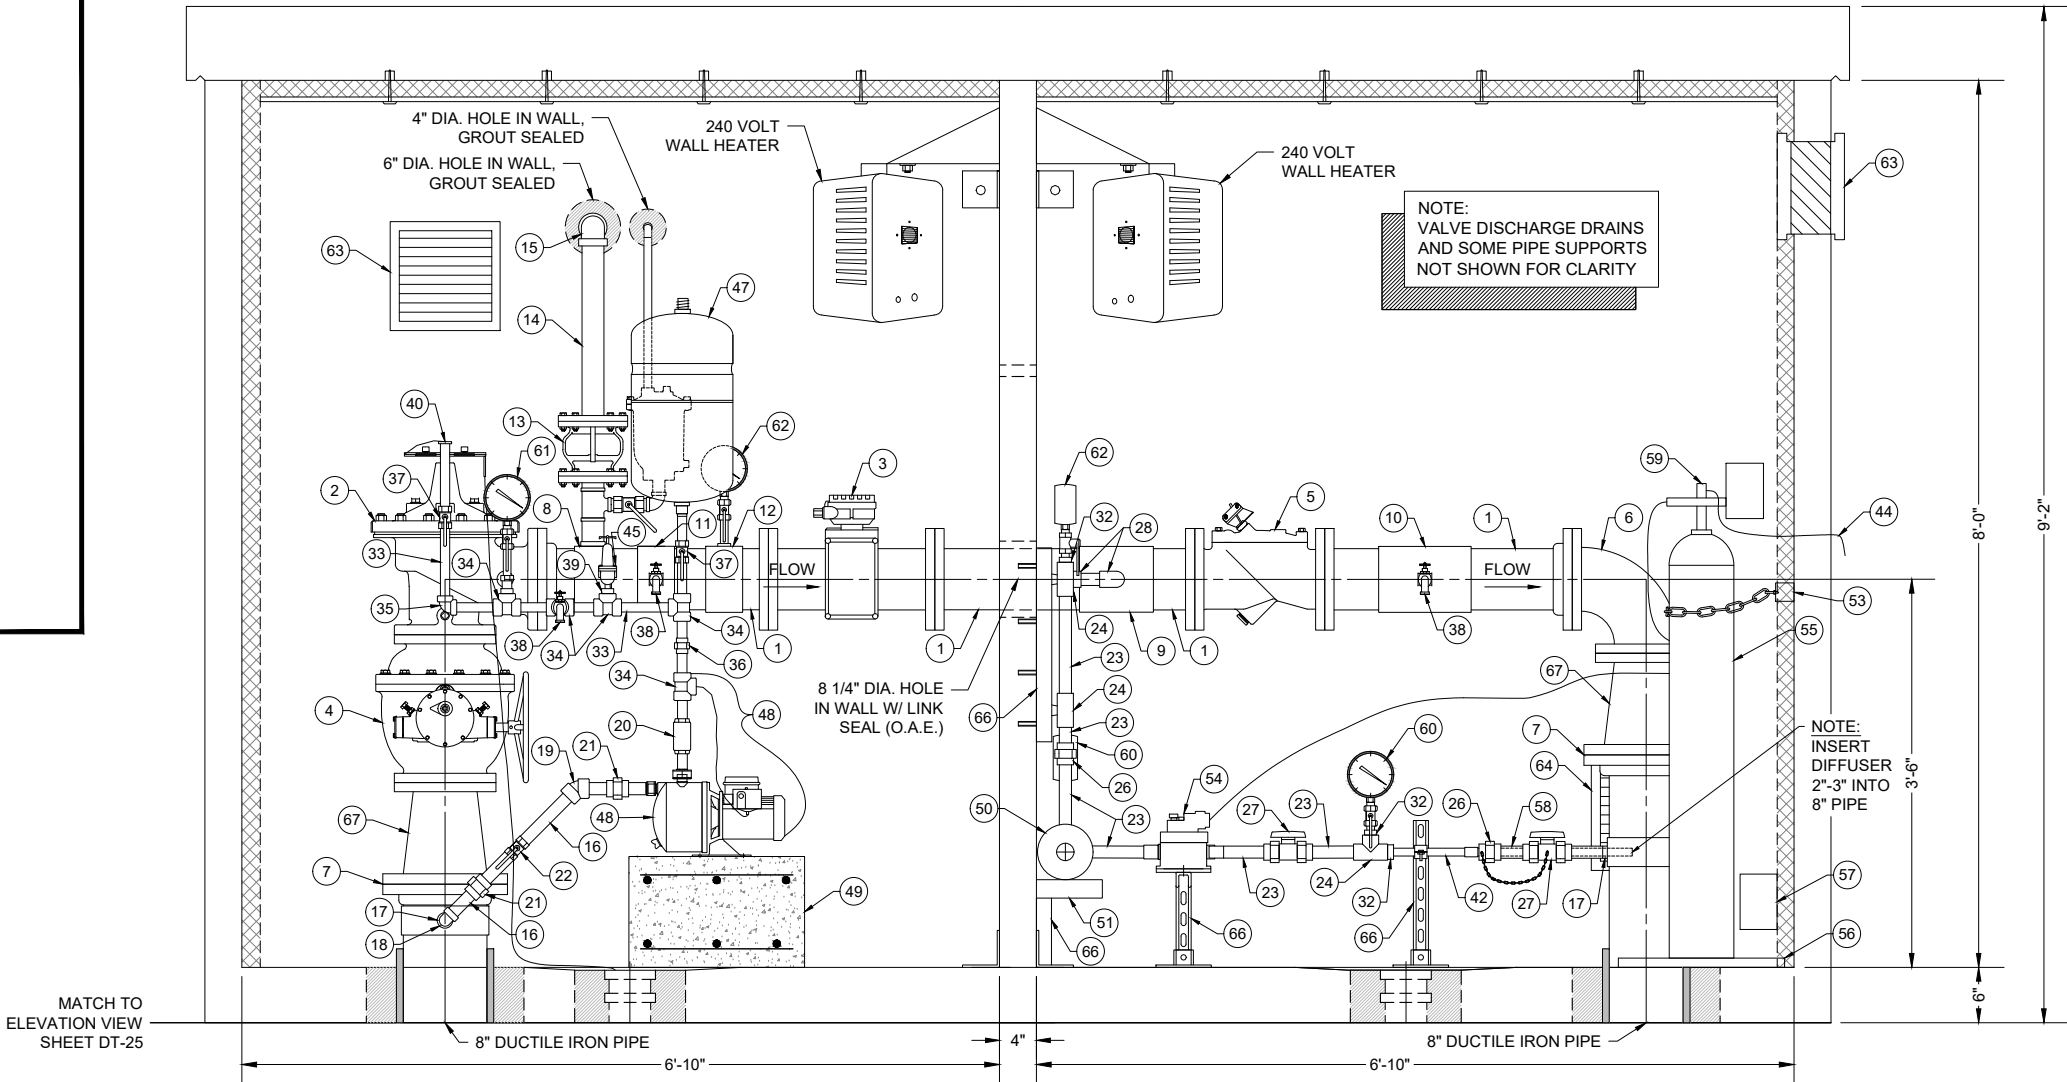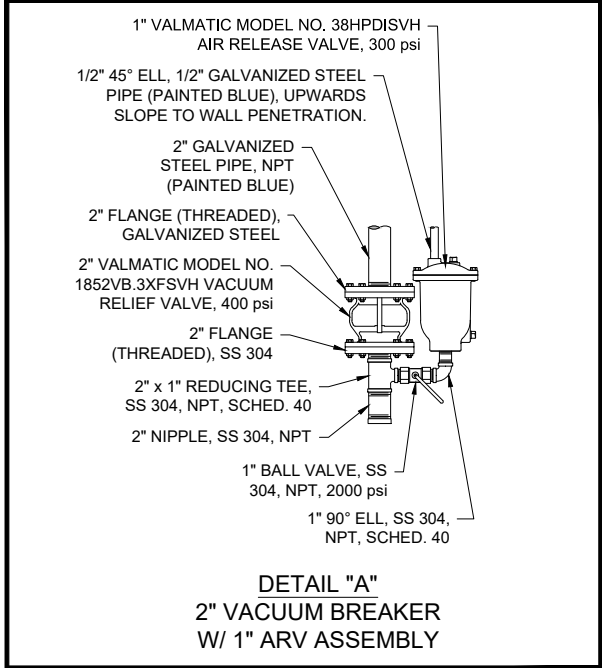

ELEVATION VIEW SECTION B-B
REACH 26.3 TANK CONTROL ROOM CHLORINATION
SYSTEM DETAIL

ELEVATION VIEW SECTION B-B
REACH 26.3 TANK CHEMICAL ROOM CHLORINATION
SYSTEM DETAIL

1	6" DUCTILE IRON PIPE
2	6" FLANGED FULL-PORT ELECTRONIC FLOW CONTROL VALVE, CLA-VAL 131A-57 FHBYCSKCKOP-X105LCW-N (0-160 PSI INLET/OUTLET GAUGES) W/ CLA-VAL VC-22D CONTROLLER
3	6" FLANGED ELECTRONIC FLOW METER, ELSTER EVOQ4, MAINTAIN STRAIGHT PIPE >30" IN FRONT AND >12" BEHIND CENTER OF METER.
4	6" BALL VALVE, FL x FL WITH GEARED ACTUATOR. DI WITH FLANGE ISOLATION KIT.
5	4" CHECK VALVE, SURGE BUSTER SERIES 7200 (O.A.E.)
6	6" 90° FL x FL ELBOW, DI
7	8" FLANGE ISOLATION KIT
8	6" x 2" TAPPING SADDLE, DI
9	6" x 1" TAPPING SADDLE, SS 304
10	6" x 3/4" TAPPING SADDLE, SS 304
11	6" x 3/4" TAPPING SADDLE, DI
12	6" x 1/4" TAPPING SADDLE, DI
13	2" VACUUM BREAKER WITH 1" ARV ASSEMBLY, SEE DETAIL "A" (SHT. DT-24). VENT VACUUM BREAKER AND ARV OUTSIDE BUILDING.
14	2" GALVANIZED STEEL PIPE, NPT
15	2" 90° ELBOW, GALVANIZED STEEL
16	1" GALVANIZED STEEL PIPE, NPT
17	8" x 1" TAPPING SADDLE, SS 316
18	1" 90° ELBOW, GALVANIZED STEEL
19	1" 45° ELBOW, GALVANIZED STEEL
20	1" CHECK VALVE, GALVANIZED STEEL
21	1" UNION, GALVANIZED STEEL
22	1" BALL VALVE, STAINLESS STEEL
23	1" PVC SCHED 80 PIPE
24	1" TEE, PVC SCHED 80
25	1" TRUE UNION CHECK VALVE, PVC SCHED 80
26	1" UNION, PVC SCHED 80

27	1" TRUE UNION BALL VALVE, PVC SCHED 80
28	1" 90° ELBOW, PVC SCHED 80
29	1" Y-STRAINER, PVC SCHED 80
30	NOT USED
31	1" x 1/2" REDUCER, PVC SCHED 80
32	1" x 1/2" PVC BUSHING
33	3/4" GALVANIZED STEEL PIPE, NPT
34	3/4" TEE, GALVANIZED STEEL
35	3/4" 90° ELBOW, GALVANIZED STEEL
36	3/4" UNION, GALVANIZED STEEL
37	3/4" BALL VALVE, STAINLESS STEEL
38	3/4" HOSE BIB WITH VACUUM BREAKER
39	3/4" x 1/2" GALVANIZED STEEL BUSHING
40	3/4" GALVANIZED x 3/8" COPPER BUSHING, WITH 3/8" COPPER TUBING TO CONTROL VALVE PILOT TUBING
41	1/2" 90° ELL & 1/2" GALVANIZED STEEL PIPE (PAINTED BLUE) WITH DOWNSPOUT
42	1/2" PVC SCHED 80 PIPE
43	1/2" UNION, PVC SCHED 80
44	1/2" PE VENT TUBING (WALL PENETRATION MUST BE BELOW REGULATORS)
45	1/2" PRESSURE RELIEF VALVE, WATTS BP 30 (O.A.E.) PRESSURE SET TO 90 PSI
46	3/8" PE VACUUM TUBING
47	7.6 GALLON PRESSURE TANK, WELL-X-TROL WX-103 (O.A.E.), INSTALL PIPE CLAMPS/SUPPORT UNDER TANK AND ANCHOR TO WALL
48	BOOSTER PUMP WITH INTEGRATED PRESSURE SWITCH (30-50 psi) DISCHARGE PRESSURE GAUGE AND DISCHARGE CHECK VALVE, 1" NPT INLET, 3/4" NPT OUTLET, 1/4" 100 PSI PE TUBING, TP PUMP MODEL #TPA-CM1-4-AUTO, 232 PSI
49	CONCRETE PEDESTAL FOR BOOSTER PUMP, 19"L x 11"W x 12"H, (OR PER PUMP DIMENSIONS) 4000 PSI CONCRETE W/ #4 REBAR / ANCHOR BOLTS
50	BOOSTER PUMP, FRANKLIN BT4 5JBT03S4 (O.A.E.)

51	SS UNISTRUT PEDESTAL FOR CHLORINATION PUMP. DIMENSIONS TO BE DETERMINED UPON APPROVAL OF PUMP SUBMITTAL BY CONTRACTOR. 9" ABOVE FLOOR.
52	CHLORINE GAS CONTROL PANEL, WALLACE & TIERNAN S10K (O.A.E.)
53	WALL MOUNTED CHAIN BRACKET, INSTALL 40" ABOVE FLOOR, WITH SAFETY CHAIN
54	CHLORINE INJECTOR, WALLACE & TIERNAN S10K W/ 99D THROAT/TAIL PIECE (O.A.E.) W/ PVC/TEFLON DIAPHRAM VALVE ON VACUUM LINE WITH PEDESTAL. SUPPORT WITH UNISTRUTS.
55	CHLORINE GAS CYLINDER, 150 LB (DO NOT INSTALL)
56	ELECTRONIC CHLORINE CYLINDER SCALE, FORCE FLOW GR150-2 W/ FORCE FLOW SOLO G2 DIGITAL INDICATOR (O.A.E.), BOLTED TO FLOOR
57	CHLORINE GAS DETECTOR SENSOR/TRANSMITTER, WALLACE & TIERNAN ACUTEC 35 W/ AUTOTEST (O.A.E.), MOUNTED 6" ABOVE FLOOR, LOCATION TBD BY ENGINEER IN FIELD. CHLORINE GAS DETECTOR RECEIVER, WALLACE & TIERNAN ACUTEC 35 (O.A.E.) LOCATION AS INDICATED IN ELECTRICAL PLANS OR TBD BY ENGINEER IN FIELD.
58	INSERTION DIFFUSER, MTE (O.A.E.)
59	VACUUM REGULATOR, WALLACE & TIERNAN 210S (O.A.E.)
60	PRESSURE GAUGE, 0-100 PSI, WITH PVC/TEFLON DIAPHRAM SEAL AND 1/2" BALL VALVE, STAINLESS STEEL
61	PRESSURE GAUGE, 0-100 PSI, WITH ISOLATION 1/4" SS BALL VALVE
62	PRESSURE GAUGE, 0-25 PSI WITH ISOLATION 1/4" SS BALL VALVE
63	LOUVERED VENT W/ BACKDRAFT DAMPER McMASTER CARR #2039 KI, W/ EPOXY GREY PAINT
64	19 1/2" 430 CFM EXHAUST FAN WITH BACKDRAFT DAMPER
65	1 5/8" UNISTRUT, GALVANIZED STEEL, WITH PIPE SUPPORTS
66	1 5/8" UNISTRUT, STAINLESS STEEL, WITH PIPE SUPPORTS
67	8" x 6" REDUCER, FL x FL D.I., WP 250 PSI

- NOTES:**
1. POSITION PRESSURE GAUGES SUCH THAT VIEW IS NOT OBSCURED BY OTHER EQUIPMENT IN FRONT.
 2. CONTRACTOR RESPONSIBLE TO PROVIDE ALL FITTINGS NECESSARY (SUCH AS BUSHINGS, FLANGES, ADAPTERS, NIPPLES, ETC.), WHETHER EXPLICITLY SHOWN OR NOT, TO COMPLETE THE INSTALLATION AS INDICATED.
 3. ALL 1" AND SMALLER PIPE TO BE SECURED WITH PIPE CLAMPS AND 1 5/8" UNISTRUTS MOUNTED TO THE WALL. ALL UNISTRUTS ATTACHED TO WALL SHALL BE IN VERTICAL POSITION. SOME PIPE SUPPORTS NOT SHOWN FOR CLARITY.
 4. 6" MINIMUM SPACING BETWEEN SCHED 80 PVC GLUED FITTINGS, UNLESS UNION IS PRESENT.
 5. ALL BOLTS, NUTS AND WASHERS IN CHEMICAL ROOM SHALL BE 316 SS.
 6. ALL VALVES WHICH MAY DISCHARGE WATER (CONTROL VALVE AND PRESSURE RELEASE VALVE) SHALL HAVE 1/2" GI DISCHARGE PIPE FROM VALVE OUTLET TO FLOOR DRAIN. DISCHARGE PIPING SHALL BE ROUTED ALONG WALL TO AVOID BLOCKING ACCESS TO OTHER COMPONENTS AND SHALL BE ATTACHED TO WALL WITH PIPE CLAMPS AND 1 5/8" UNISTRUTS FOR SUPPORT. PAINT GI PIPE BLUE. DISCHARGE PIPING NOT SHOWN FOR CLARITY.
 7. ALL MATERIALS SHALL BE RATED TO AT LEAST 125 psi, UNLESS OTHERWISE NOTED.
 8. ALL FLANGES SHALL BE ANSI CLASS 150 (STEEL) OR ANSI CLASS 125 (IRON).
 9. ALL BURIED PIPE WITHIN 5 FT OF BUILDING SHALL BE DUCTILE IRON, 350 psi WP, SOLID PIPE PIECES ONLY. NO DUCTILE IRON PIPE JOINTS ALLOWED.
 10. BURIED DUCTILE IRON PIPE FOR DRAINS AND PIPE PENETRATIONS SHALL BE AWWA C-209 COLD-APPLIED TAPE-COATED PER SPECIFICATIONS ABOVE THE BURIED ELL. ALL OTHER BURIED DUCTILE IRON PIPE AND FITTINGS SHALL BE ENCASED IN TWO LAYERS OF POLYETHYLENE, PER SPECIFICATIONS. ALL DUCTILE IRON PIPE AND FITTINGS SHALL BE TWO-PART EPOXY-COATED, PER SPECIFICATIONS.
 11. ALL STEEL COMPONENTS IN THE CHEMICAL ROOM SHALL BE SS 316, UNLESS OTHERWISE NOTED.
 12. ALL STAINLESS STEEL PIPE AND FITTINGS SHALL HAVE A WORKING PRESSURE OF AT LEAST 350 psi, UNLESS OTHERWISE NOTED.

Revision	Date	Description	By	Chk'd

SMA
Engineering & Environmental Surveying

SOUDER, MILLER & ASSOCIATES
5454 VENCE AVENUE NE, SUITE D
ALBUQUERQUE, NM 87113
Phone (505) 299-0942 Toll-Free (877) 299-0942 Fax (505) 293-3430
www.soudermiller.com

Serving the Southwest & Rocky Mountains
Albuquerque, Carlsbad, Hobbs, Farmington, Las Cruces, Roswell, Santa Fe, NM
Cortez, Grand Junction, CO - Safford, AZ - Moab, UT - El Paso, TX

CLIENT: The Navajo Nation
TOWN: Reach 26.3 To Turreon, NM

CHLORINATION SYSTEM
DETAILS (2 of 2)
NAVAJO GALLUP WATER SUPPLY
PROJECT - REACH 26.3
SANDOVAL & MCKINLEY COUNTIES, NEW MEXICO

Designed TTT	Drawn AAV	Checked AGR
-----------------	--------------	----------------

90% REVIEW
DRAFT

PRELIMINARY
NOT FOR CONSTRUCTION


THIS DRAWING IS INCOMPLETE AND NOT TO BE USED FOR CONSTRUCTION UNLESS IT IS STAMPED, SIGNED AND DATED.

NOTICE OF EXTENDED PAYMENT PROVISION:
THIS CONTRACT ALLOWS THE OWNER TO MAKE PAYMENT WITHIN 45 DAYS AFTER SUBMISSION OF AN UNDISPUTED REQUEST FOR PAYMENT.

811 Know what's below. Call before you dig.


Date: September 24, 2018
Scale: Horiz: AS SHOWN
Vert: N/A

Project No: 6921307
Sheet: DT-24

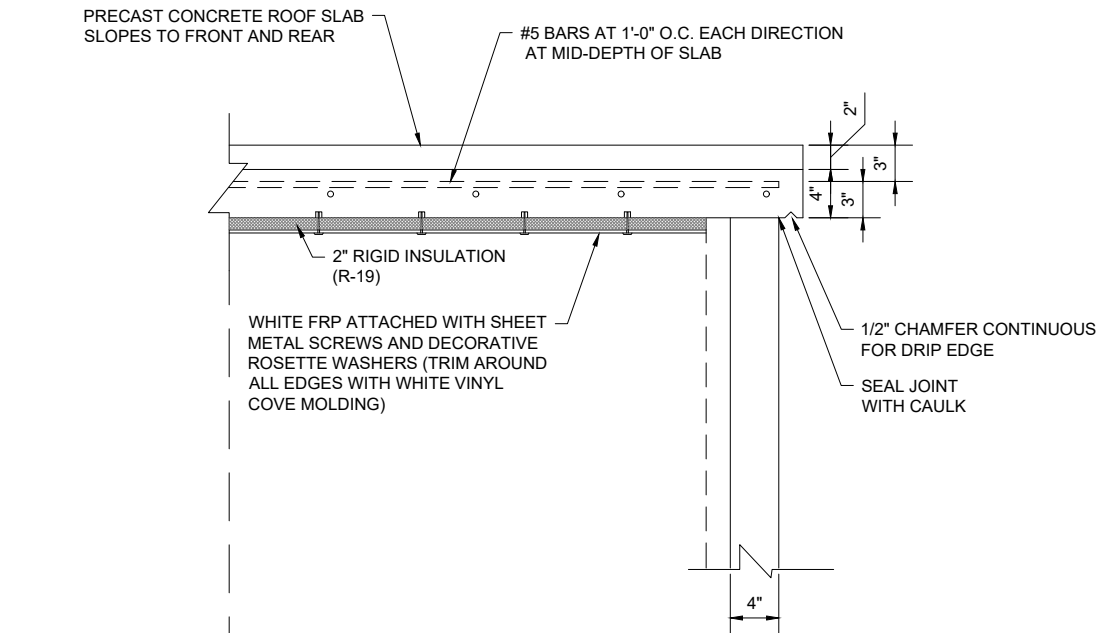


ROOM CENTERLINE

ROOF CONNECTION
DETAIL A
NOT TO SCALE

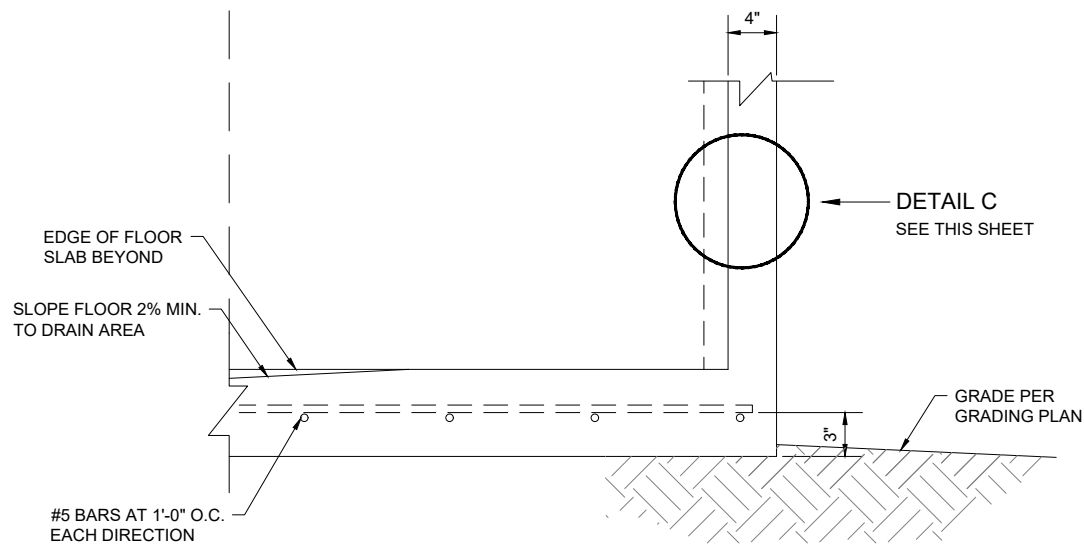


FLOOR CONNECTION
DETAIL B
NOT TO SCALE

NOTE: REBAR AT LIFT JOINTS ARE #6 REBAR, 12" SEPARATION, CENTERED ON LIFT POINTS. REBARS ARE CENTERED THE ENTIRE LENGTH AND WIDTH OF SLAB (BOTH DIRECTIONS OF EACH LIFT POINT)

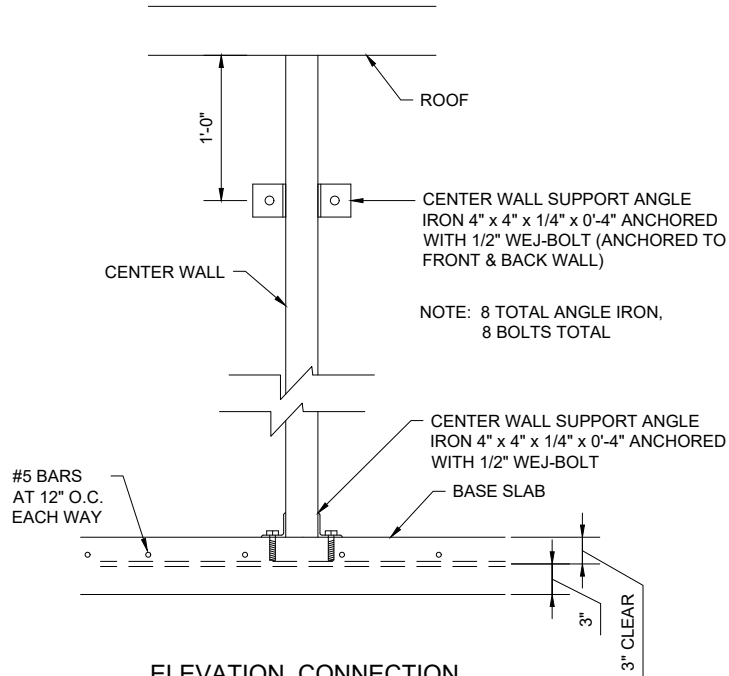


ELEVATION CONNECTION
ANGLE IRON
AT CENTER WALL
NOT TO SCALE

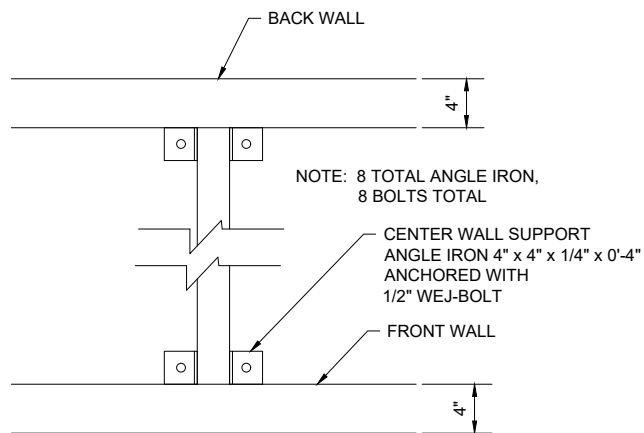

PLAN CONNECTION
ANGLE IRON
AT CENTER WALL
NOT TO SCALE

NOTE: 8 TOTAL ANGLE IRON, 8 BOLTS TOTAL

NOTE: DASHED LINE INDICATES 1/2" CHAMFER STRIP ON BOTTOM SIDE OF ROOF SLAB CONTINUOUS AROUND EDGE TO PROVIDE DRIP OF DRAINAGE FROM ROOF

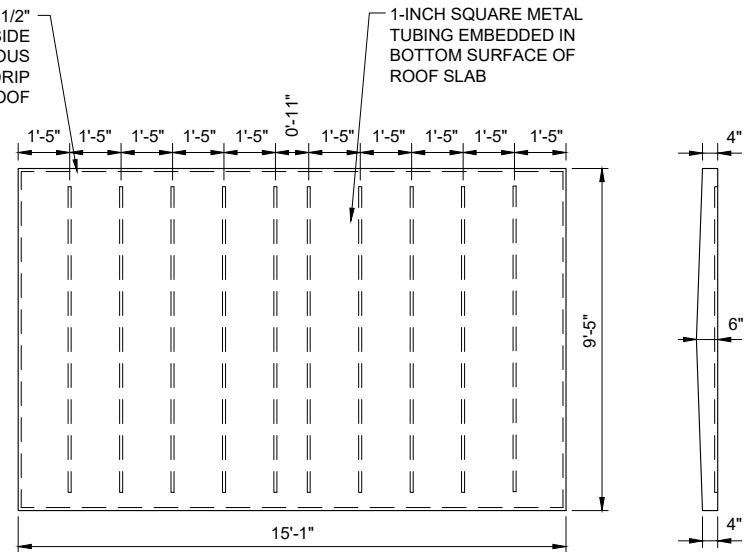


ROOF SLAB
NOT TO SCALE


1/8" WHITE FIBER REINFORCED PLASTIC (FRP) PANELS ATTACHED WITH WOOD SCREWS AND RECESSED WASHERS - TRIM AROUND ALL EDGES WITH WHITE VINYL COVE MOLDING.

1 1/2" FOAM POLYSTYRENE BOARD CLOSED CELL INSULATION R-VALUE = 7.5 PER INCH

2" x 2" REDWOOD STUD AT 2'-0" O.C.

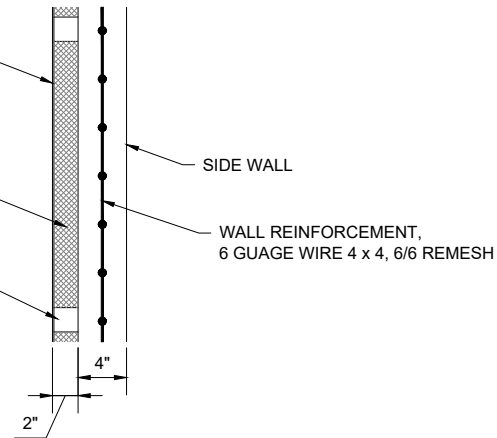

WALL SECTION
DETAIL C
NOT TO SCALE

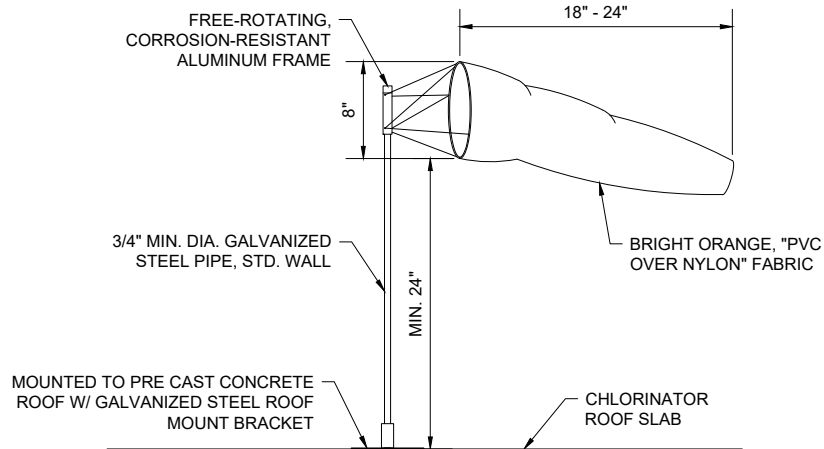

WIND SOCK DETAIL
NOT TO SCALE

Revision	Date	Description	By	Chk'd

SMA
Souder, Miller & Associates
5454 VANCE AVENUE NE, SUITE D
ALBUQUERQUE, NM 87113
Phone (505) 299-0942 Toll-Free (877) 299-0942 Fax (505) 293-3430
www.soudermiller.com
Serving the Southwest & Rocky Mountains
Albuquerque, Carlsbad, Hobbs, Farmington, Las Cruces, Roswell, Santa Fe, NM
Cortez, Grand Junction, CO - Safford, AZ - Moab, UT - El Paso, TX
9/24/2018 5:14:59 PM

CLIENT: The Navajo Nation TOWN: Reach 26.3 To Turreon, NM
PRECAST 2-ROOM CHLORINATION
BUILDING DETAILS
NAVAJO GALLUP WATER SUPPLY
PROJECT - REACH 26.3
SANDOVAL & MCKINLEY COUNTIES, NEW MEXICO

Designed TTT	Drawn AAV	Checked AGR
-----------------	--------------	----------------

90% REVIEW
DRAFT
PRELIMINARY
NOT FOR CONSTRUCTION

THIS DRAWING IS INCOMPLETE AND NOT TO BE USED FOR CONSTRUCTION UNLESS IT IS STAMPED, SIGNED AND DATED

NOTICE OF EXTENDED PAYMENT PROVISION: THIS CONTRACT ALLOWS THE OWNER TO MAKE PAYMENT WITHIN 45 DAYS AFTER SUBMISSION OF AN UNDISPUTED REQUEST FOR PAYMENT.

811 Know what's below. Call before you dig.

Date: September 24, 2018

Scale: Horiz: AS SHOWN
Vert: N/A

Project No: 6921307

Sheet: **DT-26**






TYPICAL 12" RIP-RAP DETAIL
NOT TO SCALE



SECTION B-B

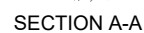

TYPICAL BURIED 12" RIP-RAP MATTRESS FOR WASH CROSSINGS

SMA
SODER, MILLER & ASSOCIATES
3454 VICTORIE AVENUE, SUITE D
ALBUQUERQUE, NM 87131
Phone (505) 269-0942 Toll-Free (877) 299-0942 Fax (505) 291-3430
www.soudermiller.com

**Engineers & Environmental
Surveying**

Serving the Southwest & Rocky Mountains
Albuquerque, Carlsbad, Hobbs, Kingman, Las Vegas, Phoenix, Santa Fe, N.M.
Cedar, Grand Rapids, CO, Salt Lake, AZ, Mesa, UT, Pahrump, NV

EROSION CONTROL DETAILS (1 of 3)
NAVAJO GALLUP WATER SUPPLY
PROJECT - REACH 26.3
SANDOVAL & MCKINLEY COUNTIES, NEW MEXICO

Designed TTT	Drawn AAV	Checked AGR
-----------------	--------------	----------------

5% REVIEW
DRAFT

PRELIMINARY
NOT FOR CONSTRUCTION

THIS DRAWING IS INCOMPLETE
AND NOT TO BE USED FOR
CONSTRUCTION UNLESS IT IS
STAMPED, SIGNED AND DATED

**NOTICE OF EXTENDED
PAYMENT PROVISION:**
THIS CONTRACT ALLOWS THE
OWNER TO MAKE PAYMENT
WITHIN 45 DAYS AFTER
SUBMISSION OF
AN UNDISPUTED REQUEST
FOR PAYMENT.




ate: September 24, 2018

cale: Horiz: NONE
Vert: N/A


Project No: 6921307


Sheet: DT-28

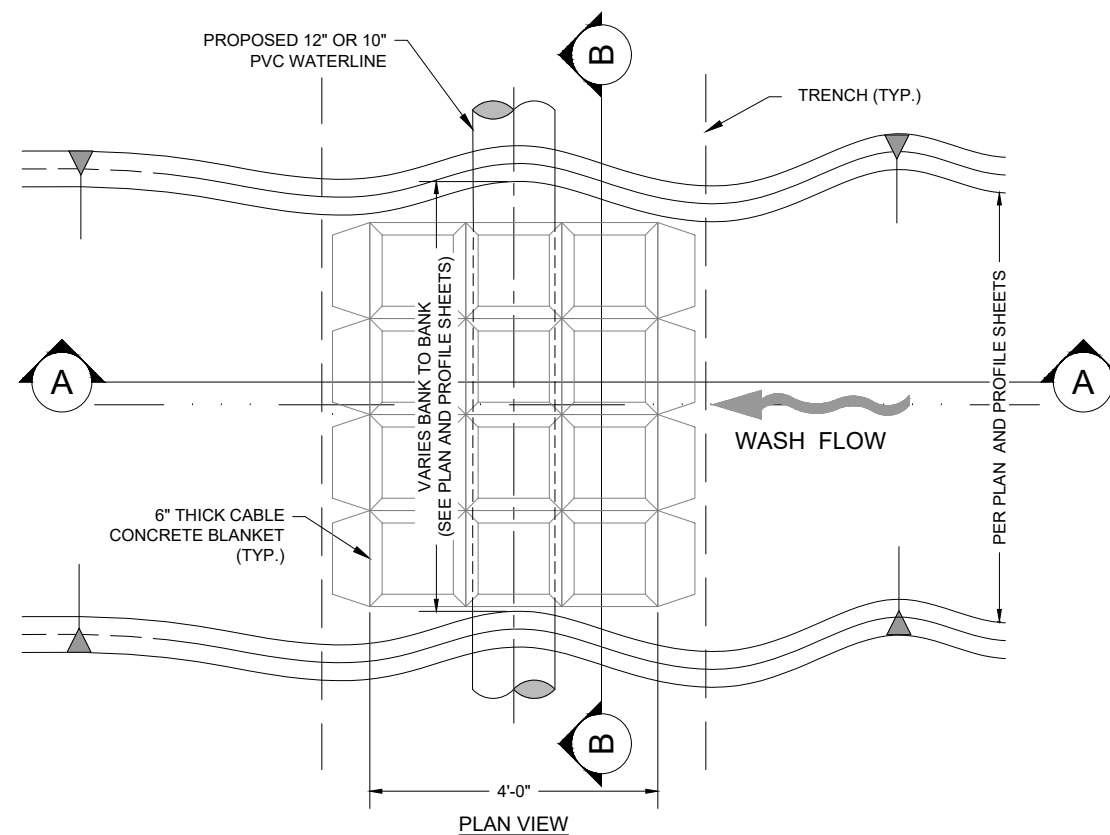


NOTE:

1. FOR CABLE CONCRETE BLANKETS IN NATURAL WATERWAYS (EXCEPT FLUSH VALVE OUTLETS), BLANKET SHALL BE BURIED AS SHOWN. COVER BLANKET WITH NATURAL SOIL AND REGRADE TO RESTORE WASH FLOWLINE TO NATURAL GRADE.
2. CABLE CONCRETE BLANKETS AT SITES, FLUSH VALVE OUTLETS AND CULVERT OUTLETS SHALL BE INSTALLED FLUSH WITH SURROUNDING FINISHED GRADE.
3. FINAL QUANTITIES, DIMENSIONS AND LOCATIONS TO BE DETERMINED IN FIELD BY ENGINEER.
4. FOR ALL WASH CROSSINGS, CULVERT OUTFALLS, AND FLUSH VALVE OUTLETS, EITHER RIP-RAP OR CABLE CONCRETE MAY BE USED AT CONTRACTOR'S OPTION.

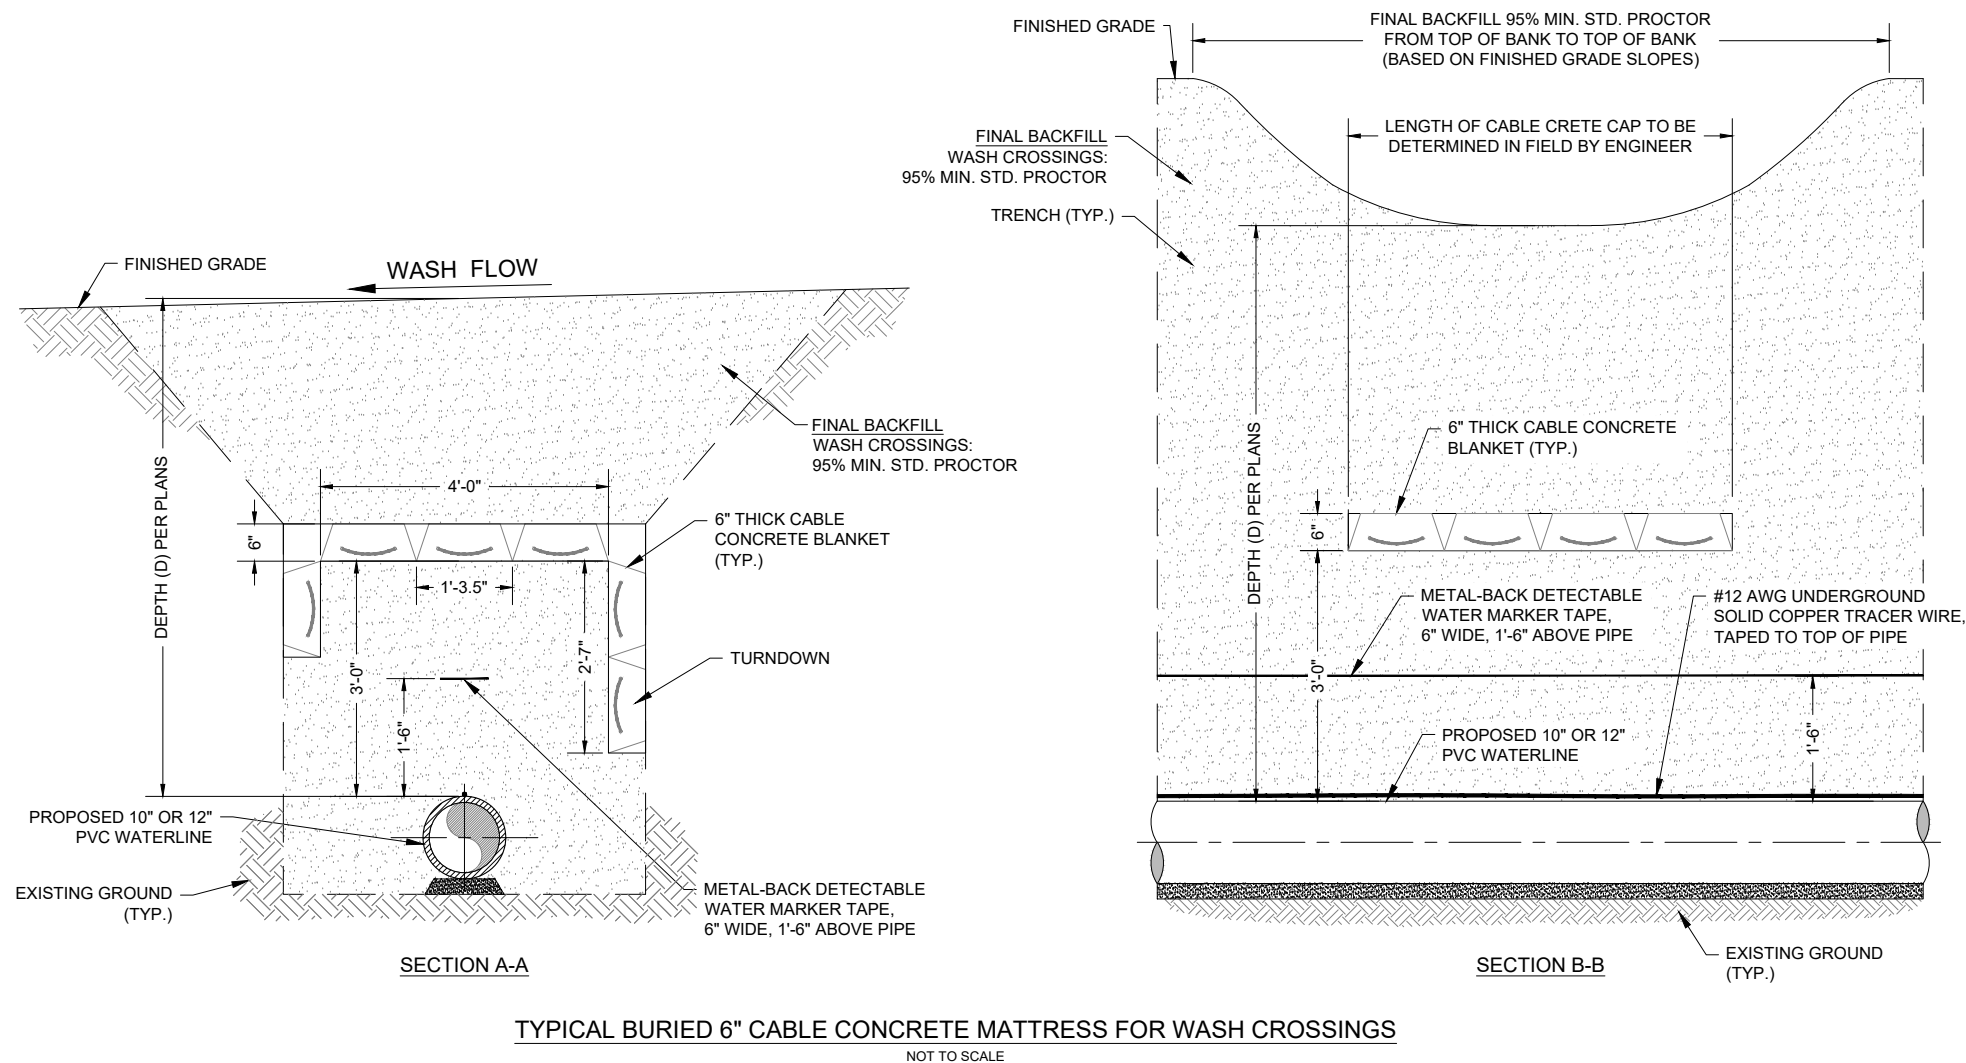


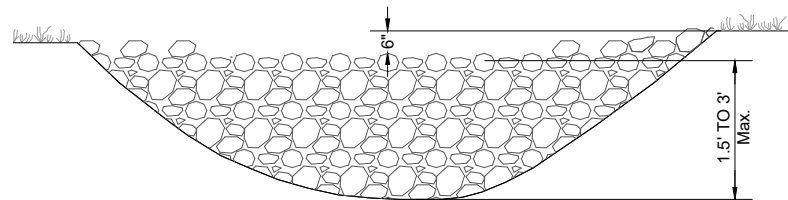

ELEVATION VIEW

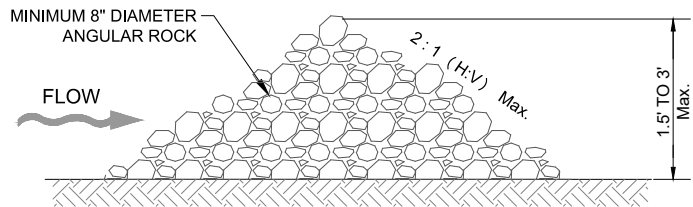


TYPICAL ROCK DAM SECTION

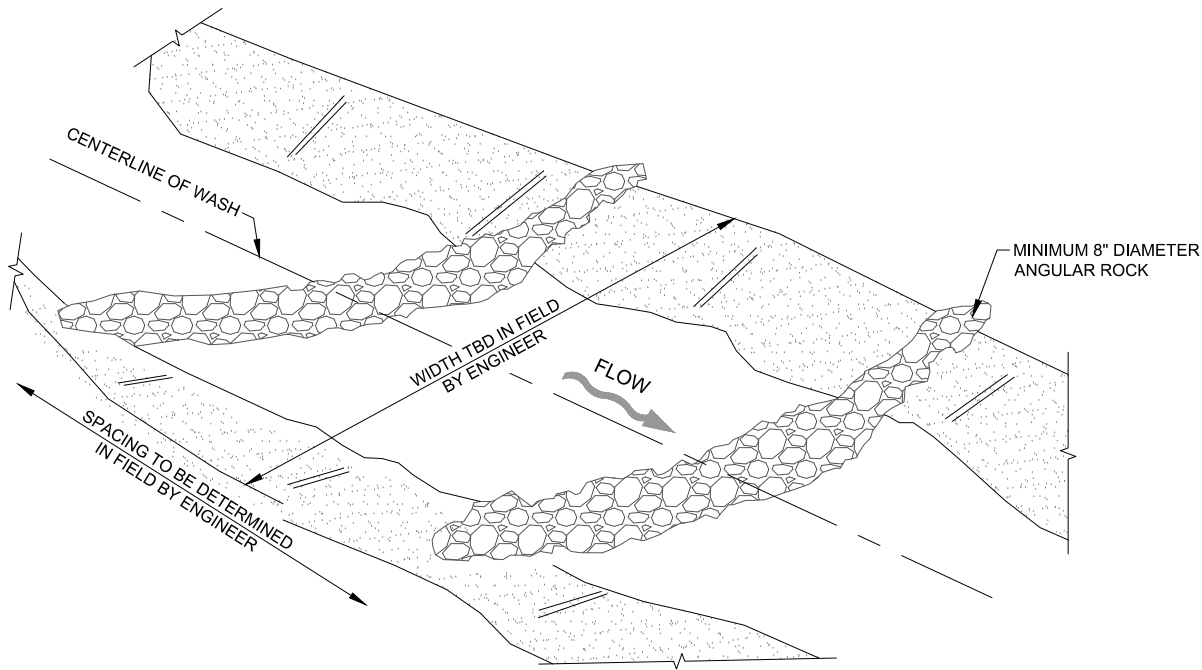


ISOMETRIC VIEW


ROCK CHECK DAM DETAIL
NOT TO SCALE

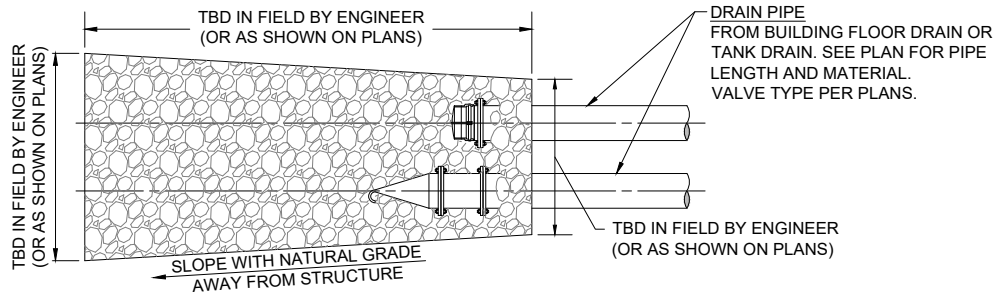

PLAN VIEW

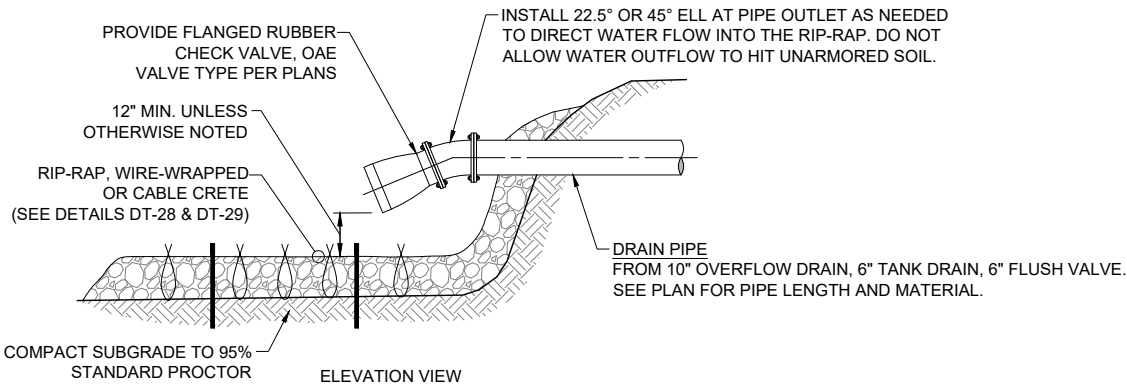


ELEVATION VIEW

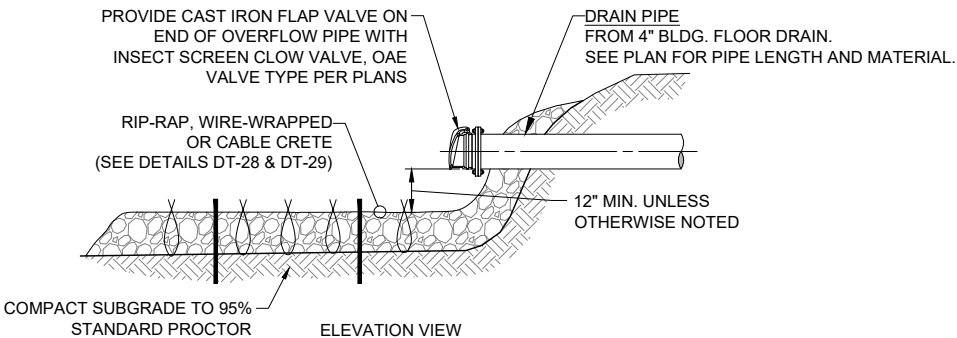


ELEVATION VIEW

TYPICAL SPLASH PAD DETAIL
NOT TO SCALE

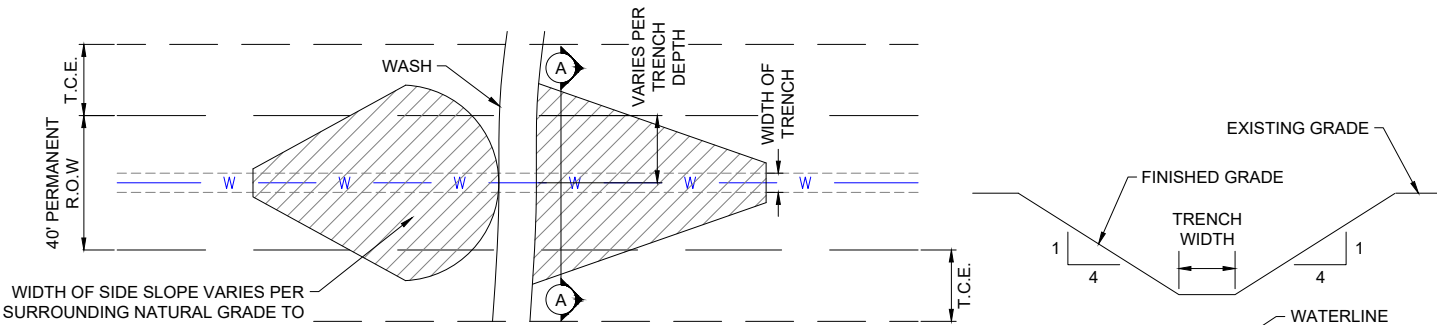

PLAN VIEW

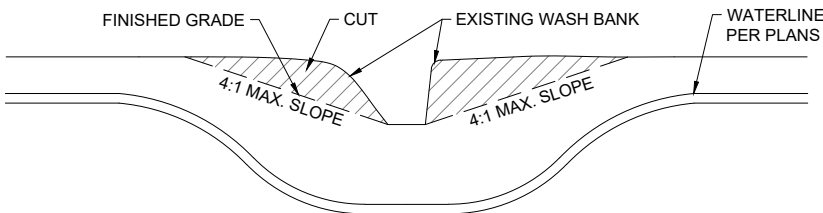


PROFILE VIEW

WASH CROSSING GRADING DETAIL
NOT TO SCALE

NOTE:
1. ALL GRADING MUST REMAIN WITHIN
TEMPORARY CONSTRUCTION EASEMENT.

Revision	Date	Description	By	Chk'd



SMA
Engineering & Surveying

SOUDER, MILLER & ASSOCIATES
5454 VENCE AVENUE NE, SUITE D
ALBUQUERQUE, NM 87113
Phone (505) 299-0942 Toll-Free (877) 299-0942 Fax (505) 293-3430
www.soudermiller.com
Serving the Southwest & Rocky Mountains
Albuquerque, Carlsbad, Hobbs, Farmington, Las Cruces, Roswell, Santa Fe, NM
Cortez, Grand Junction, CO - Safford, AZ - Moab, UT - El Paso, TX

CLIENT: The Navajo Nation TOWN: Reach 26.3 To Turren, NM
EROSION CONTROL DETAILS (3 of 3)
NAVAJO GALLUP WATER SUPPLY
PROJECT - REACH 26.3
SANDOVAL & MCKINLEY COUNTIES, NEW MEXICO

Designed	Drawn	Checked
JEG	AAV	AGR

90% REVIEW
DRAFT

PRELIMINARY
NOT FOR CONSTRUCTION

THIS DRAWING IS INCOMPLETE
AND NOT TO BE USED FOR
CONSTRUCTION UNLESS IT IS
STAMPED, SIGNED AND DATED

**NOTICE OF EXTENDED
PAYMENT PROVISION:**
THIS CONTRACT ALLOWS THE
OWNER TO MAKE PAYMENT
WITHIN 45 DAYS AFTER
SUBMISSION OF
AN UNDISPUTED REQUEST
FOR PAYMENT.


811 Know what's
below.
Call before
you dig.

Date: September 24, 2018

Scale: Horiz: NONE
Vert: N/A

Project No: 6921307

Sheet: **DT-30**

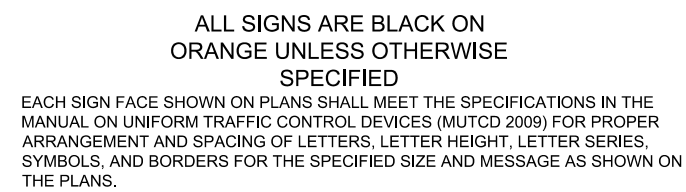

CLIENT: The Navajo Nation TOWN: Reach 26.3 To Torreon, NM

TRAFFIC CONTROL (PAVED ROAD)

NAVAJO GALLUP WATER SUPPLY

PROJECT - REACH 26.3


SANDOVAL & MCKINLEY COUNTIES, NEW MEXICO

90% REVIEW
DRAFT
PRELIMINARY
NOT FOR CONSTRUCTION

**NOTICE OF EXTENDED
PAYMENT PROVISION:**
THIS CONTRACT ALLOWS THE
OWNER TO MAKE PAYMENT
WITHIN 45 DAYS AFTER
SUBMISSION OF
AN UNDISPUTED REQUEST
FOR PAYMENT.



© Copyright 2018 Souder, Miller & Associates - All Rights Reserved

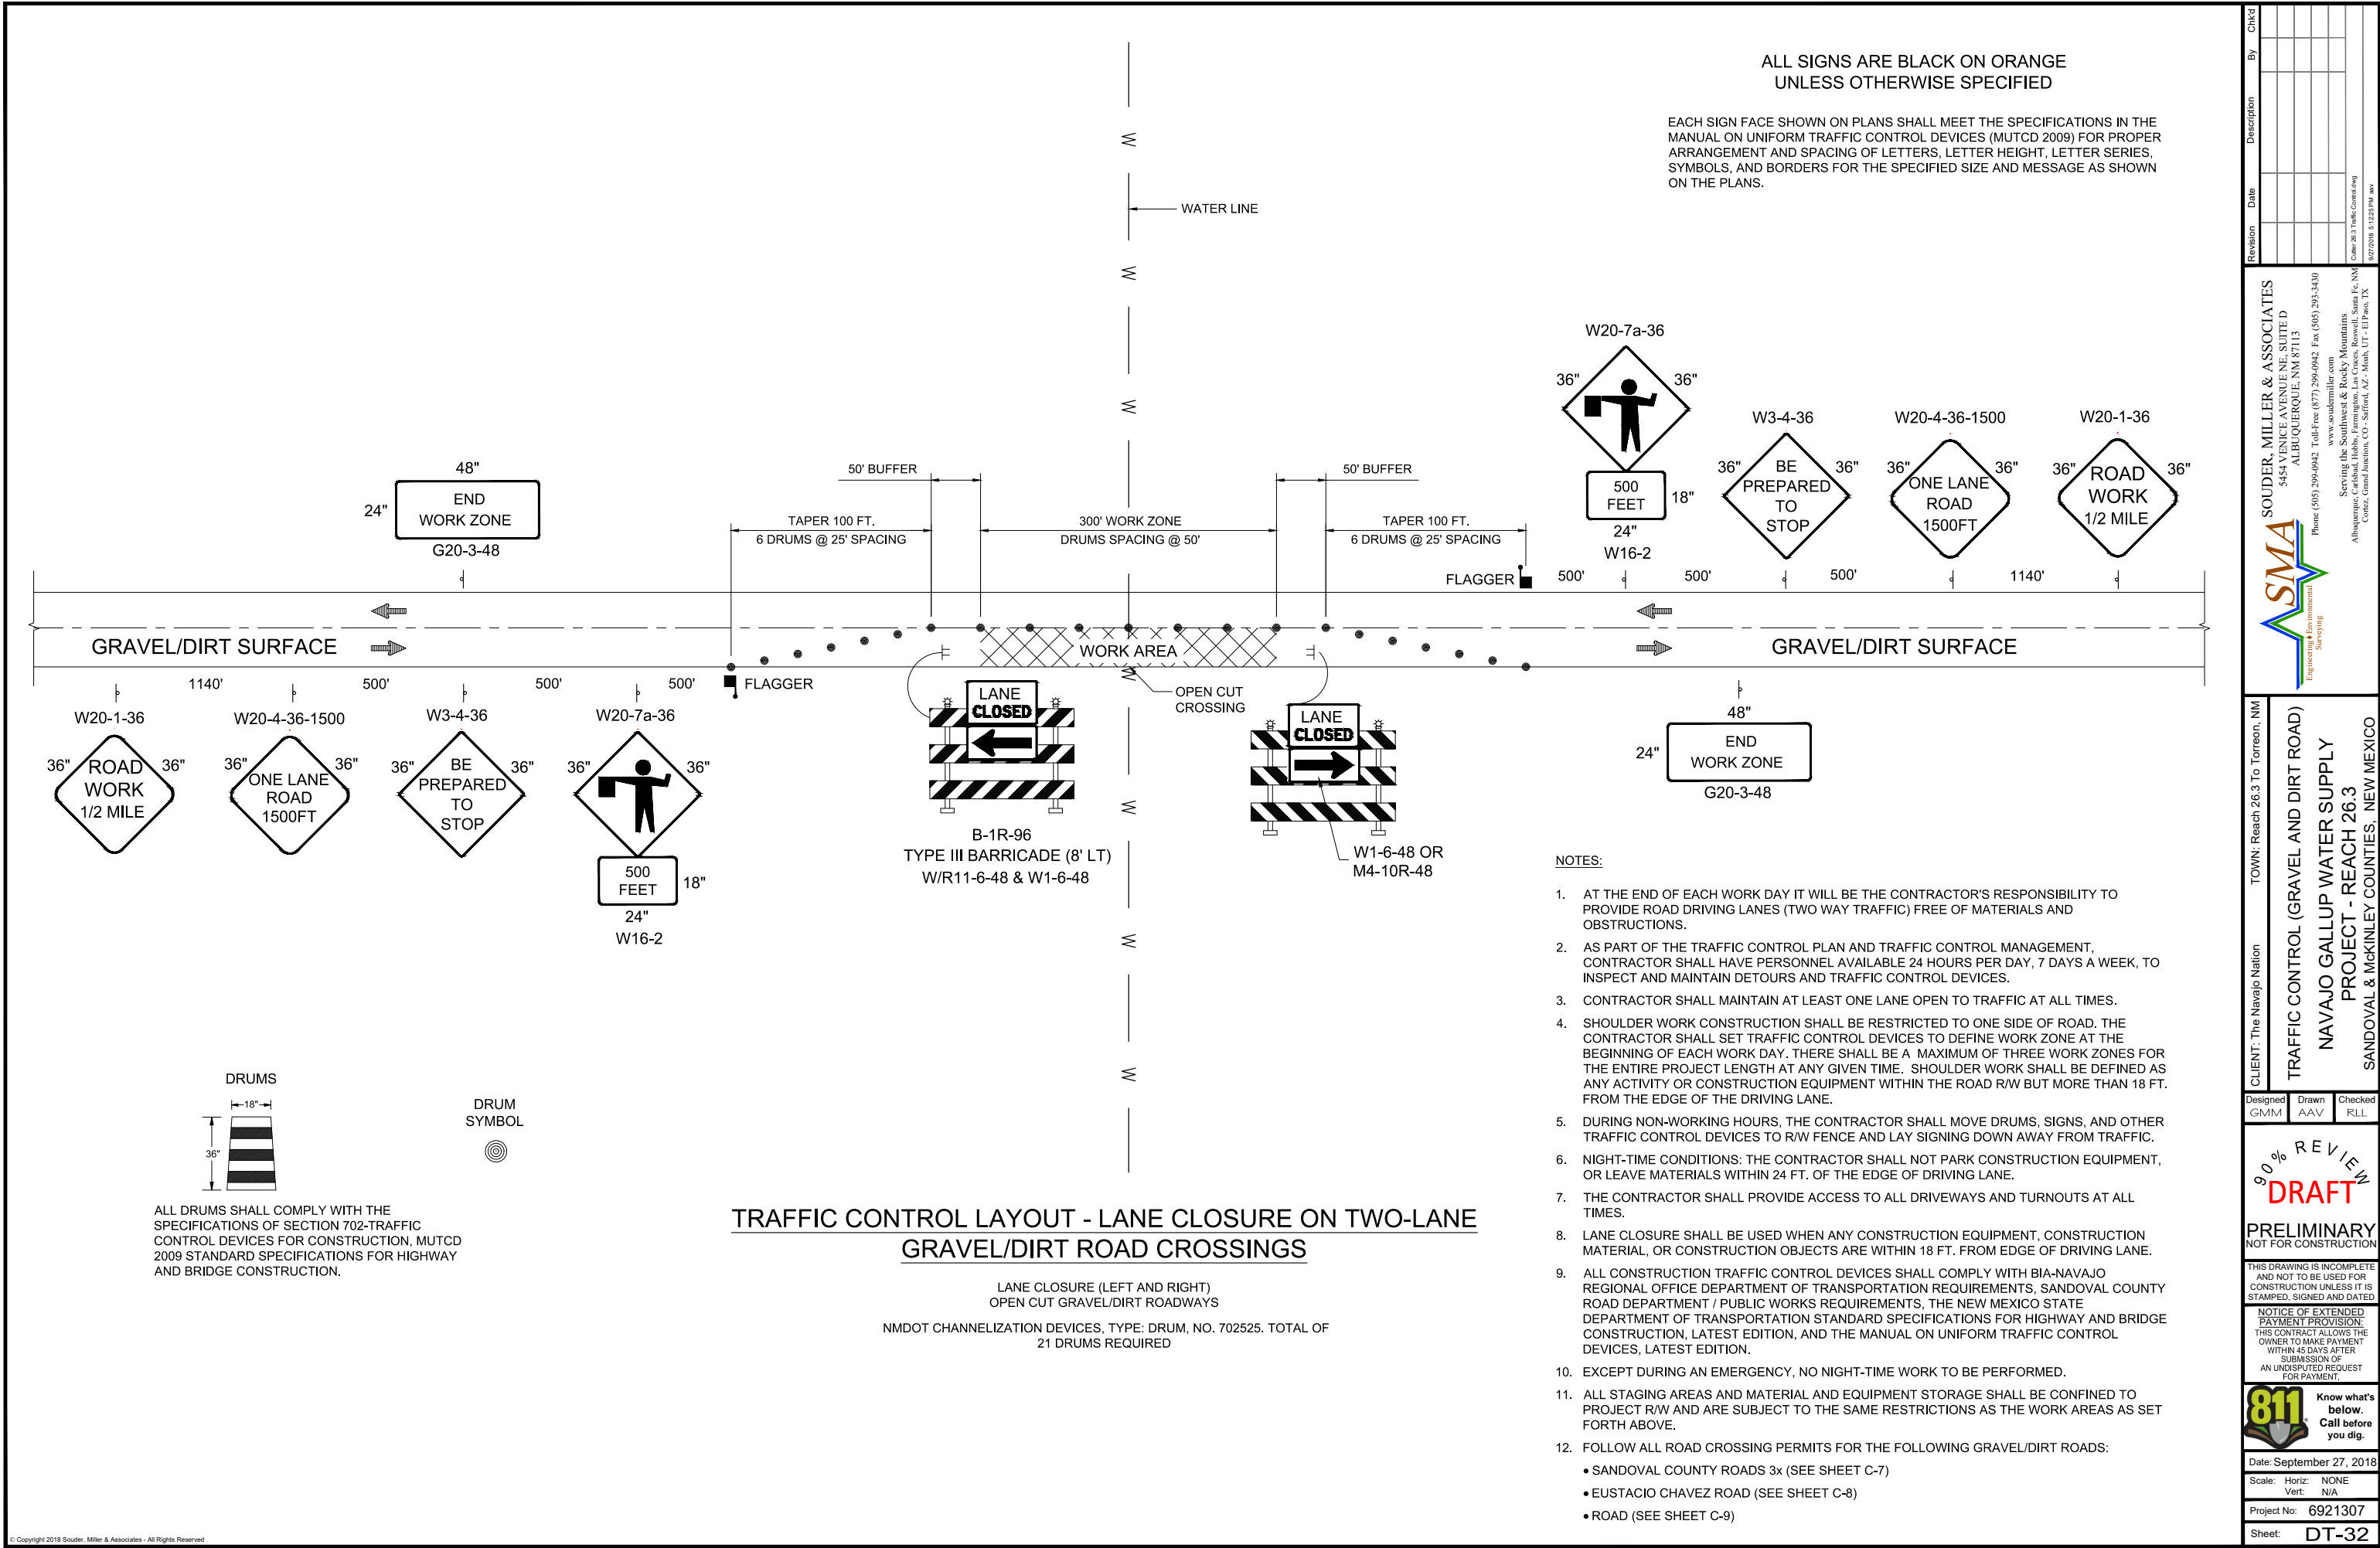

Revision	Date	Description	By	Check

SMA
Engineering & Environmental
Surveying

SOUDER, MILLER & ASSOCIATES
5454 VENCE AVENUE, SUITE D
ALBUQUERQUE, NM 87113
Phone (505) 299-0942 Toll-Free (877) 299-0942 Fax (505) 293-3430
www.soudermiller.com
Serving the Southwest & Rocky Mountains
Albuquerque, Carlsbad, Hobbs, Farmington, Las Cruces, Roswell, Santa Fe, NM
Cortez, Grand Junction, CO - Safford, AZ - Moab, UT - El Paso, TX

CLIENT: The Navajo Nation TOWN: Reach 26.3 To Turreon, NM

TRAFFIC CONTROL (GRAVEL AND DIRT ROAD)
NAVAJO GALLUP WATER SUPPLY
PROJECT - REACH 26.3
SANDOVAL & MCKINLEY COUNTIES, NEW MEXICO

Designed GMM	Drawn AAV	Checked RLL
-----------------	--------------	----------------

90% REVIEW
DRAFT

PRELIMINARY
NOT FOR CONSTRUCTION

THIS DRAWING IS INCOMPLETE
AND NOT TO BE USED FOR
CONSTRUCTION UNLESS IT IS
STAMPED, SIGNED AND DATED

NOTICE OF EXTENDED
PAYMENT PROVISION:
THIS CONTRACT ALLOWS THE
OWNER TO MAKE PAYMENT
WITHIN 45 DAYS AFTER
SUBMISSION OF
AN UNDISPUTED REQUEST
FOR PAYMENT.

811 Know what's
below.
Call before
you dig.

Date: September 27, 2018

Scale: Horiz: NONE
Vert: N/A

Project No: 6921307

Sheet: DT-32

ELECTRICAL SYMBOL LEGEND	
SYMBOL	DESCRIPTION
	WALL OUTLET AND SURFACE MOUNTED FIXTURE
	FLUORESCENT OUTLET AND FIXTURE
	SINGLE POLE SWITCH, FLUSH MOUNTED 48" A.F.F.
	DUPLEX CONVENIENCE OUTLET, 18" A.F.F.
	WEATHERPROOF DUPLEX CONVENIENCE OUTLET, 18" A.F.F.
	DUPLEX CONVENIENCE OUTLET, GROUND FAULT CIRCUIT INTERRUPTER, 18" A.F.F.
	JUNCTION BOX INSTALLED ABOVE LAY-IN CEILING WITH FLEXIBLE CONDUIT CONNECTION TO LAY-IN FIXTURES. MAXIMUM 4-0" LENGTH OF CONDUIT, WITH REQUIRED CONDUCTORS ALONG WITH GREEN GROUND CONDUCTOR
	JUNCTION BOX FLUSH IN WALL, HEIGHT AS INDICATED ON DRAWINGS, WITH CONNECTION TO EQUIPMENT
	CONCEALED BRANCH CIRCUIT WITH CONDUCTORS AS INDICATED. NEUTRAL, HOT, SWITCH LEG AND GROUND RESPECTIVELY
	BRANCH CIRCUIT OR CONDUIT INSTALLED UNDERGROUND OR UNDER FLOOR
	HOMERUN TO PANELBOARD WITH BRANCH CIRCUIT NUMBERS INDICATED
	SOLENOID VALVE
	LIMIT SWITCH
	PRESSURE TRANSMITTER
	FIRE ALARM SMOKE AND HEAT DETECTOR, PHOTOELECTRIC TYPE, 120V AUX CONTACTS
	MOTOR CONNECTION FOR FRACTIONAL HP MOTOR (1/3 HP OR LESS). PROVIDE THERMAL OVERLOAD SWITCH (WEATHERPROOF IF OUTSIDE) ADJACENT TO MOTOR UNLESS SWITCH IS SHOWN ELSEWHERE ON PLANS
	MOTOR CONNECTION FOR MOTOR WITH HP INDICATED
	DISCONNECT SWITCH, POLES AND RATING AS INDICATED OR AS REQUIRED, NEMA 3R IF INSTALLED OUTSIDE
	FUSED DISCONNECT SWITCH, FUSE, POLES AND RATING AS INDICATED OR AS REQUIRED, NEMA 3R IF INSTALLED OUTSIDE
	COMBINATION MAGNETIC MOTOR CONTROLLER/DISCONNECT SWITCH. SIZE, POLES, FUSES AND OVERLOADS PER MOTOR SERVED
	MAGNETIC MOTOR CONTROLLER, SIZE AND POLES PER MOTOR SERVED
	TRANSFORMER, DRY TYPE, SIZE AS INDICATED
	THERMOSTAT(M), 48" A.F.F.
	120V PANELBOARD, REFER TO PANEL SCHEDULE
	277V PANELBOARD, REFER TO PANEL SCHEDULE
	SPECIAL PURPOSE CABINET, AS INDICATED ON DRAWINGS
	INTRUSION ALARM DOOR CONTACT MAGNETIC
	NORMALLY OPEN CONTACT
	NORMALLY CLOSED CONTACT
	CONTACTOR
	MOTOR OVERLOADS
	RED PILOT LIGHT
	GREEN PILOT LIGHT
	TRANSFORMER
	RELAY
	SWITCH
	FUSE(S)
	CIRCUIT BREAKER
PLC	PROGRAMMABLE LOGIC CONTROLLER
RTU	REMOTE TERMINAL UNIT
	THERMOSTAT
WP	WEATHERPROOF (NEMA 3R)
NIC	NOT IN CONTRACT
NTS	NOT TO SCALE
A.F.F.	ABOVE FINISHED FLOOR
A.F.G.	ABOVE FINISHED GRADE
NOTES:	
• LIGHTING FIXTURES ARE OF TYPE AS INDICATED ON LIGHT FIXTURE SCHEDULE U.N.O.	
• MOUNTING HEIGHTS FOR DEVICES CALLED OUT AT 18\"/>	
• MOUNTING HEIGHTS FOR DEVICES CALLED OUT AT 48\"/>	
• ANY SPECIFIC DETAILS ABOVE (MOUNTING HEIGHTS, PART NUMBERS, CONNECTION METHODS, ETC.) MAY BE MODIFIED OR REPLACED BY INFORMATION ON PLANS, SCHEDULES, DETAILS, RISERS, ETC. DETAILS NOT SPECIFICALLY MODIFIED REMAIN AS GIVEN ABOVE.	

61) IF THERE IS A CONFLICT BETWEEN PLANS/SPECIFICATIONS AND MANUFACTURER'S RECOMMENDATIONS FOR ANY DEVICE, PART, OR MATERIAL USED IN THE PROJECT, THE CONTRACTOR SHALL IMMEDIATELY NOTIFY IN WRITING THE ENGINEER FOR CLARIFICATION.

G2) THE CONTRACTOR SHALL FAMILIARIZE HIM/HERSELF WITH THE PLANS, AND THE SITE CONDITIONS PRIOR TO BID OPENING AND SHALL IMMEDIATELY NOTIFY THE ENGINEER IN WRITING OF ANY AMBIGUITIES, CONTRADICTIONS OR IRREGULARITIES IN THE PLANS.

G3) IF, DURING BIDDING OR CONSTRUCTION, THE CONTRACTOR IS IN DOUBT AS TO THE TRUE MEANING OF ANY PART OF THE PLANS, SPECIFICATIONS, OR OTHER CONTRACT DOCUMENTS, OR DISCREPANCIES IN OR POSSIBLE OMISSIONS FROM THE DRAWINGS OR SPECIFICATIONS, THEY SHALL IMMEDIATELY NOTIFY THE ENGINEER IN WRITING AND REQUEST AN INTERPRETATION OF CORRECTION THEREOF. DURING THE BIDDING PROCESS AN ADDENDUM (IF NEEDED) WILL BE ISSUED.

GS.1) THE CONTRACT, IF AWARDED, WILL BE ON THE BASIS OF MATERIAL AND EQUIPMENT SPECIFIED OR DESCRIBED IN THE BIDDING DOCUMENTS WITHOUT CONSIDERATION OF POSSIBLE SUBSTITUTE OR "OR EQUAL" ITEMS. WHEREVER A BRAND NAME IS SPECIFIED OR DESCRIBED IN THE BIDDING DOCUMENTS A SUBSTITUTE OR "OR EQUAL" ITEM OF MATERIAL OR EQUIPMENT MAY BE FURNISHED OR USED BY CONTRACTOR IF ACCEPTABLE TO ENGINEER. APPLICATION FOR SUCH ACCEPTANCE WILL NOT BE CONSIDERED BY ENGINEER UNTIL AFTER THE EFFECTIVE DATE OF AGREEMENT. THE PROCEDURE FOR SUBMISSION OF ANY SUCH APPLICATION BY CONTRACTOR AND CONSIDERATION BY ENGINEER IS SET FORTH IN THE GENERAL CONDITIONS.

G4) THE CONTRACTOR IS RESPONSIBLE TO INSTALL ALL ITEMS DESCRIBED IN THESE PLANS IN A MANNER THAT PROTECTS THE EXISTING FACILITY. THE CONTRACTOR MUST CONTACT THE ENGINEER IMMEDIATELY IF HE IS UNABLE TO PERFORM THIS WORK WITHOUT DAMAGE TO THE EXISTING FACILITY. THE CONTRACTOR MUST FIELD VERIFY ALL EXISTING INFORMATION SHOWN ON THESE PLANS. DESIGN ELEMENTS OF THIS PROJECT WILL NOT CHANGE WITHOUT CHANGE ORDER UNLESS THE CONTRACTOR NOTIFIES THE ENGINEER IN A TIMELY MANNER REGARDING ITEMS DESCRIBED IN THIS NOTE. CHANGES IN ALIGNMENT CAUSED BY UNKNOWN OR UNANTICIPATED SITE CONDITIONS SHALL BE ACCOUNTED FOR BY THE APPROPRIATE UNIT PRICES, AS RECOMMENDED BY THE ENGINEER AND APPROVED BY THE OWNER.

G5) THE EXISTENCE, CONDITION AND LOCATION OF ANY UNDERGROUND UTILITIES OR STRUCTURES SHOWN IN THESE PLANS WAS OBTAINED BY A CAREFUL SEARCH OF AVAILABLE RECORDS. THE CONTRACTOR IS REQUIRED TO TAKE ALL PRECAUTIONARY MEASURES TO PROTECT THE UTILITIES SHOWN, AND ANY OTHER LINES OR STRUCTURES NOT SHOWN ON THESE PLANS, AND IS RESPONSIBLE FOR THEIR LOCATING, PROTECTION OF, OR ANY DAMAGE TO THESE LINES OR STRUCTURES. THIS DOES NOT RELIEVE THE CONTRACTOR FROM HIS RESPONSIBILITY TO NOTIFY ALL UTILITY COMPANIES AND OBTAIN LINE SPOTS.

G6) THE FOLLOWING IS A LIST OF POSSIBLE OBSTRUCTIONS AND SHALL NOT BE CONSIDERED A COMPLETE LIST OF POSSIBLE OBSTRUCTIONS: EXISTING UTILITIES, STRUCTURE, GEOTECHNICAL FEATURES, ALL CONDUIT, CABLES, PIPES, WATERLINES, SEWER LINES, GAS LINES, POWER LINES, TELEPHONE AND TELEGRAPH LINES, TREES, MONUMENTS, TRAFFIC CONTROL DEVICES AND OTHER STRUCTURES, BOTH BELOW AND ABOVE GROUND.

G7) CONTRACTOR SHALL BE HELD RESPONSIBLE FOR COSTS OF REPAIR OF ANY AND ALL DAMAGE TO ANY UTILITY (WHICH IS PREVIOUSLY KNOWN AND DISCLOSED TO HIM BY THE UTILITY OR SHOWN ON THESE PLANS) AS MAY BE CAUSED BY HIS OPERATIONS.

G8) FIVE (5) WORKING DAYS PRIOR TO ANY EXCAVATION, CONTRACTOR MUST CONTACT NEW MEXICO ONE-CALL SYSTEM, INC. (505) 260-1990, FOR LOCATION OF EXISTING UTILITIES.

G9) CONTRACTOR SHALL GIVE ALL PUBLIC AND PRIVATE UTILITY COMPANIES NOTICE AS SOON AS POSSIBLE, IN NO EVENT LESS THAN FORTY EIGHT (48) HOURS, FOR ANY WORK THAT IS UNDERSTOOD TO INTERFERE WITH THE SERVICE OF ANY EXISTING PUBLIC OR PRIVATE UTILITY. IF SUCH PUBLIC OR PRIVATE UTILITY DOES NOT COOPERATE FOR THE PROTECTION OF ITS SERVICES, CONTRACTOR SHALL NOTIFY ENGINEER.

§10) CONTRACTOR SHALL IMMEDIATELY REPORT ANY DAMAGES TO PUBLIC OR PRIVATE PROPERTY TO THE OWNER OF THE PROPERTY INVOLVED AND TO THE ENGINEER. CONTRACTOR SHALL REPAIR OR RESTORE AT HIS OWN EXPENSE ANY DAMAGE TO PUBLIC OR PRIVATE PROPERTY, FOR WHICH THEY ARE DIRECTLY OR INDIRECTLY RESPONSIBLE, TO A CONDITION EQUAL TO THAT EXISTING BEFORE DAMAGE. CONTRACTOR SHALL PROMPTLY NOTIFY HIS INSURANCE CARRIER OF SUCH DAMAGE. IF CONTRACTOR FAILS TO GIVE SUCH NOTICE TO HIS INSURANCE CARRIER OR REFUSES TO EFFECT SUCH REPAIRS OR RESTORATION UPON RECEIPT OF NOTICE, THE ENGINEER MAY CAUSE SUCH REPAIRS OR RESTORATION AND DEDUCT THE COST THEREOF FROM MONIES DUE, OR WHICH MAY BECOME DUE, TO THE CONTRACTOR.

G11) CONTRACTOR IS RESPONSIBLE FOR RECORDING EXISTING CONDITIONS IN ACCORDANCE WITH THE SUPPLEMENTARY CONDITIONS OF THE CONTRACT BEFORE CONSTRUCTION BEGINS. THE RECORD OF EXISTING CONDITIONS SHALL BE USED AS THE "EQUAL CONDITION BEFORE DAMAGE" IN THE EVENT OF DAMAGE TO PUBLIC OR PRIVATE PROPERTY. CONTRACTOR FAILURE TO RECORD EXISTING CONDITIONS WILL MAKE THE OWNERS CLAIM OF "EQUAL CONDITION BEFORE DAMAGE" THE STANDARD THE CONTRACTOR SHALL BE RESPONSIBLE FOR MEETING AND THE ENGINEER WILL BE IN THE POSITION OF NOT BEING ABLE TO SUPPORT THE CONTRACTOR IN THE MEDIATION OF ANY DISPUTE.

G12) UTILITY LOCATION CONTRACTOR IS RESPONSIBLE FOR FIELD VERIFICATION OF LOCATION OF ALL EXISTING UTILITIES.

G13) CONTRACTOR SHALL MAINTAIN ACCESS TO ALL FACILITIES ADJACENT TO THE CONSTRUCTION AREA.

G14) EPA STORM WATER DISCHARGE REGULATIONS. THE CONTRACTOR IS RESPONSIBLE FOR COMPLIANCE TO APPLICABLE PORTIONS OF THE EPA STORM WATER DISCHARGE REGULATIONS.

G15) DUST ABATEMENT. THE CONTRACTOR SHALL USE WATERING EQUIPMENT FOR DUST POLLUTION ABATEMENT AS REQUIRED OR AS DIRECTED BY THE ENGINEER. THE CONTRACTOR SHALL BE RESPONSIBLE FOR LOCATING AND SUPPLYING WATER. THIS WORK SHALL BE CONSIDERED INCIDENTAL TO CONSTRUCTION.

G16) SUBGRADE, ALL ELECTRICAL SUBGRADE AND TRENCH BACKFILL SHALL BE COMPACTED TO 95 % OF STANDARD PROCTOR. ALL SUBGRADE AND BACKFILL SHALL BE COMPACTED IN MAXIMUM 8" LOOSE LIFTS. MOISTURE CONTENT AT THE TIME OF COMPACTION SHALL NOT EXCEED OPTIMUM OR BE LESS THAN 5 PERCENTAGE POINTS BELOW OPTIMUM. DRIVEWAYS, APRONS, FILLETS, CURB AND GUTTER, AND OTHER CONCRETE PAVEMENT SHALL BE PLACED ON 6" OF COMPACTED SUBGRADE.

G17) RESTORE SURFACE AT TRENCH TO EXISTING CONDITIONS.

G18) CONTRACTOR SHALL KEEP THE OWNER AND THE ENGINEER UPDATED WEEKLY ON THE CONSTRUCTION SCHEDULE AND/OR PHASE SCHEDULE, AND PROGRESS TO DATE.

G19) DEBRIS GENERATED BY CONSTRUCTION ACTIVITIES SHALL BE DISPOSED OF AT A PERMITTED LANDFILL OR OTHER DULY CERTIFIED REFUSE FACILITY. THE DISPOSAL OF DEBRIS IS NOT A PAY ITEM.

G20) THE CONTRACTOR SHALL PROVIDE A RECORD SKETCH ON THESE PLANS FOR THE AS-CONSTRUCTED CONDITIONS.

G21) CONTRACTOR SHALL PHASE AND SCHEDULE WORK IN SUCH A WAY AS TO PROVIDE MINIMAL POWER OUTAGES AT THE FACILITY. A PROJECT SCHEDULE SHALL BE SUBMITTED TO THE OWNER FOR REVIEW PRIOR TO ISSUANCE OF NOTICE-TO-PROCEED. CHANGES IN SCHEDULE SHALL BE PRESENTED TO OWNER AND ENGINEER AT LEAST 7 DAYS PRIOR TO PROPOSED IMPLEMENTATION. THESE SCHEDULES, SCHEMATICS AND DIAGRAMS SHALL BE UPDATED WEEKLY AS THE WORK PROGRESSES. MOST CHANGE OVER SHALL BE DONE ON WEEKENDS OR AFTER HOURS.

G22) CONTRACTOR SHALL PROVIDE SUBMITTALS FOR ALL EQUIPMENT, MATERIALS, PROCESSES AND SCHEDULES AND AS REQUESTED BY ENGINEER.

G23) CONTRACTOR RESPONSIBLE FOR PROVIDING, INSTALLING, AND PROGRAMMING A COMPLETE AND WORKING SYSTEM.

G24) CONTRACTOR SHALL COORDINATE ALL PROGRAMMING REQUIREMENTS WITH OWNER AND SHALL REFER TO PLANS AND SPECIFICATIONS FOR SEQUENCE OF OPERATIONS. REFER TO CONTROL WIRING SCHEDULE, DISCRETE & ANALOG I/O LIST, CONTROL AND WIRING DIAGRAMS, AND SPECIFICATIONS FOR ADDITIONAL INFORMATION.

Revision	Date	Description	By	Chkd

16004 E001 Revise 26.3 - General Notes.dwg
 4/8/2018 8:16:25 AM Ttushile

SMA
Engineering • Environmental
Superfund

SOUDER, MILLER & ASSOCIATES
5454 VENICE AVENUE NE, SUITE D
ALBUQUERQUE, NM 87113

Phone (505) 299-0942 Toll-Free (877) 299-0942 Fax (505) 293-3430

www.soudermiller.com
Serving the Southwest & Rocky Mountains
Albuquerque, Carlsbad, Hobbs, Farmington, Las Cruces, Roswell, Santa Fe, NM
Cortez, Grand Junction, CO - Safford, AZ - Moab, UT - El Paso, TX

CLIENT: The Navajo Nation

REACH 26.3 - GENERAL NOTES

NAVAJO GALLUP WATER SUPPLY
PROJECT - REACH 26.3

SANDOVAL & MCKINLEY COUNTIES, NEW MEXICO

Designed TR	Drawn TRG	Checked DDR
----------------	--------------	----------------



15024

THIS DRAWING IS INCOMPLETE
AND NOT TO BE USED FOR
CONSTRUCTION UNLESS IT IS
STAMPED, SIGNED AND DATED

**NOTICE OF EXTENDED
PAYMENT PROVISION:**
THIS CONTRACT ALLOWS THE
OWNER TO MAKE PAYMENT
WITHIN 45 DAYS AFTER
SUBMISSION OF
AN UNDISPUTED REQUEST
FOR PAYMENT.




**Know what's
below.
Call before
you dig.**

Date: March 14, 2018

Scale:	Horiz:	N/A
	Vert:	N/A

Project No: 6921307

Sheet: E001

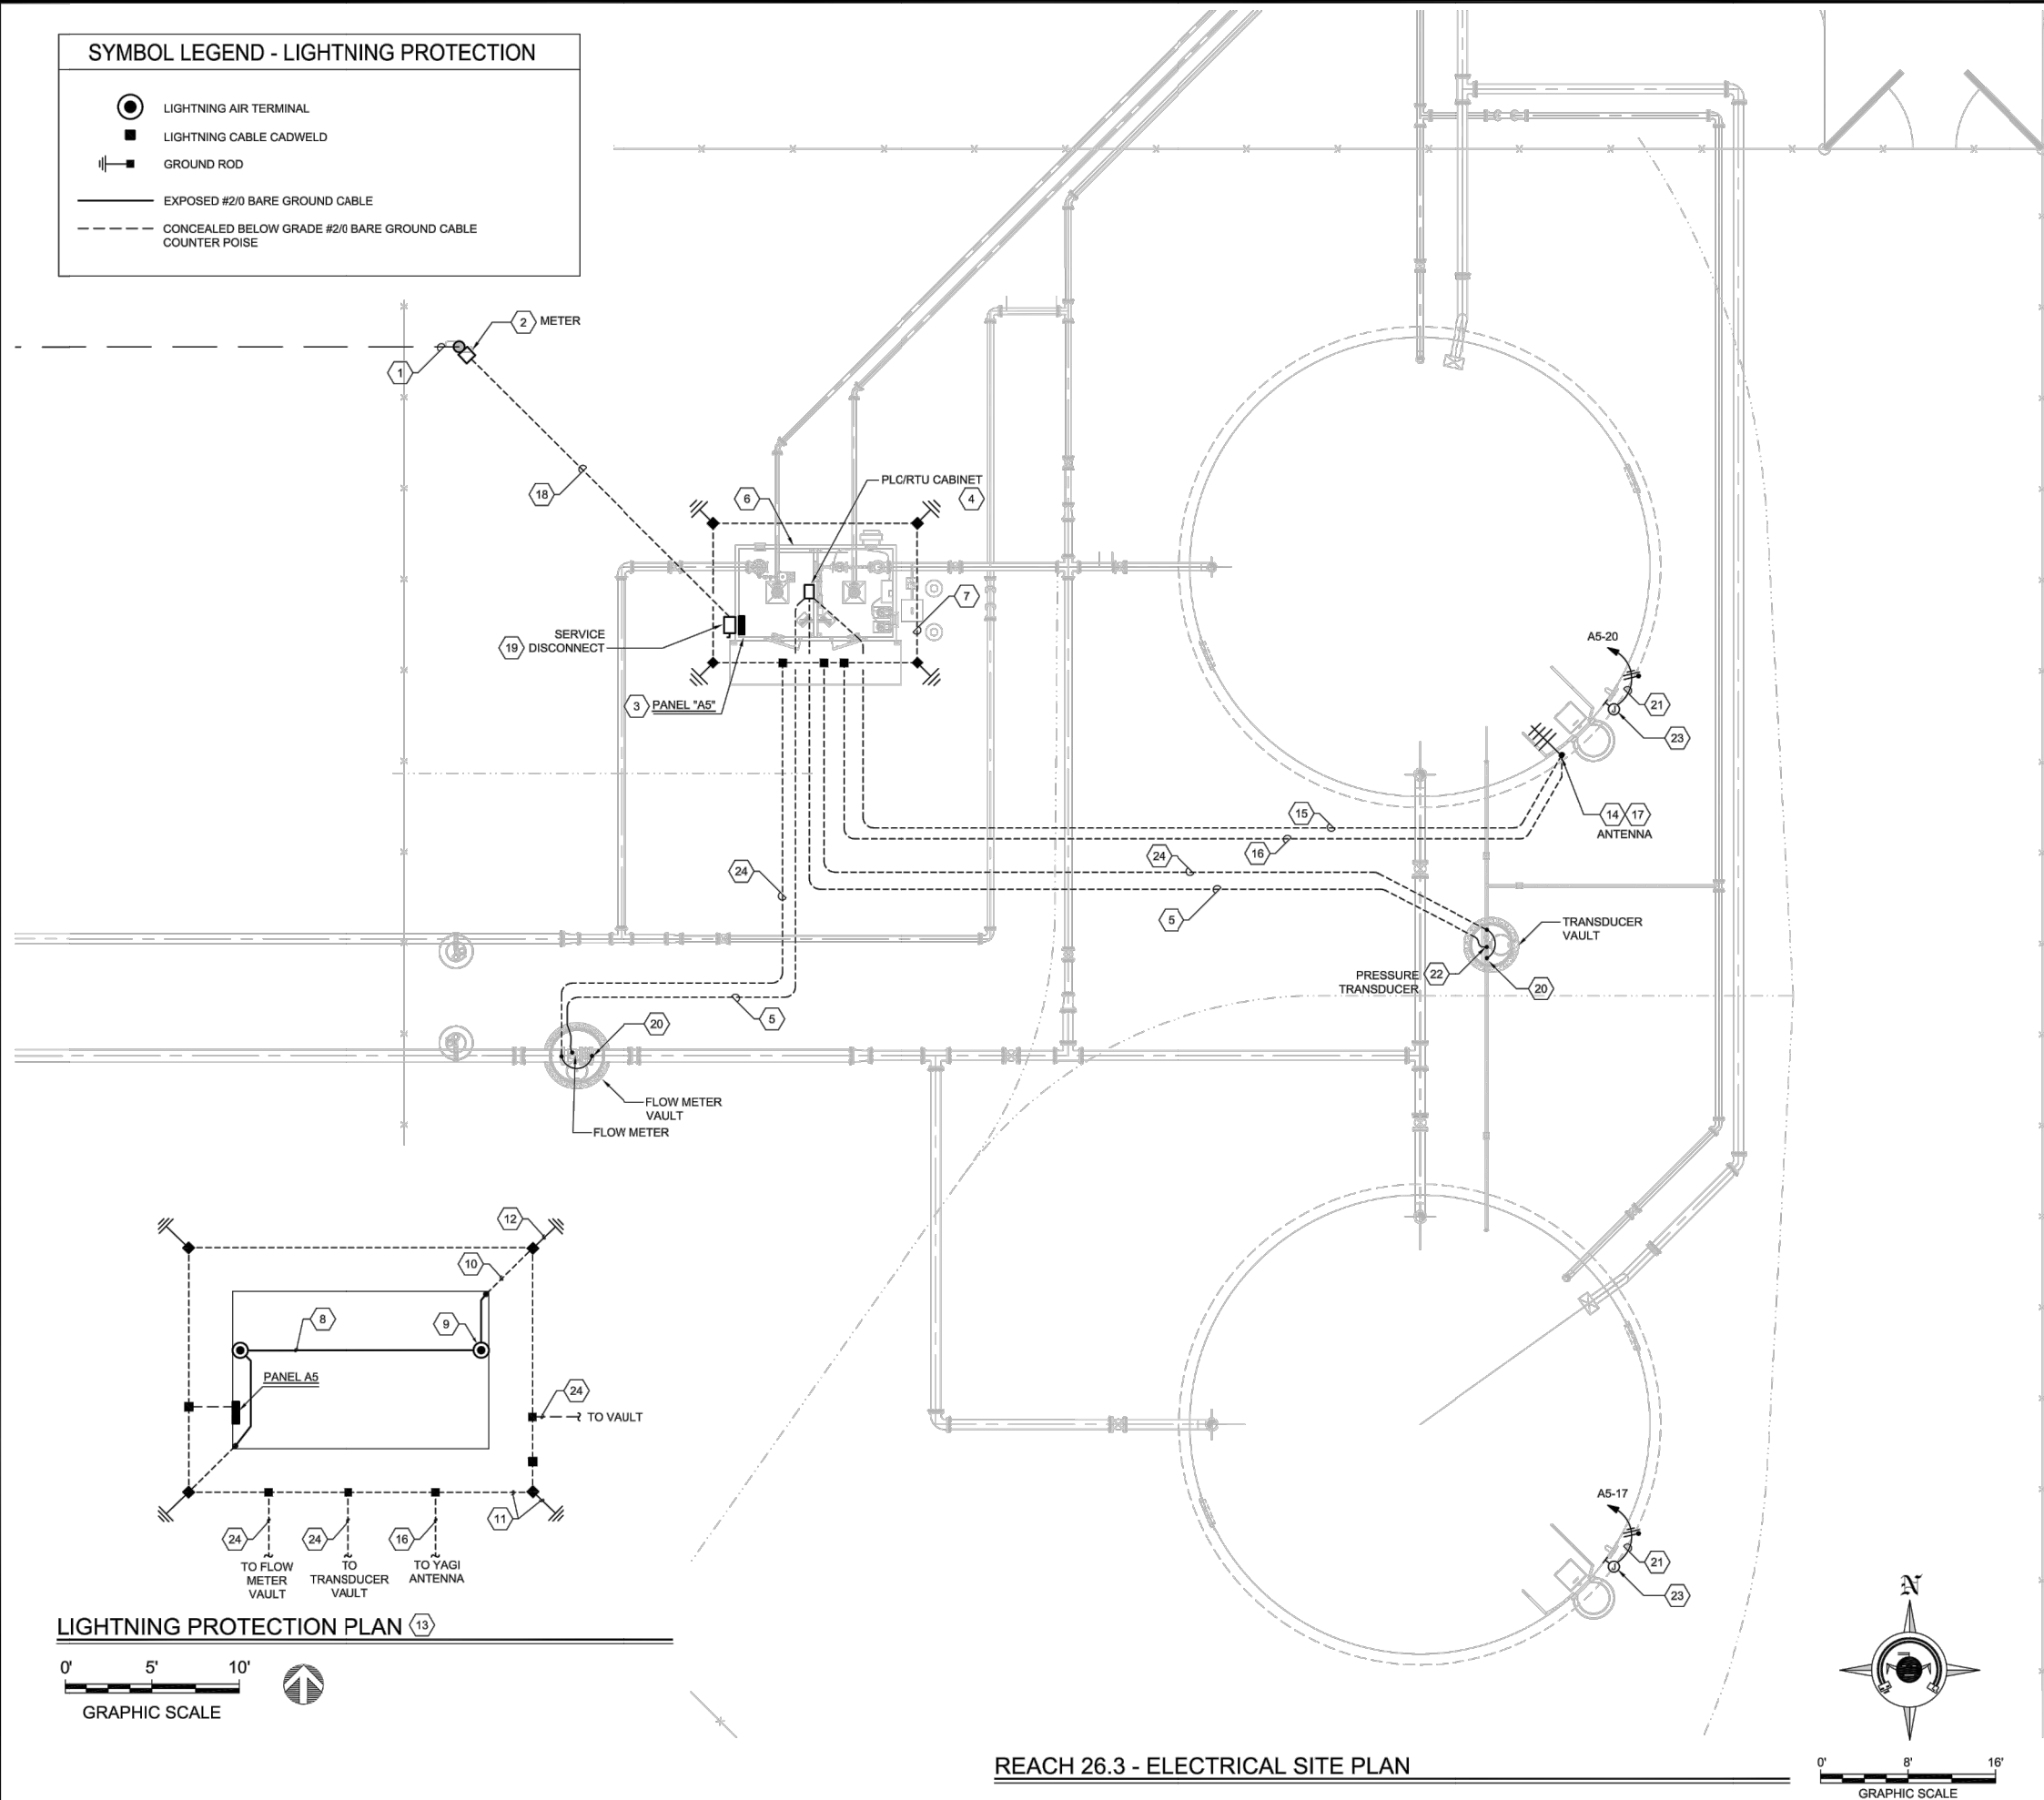

GENERAL NOTES

- REFER TO LIGHTNING PROTECTION SPECIFICATION SECTION 26 60 10 FOR ADDITIONAL INFORMATION.
- CONTRACTOR SHALL PROVIDE LIGHTNING PROTECTION SYSTEM DRAWING BEFORE INSTALLATION, INCLUDING GROUND RODS AND GROUNDING CABLES (BELOW GROUND AND ABOVE ROOF).
- AFTER THE SYSTEM HAS BEEN INSTALLED, THE UL LISTED INSTALLER SHALL COMPLETE AND SUBMIT THE CERTIFICATION APPLICATION.
- THE UL LISTED INSTALLER SHALL FORWARD THE CERTIFICATION TO THE OWNER AND PROVIDE PROOF THAT THE LIGHTNING PROTECTION SYSTEM IS IN COMPLIANCE WITH UL, NFPA, OR U.S. GOVERNMENT STANDARDS.
- GROUND ROD AND BUILDING COUNTER POISE DEPTH SHALL BE 24" BELOW GRADE.
- ALL GROUNDING WIRING SHALL BE PROPERLY CONNECTED PER SPECS SECTION 26 45 00.
- THE CONTRACTOR SHALL SELECT AN ADHESIVE FOR THE AIR TERMINALS THAT MANUFACTURED RECOMMENDED AND IS COMPATIBLE FOR USE WITH THE ROOFING SYSTEM.
- ALL WIRING CONNECTIONS, AIR TERMINAL BASES, CLAMPS, AND PLATES THAT COME IN CONTACT WITH THE ROOFING MATERIAL SHALL BE INSTALLED USING AN APPROVED ADHESIVE. THE LIGHTNING PROTECTION SYSTEM INSTALLER SHALL NOT CREATE ANY PENETRATION IN THE ROOF WHEN INSTALLING THEIR EQUIPMENT.
- ALL WIRING CONNECTORS, AIR TERMINALS, CLAMPS, ETC SHALL BE UL APPROVED FOR A LIGHTNING PROTECTION SYSTEM.

KEYED NOTES

- NEW OVERHEAD 240 VOLT, SINGLE PHASE LINE OF OVERHEAD CONDUCTORS TO POLE BY JEMEZ UTILITY COMPANY. POLE INSTALLED BY CONTRACTOR PER JEMEZ ELECTRIC COOP SPECIFICATION. VERIFY POWER POLE LOCATION WITH ENGINEER AND UTILITY PRIOR TO FINAL PLACEMENT. MAINTAIN 3'-0" CLEARANCE BETWEEN METER AND FENCE.
- CONTRACTOR SHALL PROVIDE A METER ENCLOSURE MOUNTED ON POLE. REFER TO POWER RISER DIAGRAM FOR ADDITIONAL REQUIREMENTS. METER SHALL FACE TOWARDS FENCE. 25'-0" POLE PROVIDED AND INSTALLED BY THE CONTRACTOR. PROVIDE A MINIMUM WORKING CLEARANCE OF 3'-0" BETWEEN METER AND FENCE PER N.E.C. REQUIREMENTS.
- BUILDING PANEL "A5". REFER TO POWER RISER DIAGRAM, BUILDING PLAN AND PANEL SCHEDULE FOR ADDITIONAL REQUIREMENTS ON SHEET E202.
- PLC CABINET. REFER TO FLOOR PLAN FOR LOCATION ON SHEET E201.
- UNDERGROUND CONDUIT RUN FROM THE VAULT INSTRUMENTATION TO THE PLC CABINET. REFER TO BUILDING CONTROL PLAN AND WIRING SCHEDULE ON SHEET E103 FOR CABLE AND CONDUIT REQUIREMENTS.
- NEW CHLORINATION BUILDING. REFER TO BUILDING PLAN ON SHEET E102 & E103 FOR EQUIPMENT LOCATIONS.
- REFER TO LIGHTNING PROTECTION PLAN ON THIS SHEET FOR ADDITIONAL REQUIREMENTS.
- LIGHTNING PROTECTION CLASS 1 ROOF-MOUNTED LATERAL CONDUCTOR AND MOUNTING HARDWARE.
- LIGHTNING PROTECTION AERIAL TERMINAL. 1/2" x 18" TUBULAR COPPER AERIAL TERMINAL AND MOUNTING HARDWARE, MOUNTED AT ROOF PARAPET, PENTHOUSE AND ROOFTOP UNITS AS INDICATED.
- LIGHTNING PROTECTION 2/0 BARE COPPER DOWN-CONDUCTOR.
- LIGHTNING PROTECTION COUNTERPOISE SYSTEM. ALL CONNECTIONS SHALL BE EXO-THERMIC WELDS.
- GROUND ROD. 3/4" X 10'-0" GROUND ROD
- LIGHTNING PROTECTION SYSTEM LAYOUT ON THIS PLAN IS FOR BIDDING PURPOSES ONLY. INSTALLATION TO BE PER NFPA-780, U.S. GOVERNMENT STANDARDS AND SPECIFICATIONS SECTION 26 60 10. SYSTEM SHALL BE PROVIDED WITH A MASTER LABEL.
- INSTALL A YAGI ANTENNA ON TOP OF A 2" RGS CONDUIT MAST AND MOUNT TO THE SIDE OF THE TANK LADDER CAGE. EXTEND CONDUIT TO 10' ABOVE TOP OF TANK. ADJUST ANTENNA FOR MAXIMUM SIGNAL STRENGTH FROM COUNSELOR SITE. REFER TO SHEET E103 FOR COAXIAL ANTENNA CABLE REQUIREMENT.
- 1" CONDUIT WITH CABLES FROM PLC TO ANTENNA MAST.
- BOND ANTENNA CABLE CONDUIT AND ANTENNA MAST TO A 8' X 5/8" COPPER-CLAD STEEL GROUND ROD AND TO BUILDING COUNTER POISE WITH #4 COPPER GROUND CONDUCTORS.
- REFER TO ANTENNA INSTALLATION DETAIL ON SHEET E203 FOR ADDITIONAL REQUIREMENTS.
- REFER TO POWER RISER DIAGRAM FOR UNDERGROUND CONDUIT AND CONDUCTOR SIZES FOR SECONDARY SERVICE.
- PROVIDE AND INSTALL A BUILDING MOUNTED SERVICE DISCONNECT SWITCH. REFER TO POWER RISER ON SHEET E201 FOR ADDITIONAL REQUIREMENTS.
- PROVIDE A 5/8" x 8' COPPER-CLAD STEEL GROUND ROD IN VAULT. CONNECT BOTH PIPE FLANGES AND ENCLOSURE TO THE GROUND ROD WITH #4 COPPER CONDUCTORS FROM VAULT GROUND ROD EXTEND A #4 COPPER CONDUCTOR IN A 3/4" CONDUIT, UP TO THE GROUNDING SYSTEM.
- HOMERUN 3 #12 - 1" CONDUIT FROM THE J-BOX TO PANEL "A4" LOCATED IN THE CHLORINATION BUILDING. ALL CONDUIT RISERS OUT OF THE GROUND SHALL BE RGS.
- TANK PRESSURE TRANSDUCER INSTALLED IN VAULT. REFER TO PRESSURE TRANSDUCER VAULT DETAIL ON SHEET E201.
- THE CONTRACTOR SHALL PROVIDE AND INSTALL A WEATHERPROOF J-BOX ADJACENT TO THE CATHODIC PROTECTION RECTIFIER. RECTIFIER WILL BE MOUNTED NEXT TO THE TANK LADDER. COORDINATE FINAL LOCATION PRIOR TO INSTALLATION. EXTEND POWER TO RECTIFIER AND MAKE FINAL CONNECTION AS REQUIRED BY MANUFACTURER'S RECOMMENDATIONS. (FOR USE WITH WELDED STEEL TANKS ONLY).
- EXTEND A #4 BARE COPPER CONDUCTOR BETWEEN VAULT GROUNDING AND BUILDING COUNTERPOISE.

WARNING

IF ANY UTILITY LINES, PIPELINES, OR UNDERGROUND UTILITY LINES ARE SHOWN ON THESE DRAWINGS, THEY ARE SHOWN IN AN APPROXIMATE MANNER ONLY, AND SUCH LINES MAY EXIST WHERE NONE ARE SHOWN. IF ANY SUCH EXISTING LINES ARE SHOWN, THE LOCATION IS BASED UPON INFORMATION PROVIDED BY THE UTILITY OR PIPELINE COMPANY, THE OWNER OR BY OTHERS, AND THE INFORMATION MAY BE INCOMPLETE, OR MAY BE OBSOLETE BY THE TIME CONSTRUCTION COMMENCES.

THE ENGINEER HAS UNDERTAKEN NO FIELD VERIFICATION OF THE LOCATION, DEPTH, SIZE OR TYPE OF EXISTING UTILITY LINES, PIPELINES, OR UNDERGROUND UTILITY LINES, MAKES NO REPRESENTATION PERTAINING THERETO, AND ASSUMES NO RESPONSIBILITY OR LIABILITY THEREFORE. THE CONTRACTOR SHALL INFORM ITSELF TO THE LOCATION OF ANY UTILITY LINE, PIPELINE OR UNDERGROUND UTILITY LINE IN OR NEAR THE AREA OF THE WORK IN ADVANCE OF AND DURING EXCAVATION WORK. THE CONTRACTOR IS FULLY RESPONSIBLE OF ANY AND ALL DAMAGE CAUSED BY ITS FAILURE TO LOCATE, IDENTIFY AND PRESERVE ANY AND ALL EXISTING UTILITIES, LINES, PIPELINES, OR UNDERGROUND UTILITY LINES. THE CONTRACTOR SHALL COMPLY WITH STATE STATUTES, MUNICIPAL AND LOCAL ORDINANCES, RULES, AND REGULATIONS, IF ANY, PERTAINING TO THE LOCATION OF THESE LINES AND FACILITIES IN PLANNING AND CONDUCTING EXCAVATION, WHETHER BY CALLING OR NOTIFYING THE UTILITIES, COMPLYING WITH "NM ONE CALL" PROCEDURES, OR OTHERWISE.

By	Checked	Description	Date	Revision

SMA
Soudier, Miller & Associates
5454 VENCE AVENUE NE, SUITE D
ALBUQUERQUE, NM 87113
Phone (505) 299-0942 Toll-Free (877) 299-0942 Fax (505) 293-3430
www.soudiermiller.com
Serving the Southwest & Rocky Mountains
Albuquerque, Carlsbad, Hobbs, Farmington, Las Cruces, Roswell, Santa Fe, NM
Cortez, Grand Junction, CO - Safford, AZ - Moab, UT - El Paso, TX

REACH 26.3 - ELECTRICAL SITE PLAN
NAVAJO GALLUP WATER SUPPLY
PROJECT - REACH 26.3
SANDOVAL & MCKINLEY COUNTIES, NEW MEXICO

CLIENT: The Navajo Nation
TOWN: Reach 26.3 To Torreon


Designed	Drawn	Checked
TR	TRG	DDR

15024
THIS DRAWING IS INCOMPLETE AND NOT TO BE USED FOR CONSTRUCTION UNLESS IT IS STAMPED, SIGNED AND DATED


NOTICE OF EXTENDED PAYMENT PROVISION:
THIS CONTRACT ALLOWS THE OWNER TO MAKE PAYMENT WITHIN 45 DAYS AFTER SUBMISSION OF AN UNDISPUTED REQUEST FOR PAYMENT.

811 Know what's below. Call before you dig.

Date: March 14, 2018
Scale: Horiz: N/A
Vert: N/A
Project No: 6921307
Sheet: E101

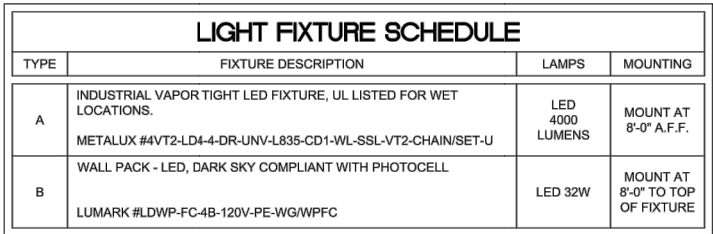


-

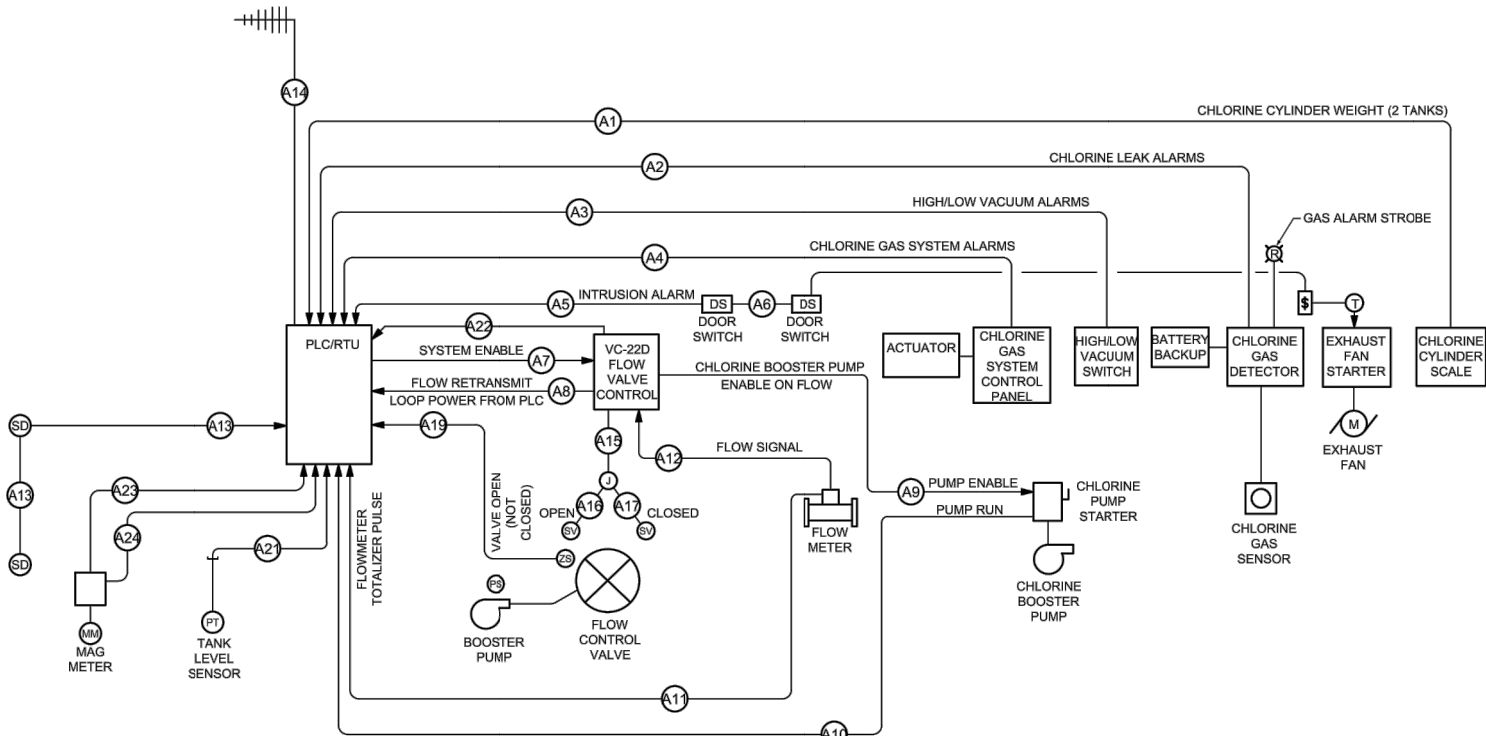


REACH 26.3 CHLORINATION BUILDING CONTROL RISER DIAGRAM

SCALE: NONE

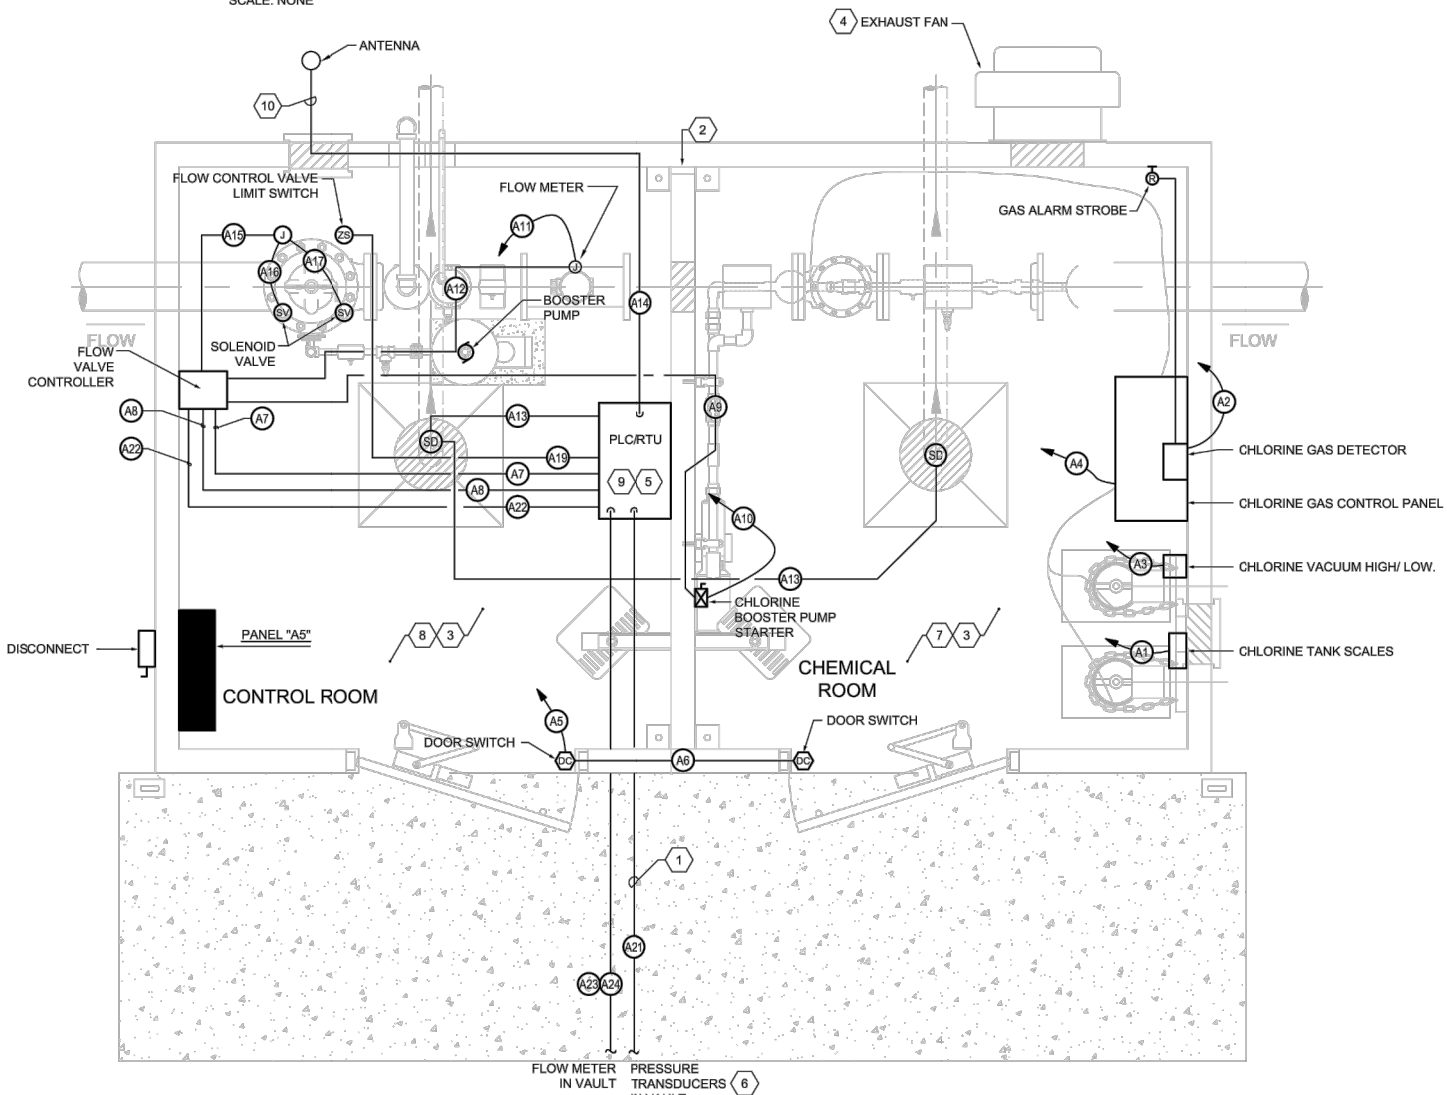

REACH 26.3 CHLORINATION BUILDING - SCADA SYSTEM AND CONTROL PLAN

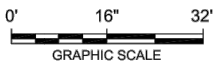

KEYED NOTES

- REFER TO SITE PLAN ON E101 FOR LOCATION OF PRESSURE TRANSDUCER.
- PROVIDE (2) 1/4" CONDUIT SLEEVES THROUGH WALL WITH J-BOXES ON EACH SIDE OF WALL AND FIRE SEAL GAS TIGHT. ALL CONTROL CABLES AND WIRING BETWEEN ROOMS SHALL BE ROUTED THROUGH SLEEVES. ONE CONDUIT FOR ANALOG CABLES THE OTHER FOR DIGITAL CABLES. SIZE J-BOXES PER NUMBER OF CONDUITS TERMINATIONS.
- PROVIDE AND INSTALL CONDUIT AND CABLING BETWEEN EQUIPMENT AS CALLED OUT IN THE CONTROL WIRING SCHEDULE AND CONTROL RISER LOCATED ON THIS SHEET. COORDINATE TERMINATION OF CABLE PER THE EQUIPMENT SUPPLIER AND REQUIREMENTS IN THE TECHNICAL SPECIFICATIONS.
- REFER TO CONTROL DIAGRAM ON SHEET E-202 FOR EXHAUST FAN AND DETECTION SYSTEM CONTROLS.
- PLC CONFIGURED TO OWNERS STANDARDS AND REQUIREMENTS, REFER TO SHEET E-301 THRU E-303 AND SPECIFICATIONS.
- TANK LEVEL PRESSURE TRANSDUCER, AMETEK MODEL 88C 003-A-2-RANGE 0-30PSI ANALOG PRESSURE TRANSDUCER, INSTALLED IN NEW VAULT. REFER TO VAULT DETAIL ON SHEET E-201 FOR ADDITIONAL REQUIREMENTS.
- ALL EXPOSED CONDUIT RUNS WITHIN THE CHLORINATION CHEMICAL SIDE OF THE BUILDING SHALL BE PVC CONDUIT. ALL HANGERS AND FITTINGS SHALL BE PVC COATED. CONDUITS THAT EXIT THE CHEMICAL SIDE OF THE BUILDING SHALL BE PROVIDED WITH A SEAL OFF FITTING AFTER EXITING. ALL EQUIPMENT AND MOTOR ENCLOSURE SHALL BE RATED FOR USE WITHIN A CORROSIVE ENVIRONMENT AND WET LOCATION.
- ALL EXPOSED CONDUIT INSTALLED WITHIN THE CONTROL ROOM SIDE OF THE CHLORINATION BUILDING SHALL BE RIGID STEEL CONDUIT WITH THREADED CONDUIT BODIES. ALL EQUIPMENT ENCLOSURES AND CONDUIT INSTALLATION SHALL BE RATED FOR WET LOCATION.
- THE PLC / RTU CABINET WILL BE PROVIDED WITH UNLICENSED RADIO TYPE TRANSNET AS MANUFACTURED BY GE, WHICH WILL TRANSMIT AND RECEIVE SIGNALS FROM COUNSELOR SITE.
- PROVIDE AND INSTALL LIGHTNING ARRESTORS ON THE ANTENNA CABLES IN THE PLC / RTU CABINET FOR THE CONNECTION OF THE CABLES BETWEEN THE ANTENNA AND RADIOS. PROVIDE AND INSTALL DATA AND SIGNAL LINE PROTECTION BETWEEN THE PRESSURE TRANSDUCER AND THE PLC CONNECTION. LINE PROTECTOR AS MANUFACTURED BY JOSLYN #1820-28-A3 ON EACH LINE.

Control Wiring Schedule			
TAG #	FED FROM	TO	WIRE REQUIRMENTS
A1	Chlorine Scale	PLC Panel	2-2/C #18 Twisted Pair Shielded Cable - 1/2" Conduit
A2	Chlorine Gas Detector	PLC Panel	6 # 14, 1 # 14 Gnd - 1/2" Conduit
A3	High/Low Vacuum Switch	PLC Panel	6 # 14, 1 # 14 Gnd - 1/2" Conduit
A4	Chlorine Gas Control Panel	PLC Panel	4 # 14, 1 # 14 Gnd - 1/2" Conduit
A5	Door Switch	PLC Panel	2 # 14, 1 # 14 Gnd - 1/2" Conduit
A6	Door Switch	Door Switch	2 # 14, 1 # 14 Gnd - 1/2" Conduit
A7	PLC Panel	Flow Valve Control	2-2/C #18 Twisted Pair Shielded Cable - 1/2" Conduit
A8	Flow Valve Control	PLC Panel	2 # 14, 1 # 14 Gnd - 1/2" Conduit
A9	Flow Valve Control	Chlorine Booster Pump Starter	2 # 14, 1 # 14 Gnd - 1/2" Conduit
A10	Chlorine Booster Pump Starter	PLC Panel	2 # 14, 1 # 14 Gnd - 1/2" Conduit
A11	Flow Meter	PLC Panel	2 # 14, 1 # 14 Gnd - 1/2" Conduit
A12	Flow Meter	Flow Valve Control	2-2/C #18 Twisted Pair Shielded Cable - 1/2" Conduit
A13	Smoke Detectors	PLC	2 #14, 1 #14 Gnd - 1/2" Conduit
A14	Radio Transmitter Unit (RTU)	YAGI Antenna	1" Conduits each with Cable - Refer to Specification 27 43 30 2.4.C2 for Cable Requirements
A15	Flow Valve Control	Solenoid Valves J-box	3 # 14, 1 # 14 Gnd - 1/2" Conduit
A16	Solenoid Valve J-box	Solenoid Valve Open	2 # 14, 1 # 14 Gnd - 1/2" Conduit
A17	Solenoid Valve J-box	Solenoid Valve Closed	2 # 14, 1 # 14 Gnd - 1/2" Conduit
A18	not used	not used	not used
A19	Flow Control Valve Limit Switch	PLC Panel	2 # 14, 1 # 14 Gnd - 1/2" Conduit
A20	not used	not used	not used
A21	Pressure Transducer	PLC Panel	1 - 2/C #16 Twisted Pair Shielded Cable - 1" Conduit.
A22	Flow Rate Signal	PLC/RTU	1 - 2/C #18 Twisted Pair Shielded Cable - 1/2" Conduit.
A23	Mag Meter Flow Rate	PLC/RTU	2/C #18 Twisted Pair Cable - 3/4" Conduit
A24	Flow Alarms	PLC/RTU	5 # 14, 1 # 14 Gnd - 1/2" Conduit

By	Checked	Description	Date	Revision

SMA
Engineering • Environmental
Surveying

SOUDER, MILLER & ASSOCIATES
5454 VANCE AVENUE NE, SUITE D
ALBUQUERQUE, NM 87113
Phone (505) 299-0942 Toll-Free (877) 299-0942 Fax (505) 293-3430
www.soudermiller.com
Serving the Southwest & Rocky Mountains
Albuquerque, Carlsbad, Hobbs, Farmington, Las Cruces, Roswell, Santa Fe, NM
Corona, Grand Junction, CO - Salt Lake City, UT - El Paso, TX
-202018 8:14:27 AM Thane

CLIENT: The Navajo Nation
TOWN: Reach 26.3 To Tonnore

REACH 26.3 - CHLORINATION BUILDING
SCADA SYSTEM AND CONTROL PLAN
NAVAJO GALLUP WATER SUPPLY
PROJECT - REACH 26.3
SANDOVAL & MCKINLEY COUNTIES, NEW MEXICO

Designed	Drawn	Checked
TR	TRG	DDR


15024

THIS DRAWING IS INCOMPLETE
AND NOT TO BE USED FOR
CONSTRUCTION UNLESS IT IS
STAMPED, SIGNED AND DATED

NOTICE OF EXTENDED
PAYMENT PROVISION:
THIS CONTRACT ALLOWS THE
OWNER TO MAKE PAYMENT
WITHIN 45 DAYS AFTER
SUBMISSION OF
AN UNDISPUTED REQUEST
FOR PAYMENT.

811
Know what's
below.
Call before
you dig.

Date: March 14, 2018
Scale: Horiz: N/A
Vert: N/A
Project No: 6921307
Sheet: E103

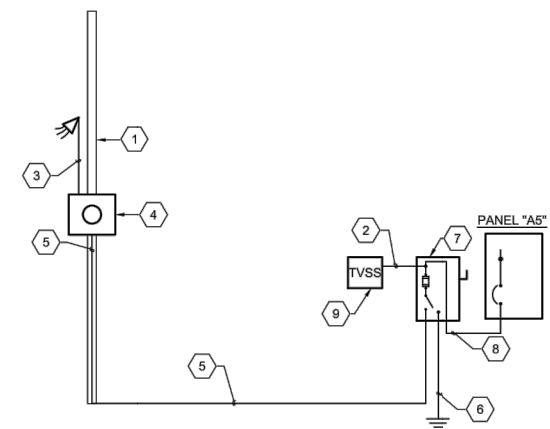


REACH 26.3
CHLORINATOR BUILDING POWER RISER DIAGRAM
SCALE: NONE

KEYED NOTES


1. PROVIDE AND INSTALL A 25'-0" SOUTHERN PINE CLASS 4 WOOD POLE FOR THE INSTALLATION OF RISER, METER AND DISCONNECT. LOCATE POLE TO PROVIDE A MINIMUM OF 3'-0" CLEARANCE BETWEEN FENCE AND FACE OF METER.
2. 4 # 8 - 1" CONDUIT BETWEEN TVSS AND PANEL.
3. PROVIDE A 2" RGS CONDUIT ON POLE RISER WITH CONDUCTORS. COORDINATE INSTALLATION WITH JEMEZ ELECTRIC PRIOR TO PROCEEDING WITH INSTALLATION OF CONDUITS
4. PROVIDE AND INSTALL A 100 AMP 120/240 VOLT METER SOCKET PER THE LOCAL UTILITY COMPANY REQUIREMENT FACING FENCE.
5. 3 #2 CONDUCTORS IN 2" CONDUIT
6. REFER TO TYPICAL 120/240 VOLT GROUND DETAIL
7. PROVIDE AND INSTALL A FUSIBLE DISCONNECT SWITCH, 100 AMPS, 250 VOLTS, 2 POLE, SN AND GROUND LUG, NEMA 3R ENCLOSURE. FUSE AT 100 AMPS. PROVIDE A MINIMUM WORKING CLEARANCE OF 3'-0" WIDE IN FRONT OF DISCONNECT SWITCH PER NEC.
8. 3 # 2, 1 # 8 GROUND 1 1/4" CONDUIT
9. PROVIDE AND INSTALL A TRANSIENT VOLTAGE SURGE SUPPRESSION DEVICE. THE TVSS SHALL BE MANUFACTURED BY RAYCAP #120-2S-M3-3-06-A-H OR APPROVED EQUAL, NEMA 3R ENCLOSURE.

DISCRETE & ANALOG I/O LIST - REFER TO PLANS & SPECIFICATIONS FOR SEQUENCE OF OPERATIONS							
Site Name	I/O Name	Tag	Point	Type	Local	SCADA	Notes
Reach 26.3 Chlorination Building	Intrusion Alarm Control Room		I1	DI		Yes	
	Intrusion Alarm Chlorine Room		I2	DI		Yes	
	Smoke Detector		I3	DI		Yes	
	Chlorine Leak Warning		I4	DI		Yes	
	Chlorine Leak Alarm		I5	DI		Yes	
	Chlorine Detector Fault		I6	DI		Yes	
	Chlorine High Vacuum Alarm		I7	DI		Yes	
	Chlorine Low Vacuum Alarm		I8	DI		Yes	
	Chlorination System Alarm		I9	DI		Yes	
	Chlorine Booster Pump Running		I10	DI		Yes	
	Flow Valve Open		I11	DI		Yes	
	Low Temperature Alarm		I12	DI		Yes	
	Manual Flow Control Valve Override		I13	DO		Yes	SCADA override tank level function and close control valve
	Chlorinator Flow Meter Totalizer Pulse		I14	DI		Yes	
	Chlorinator Flow Meter Low Battery		I15	DI		Yes	
	Chlorinator Pulse Modular Low Battery		I16	DI		Yes	
	Chlorinator Flow Meter Tamper Alarm		I17	DI		Yes	
	Vault Flow Meter Totalizer Pulse		I18	DI		Yes	
	Vault Flow Meter Low Battery		I19	DI		Yes	
	Vault Pulse Modular Low Battery		I20	DI		Yes	
	Vault Flow Meter Tamper Alarm		I21	DI		Yes	
	Chlorinator Flow Meter (Totalizer Pulses)		PI1	DI		Yes	SCADA shows totalized volume of water (gallons)
	Vault Flow Meter (Totalizer Pulses)		PI2	DI			
	Flow Enable		DO1	DO	Yes		Interpose Relay From Distribution Tank Level
			DO2	DO			Interpose Relay
	Distribution Tank Level		AI1	AI		Yes	
	Chlorinator Flow Meter (Flow Rate)		AI2	AI		Yes	SCADA shows flow rate (gpm)
	Vault Flow Meter (Flow Rate)		AI3	AI		Yes	SCADA shows flow rate (gpm)
	Chlorine Bottle #1 Weight		AI4	AI		Yes	
	Chlorine Bottle #2 Weight		AI5	AI		Yes	

LOAD SUMMARY - PANEL "A5"	
DESCRIPTION	
PANELBOARD "A5" ESTIMATED DEMAND PER NEC 220	
MECHANICAL UNITS (8.0 KVA CONN)	8.0 KVA
RECEPTACLES (0.9 KVA CONN) FIRST 10 KVA AT 100% REMAINING AT 50%	0.9 KVA
LIGHTING (0.3 KVA CONN) AT 100%	0.3 KVA
EQUIPMENT (3.6 KVA CONN) AT 100%	3.6 KVA
TOTAL ESTIMATED LOAD:	12.8 KVA
53 AMPERES AT 120Y/240V-1Ø-4W	
MINIMUM SERVICE CAPACITY =125% x TOTAL ESTIMATED LOAD	16.0 KVA
66 AMPERES AT 120Y/240V-1Ø-4W	
∴ MINIMUM RECOMMENDED SERVICE SIZE =	100 AMPS

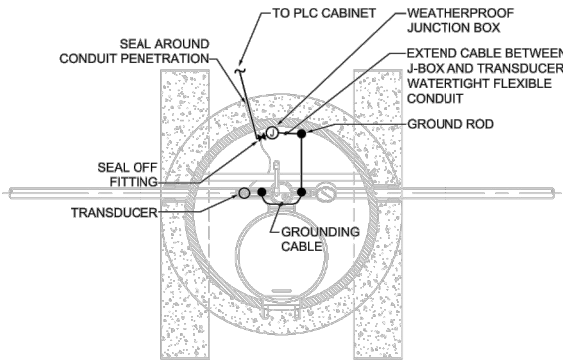

PRESSURE TRANSDUCER VAULT DETAIL
NOT TO SCALE

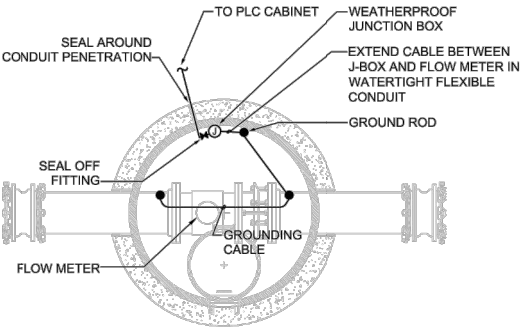

FLOW METER VAULT DETAIL
NOT TO SCALE

CLIENT: The Navajo Nation

TOWN: Reach 26.3 To Turreon

REACH 26.3 - ELECTRICAL SCHEDULES AND DETAILS

NAVAJO GALLUP WATER SUPPLY PROJECT - REACH 26.3

SANDOVAL & MCKINLEY COUNTIES, NEW MEXICO

Designed TR

Drawn TRG

Checked DDR

6729

REGISTERED PROFESSIONAL ENGINEER

03/14/18

15024

THIS DRAWING IS INCOMPLETE AND NOT TO BE USED FOR CONSTRUCTION UNLESS IT IS STAMPED, SIGNED AND DATED

NOTICE OF EXTENDED PAYMENT PROVISION: THIS CONTRACT ALLOWS THE OWNER TO MAKE PAYMENT WITHIN 45 DAYS AFTER SUBMISSION OF AN UNDISPUTED REQUEST FOR PAYMENT.

811

Know what's below. Call before you dig.

Date: March 14, 2018

Scale: Horiz: N/A
Vert: N/A

Project No: 6921307

Sheet: E201

SMA

SOUDER, MILLER & ASSOCIATES

5454 VENCE AVENUE NE, SUITE D

ALBUQUERQUE, NM 87113

Phone (505) 299-0942 Toll-Free (877) 299-0942 Fax (505) 293-3430

www.soudemiller.com

Serving the Southwest & Rocky Mountains

Albuquerque, Carlsbad, Hobbs, Farmington, Las Cruces, Roswell, Santa Fe, NM

Center, Grand Junction, CO - Safford, AZ - Moab, UT - El Paso, TX


Revision

Date


Description

By

Chk'd

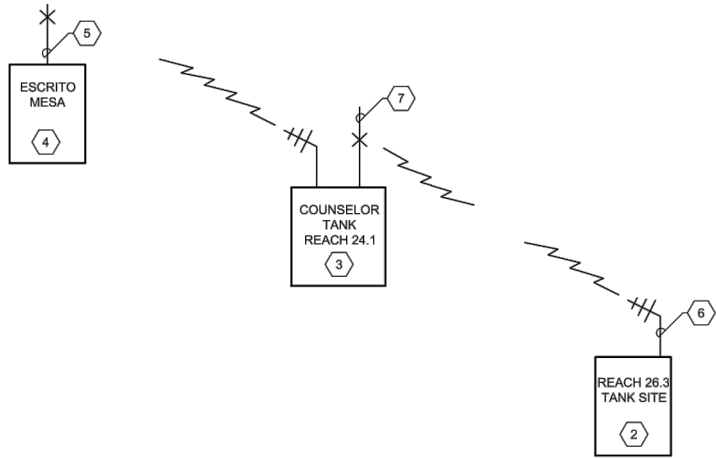


SCADA RADIO TELEMETRY SYSTEM CONFIGURATION

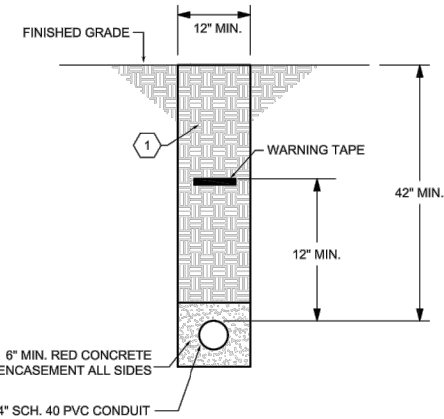


TYPICAL PRIMARY CONDUIT TRENCH DETAIL

SCALE: NONE

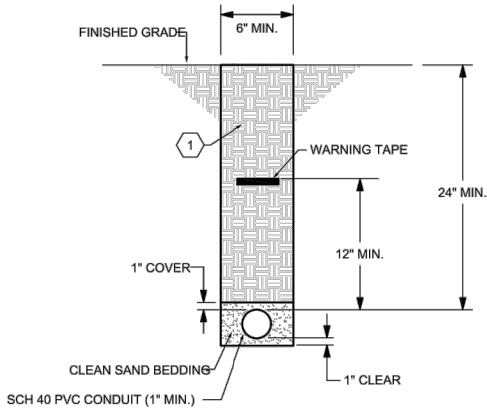


TYPICAL SINGLE CONDUIT TRENCH DETAIL

SCALE: NONE

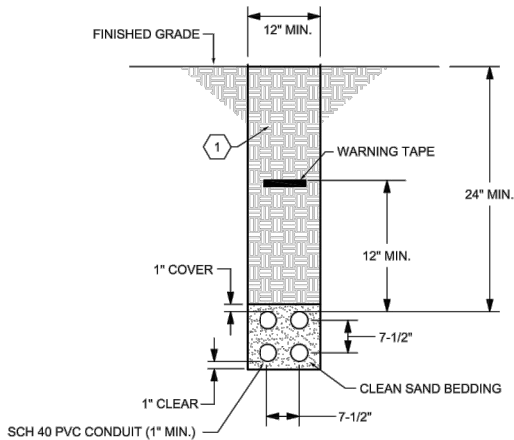

TYPICAL MULTIPLE CONDUIT TRENCH DETAIL

SCALE: NONE

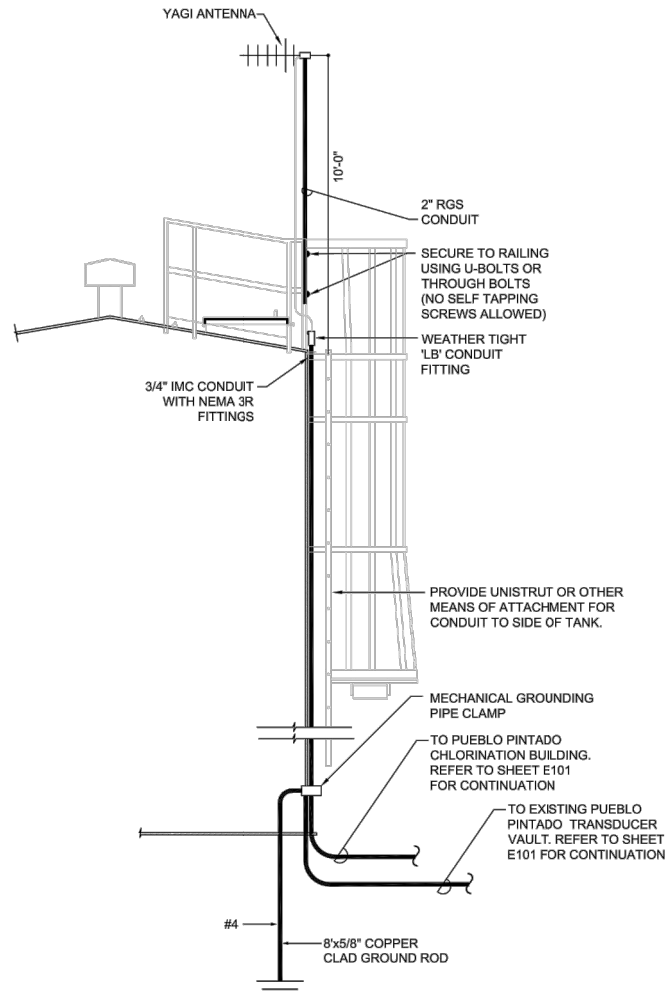

TYPICAL TANK RADIO TELEMETRY ANTENNA INSTALLATION DETAIL - REACH 26.3

SCALE: NONE

KEYED NOTES

1. REFER TO GENERAL NOTES ON SHEET E001 FOR BACKFILL REQUIREMENTS
2. NEW UNLICENSED GE MDS TRANSNET 900 MHz RADIO LINK. REFER TO SPECIFICATION SECTION 27 43 30 FOR ADDITIONAL REQUIREMENTS.
3. EXISTING UNLICENSED GE MDS TRANSNET 900 MHz RADIO LINK. REPROGRAM EXISTING SCADA PLC TO COMMUNICATE WITH NEW RTU.
4. EXISTING ESCRITO MESA SITE
5. EXISTING ANTENNA.
6. NEW YAGI ANTENNA. REFER TO SPECIFICATION SECTION 27 43 30 FOR ADDITIONAL REQUIREMENTS.
7. EXISTING OMNI ANTENNA.

Revision	Date	Description	By	Check

SMA
Souder, Miller & Associates
5454 VENCE AVENUE NE, SUITE D
ALBUQUERQUE, NM 87113
Phone (505) 299-0942 Toll-Free (877) 299-0942 Fax (505) 293-3430
www.soudemiller.com

Serving the Southwest & Rocky Mountains
Albuquerque, Carlsbad, Hobbs, Farmington, Las Cruces, Roswell, Santa Fe, NM
Cortez, Grand Junction, CO - Safford, AZ - Moab, UT - El Paso, TX
© 2018 SMA & 1314 4th Floor

CLIENT: The Navajo Nation
TOWN: Reach 26.3 To Turren

REACH 26.3 - ELECTRICAL DETAILS
NAVAJO GALLUP WATER SUPPLY
PROJECT - REACH 26.3
SANDOVAL & MCKINLEY COUNTIES, NEW MEXICO

Designed	Drawn	Checked
TR	TRG	DDR






15024
THIS DRAWING IS INCOMPLETE AND NOT TO BE USED FOR CONSTRUCTION UNLESS IT IS STAMPED, SIGNED AND DATED

NOTICE OF EXTENDED PAYMENT PROVISION: THIS CONTRACT PROVIDES THE OWNER TO MAKE PAYMENT WITHIN 45 DAYS AFTER SUBMISSION OF AN UNDISPUTED REQUEST FOR PAYMENT.



Date:	March 14, 2018
Scale:	Horiz: N/A Vert: N/A
Project No:	6921307
Sheet:	E203

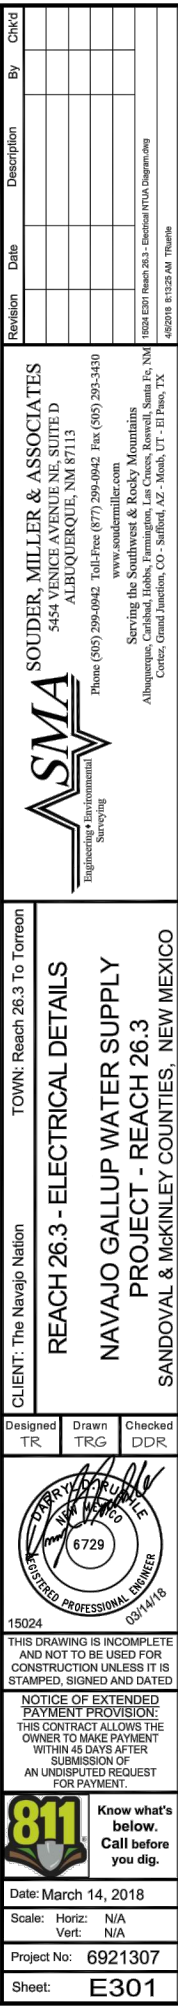

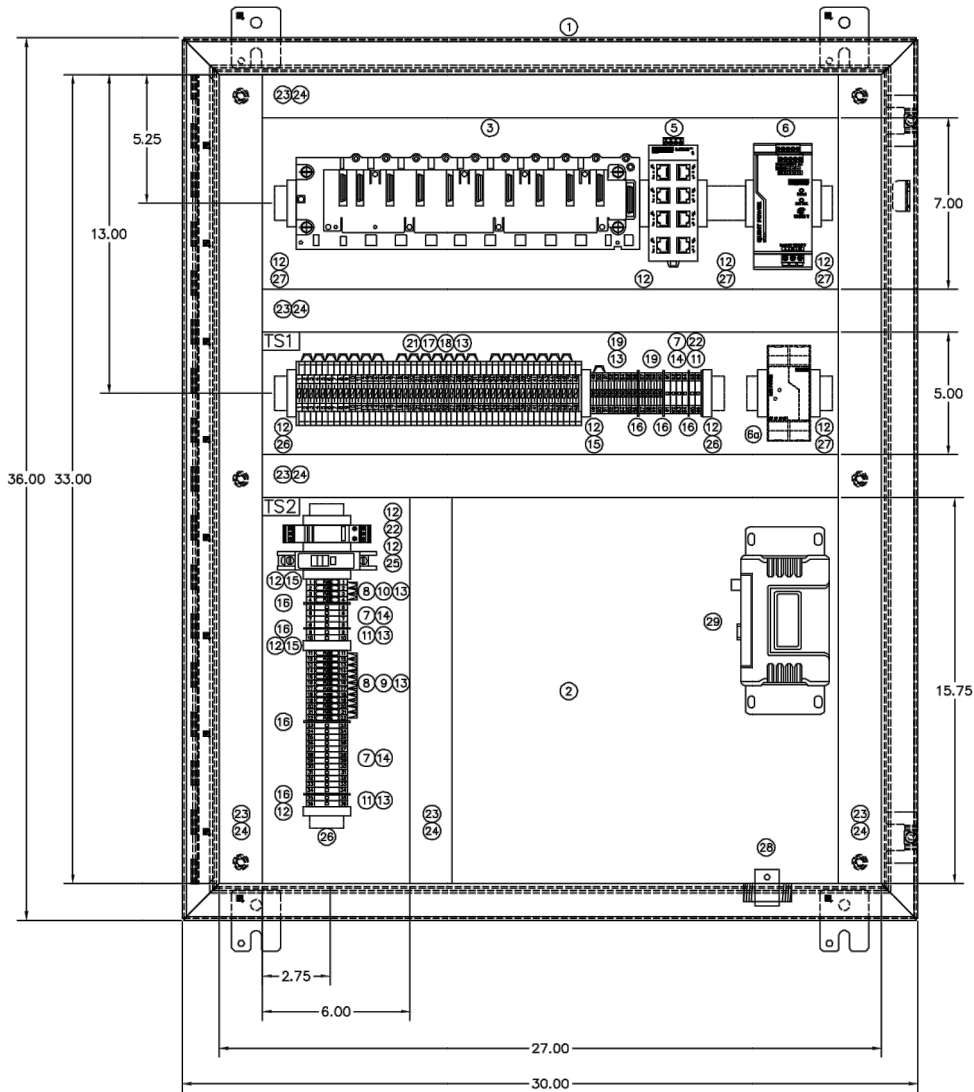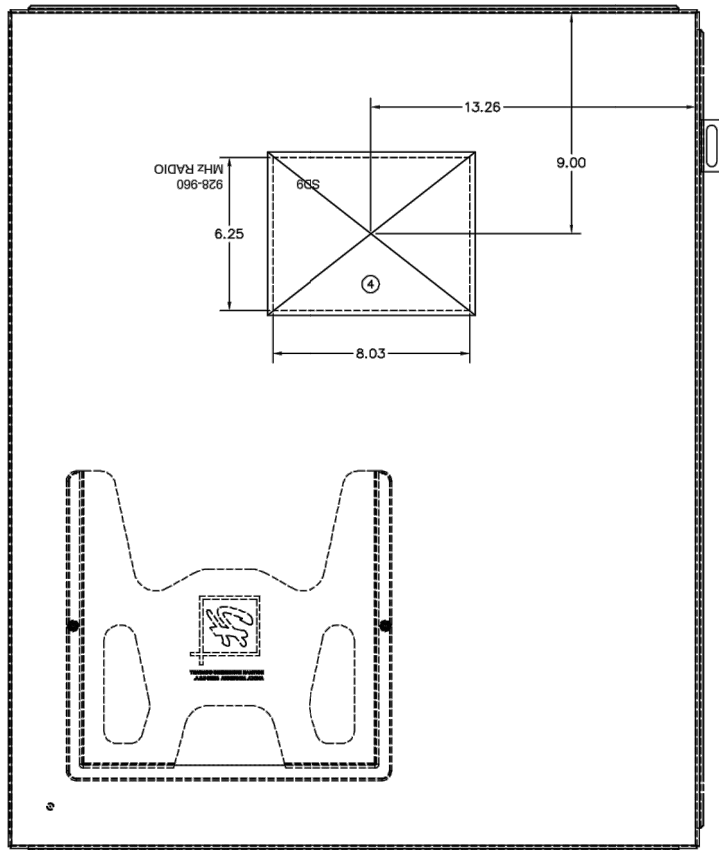

BILL OF MATERIALS				
ITEM	QTY	PART NO.	DESCRIPTION	MFG
1	1	SCE-362410P	SINGLE-DOOR TYPE 12 ENCLOSURE	SAGINAW
2	1	SCE-36P30	BACKPLANE	SAGINAW
3*	.	M340	MODICON M340 BOM	MODICON
3a	1	BMXXBM0800	8-SLOT RACK MODULE	MODICON
3b	1	BMXCP3020	POWER SUPPLY	MODICON
3c	1	BMX342020	CPU PROCESSOR MODULE	MODICON
3d	1	BMXDDI16D2	DIGITAL INPUT MODULE	MODICON
3e	1	BMXDR16D5	DIGITAL OUTPUT MODULE	MODICON
3f	1	BMXANI0410	ANALOG INPUT MODULE	MODICON
3g	1	BMXAM00210	ANALOG OUTPUT MODULE	MODICON
3h	1	BMXNOR0200H	ETHERNET/SERIAL RTU MODULE	MODICON
3i	4	BMXFTB2010	REMOVABLE CONNECTION BLOCK - SCREW CLAMP	MODICON
4	1	HMI6T02310	GRAPHIC TERMINAL TOUCHSCREEN (MAGELIS)	SCHNEIDER
5	1	FL SWITCH SFN 8TX	ETHERNET SWITCH	ELECTRIC PHOENIX CONTACT
6	1	QUINT-PS/1AC/ 24DC/10	POWER SUPPLY 22.5-28.5V ADJUSTABLE	PHOENIX CONTACT
6a	1	MINI-PS-100-240 AC/10-15DC/2	POWER SUPPLY 10-15V ADJUSTABLE	PHOENIX CONTACT
7	20	UK5 N	UK5 N TERMINALS	PHOENIX CONTACT
8	16	UK4TG	FUSE TERMINAL BASE	PHOENIX CONTACT
9	12	ST-SILED24UK4	FUSE	PHOENIX CONTACT
10	4	ST-SILA250UK4	FUSE	PHOENIX CONTACT
11	6	USLK05	GROUNDING TERMINAL	PHOENIX CONTACT
12	15	E/NS35N	END CLAMP	PHOENIX CONTACT
13	10	FB10-6 #0201184	FIXED BRIDGE	PHOENIX CONTACT
14	10	EB10-6 #0201139	INSERTION BRIDGE	PHOENIX CONTACT
15	10	D-UK4/10	END COVER	PHOENIX CONTACT
16	10	ATP-UK	PARTITION PLATES	PHOENIX CONTACT
17	3	DP-UKK3/5BK #2770833	SLKK5 SPACER PLATE	PHOENIX CONTACT
18	3	D-UKK3/5BK #2770226	SLKK5 ENDCOVER	PHOENIX CONTACT
19	12	TT-UK5/24DC #2794699	TERMITRAB UK5 W/SUPPRESSOR DIODE	PHOENIX CONTACT
20	.			
21	48	TT-SLKK5/24DC #2794903	TERMITRAB SLKK5 W/VARISTOR 24DC (MOV)	PHOENIX CONTACT
22	1	PT2PE/SI20FM	TERMITRAB AC SURGE PROTECTION	PHOENIX CONTACT
23	AN	F2X4LG6	TYPE F NARROW SLOT WIRING DUCT	PANDUIT
24	AN	C2LG6	WIRING DUCT COVER	PANDUIT
25	1	QOU115	CIRCUIT BREAKER	SQUARE D
26	1	1492DR6	EXTENDED DIN RAIL	ALLEN BRADLEY
27	1	1492-DR5	DIN RAIL	ALLEN BRADLEY
28	1	IS-50NX-C2	LIGHTNING ARRESTER	POLYPHASE
29	1	SD9	928-960 MHz RADIO	GEMDS
30	1	CAT5E	CABLE - PLC TO HMI	BELKIN
31	1	.	CABLE - PLC TO MODEM (TO LENGTH)	

AN - As needed
3* - BOM - To include items 3a-3g.

NO.	DATE	DESCRIPTION	BY
01	09/13	MATERIALS LIST & DWG UPDATES	NTUA
NAVAJO TRIBAL UTILITY AUTHORITY			
SCALE:	NONE	REVISION:	BY DATE
DATE:			
DWG:	DRG.		
APP:			
TITLE	PLC CONTROL PANEL		NSP
	BACKPLANE		
			SHEET 5 OF 6

CLIENT: The Navajo Nation
TOWN: Reach 26.3 To Torreon

REACH 26.3 - ELECTRICAL DETAILS
NAVAJO GALLUP WATER SUPPLY
PROJECT - REACH 26.3
SANDOVAL & MCKINLEY COUNTIES, NEW MEXICO

DESIGNED: TR
DRAWN: TRG
CHECKED: DDR

15024
THIS DRAWING IS INCOMPLETE
AND NOT TO BE USED FOR
CONSTRUCTION UNLESS IT IS
STAMPED, SIGNED AND DATED

NOTICE OF EXTENDED
PAYMENT PROVISION:
THIS CONTRACT ALLOWS THE
OWNER TO MAKE PAYMENT
WITHIN 45 DAYS AFTER
SUBMISSION OF
AN UNDISPUTED REQUEST
FOR PAYMENT.

811
Know what's
below.
Call before
you dig.

Date: March 14, 2018
Scale: Horiz: N/A
Vert: N/A
Project No: 6921307
Sheet: E302

SOUDER, MILLER & ASSOCIATES
5454 VENCE AVENUE NE, SUITE D
ALBUQUERQUE, NM 87113
Phone (505) 295-0942 Toll-Free (877) 295-0942 Fax (505) 295-3430
www.soudermiller.com
Serving the Southwest & Rocky Mountains
Albuquerque, Carlsbad, Hobbs, Farmington, Las Cruces, Roswell, Santa Fe, NM
Chattanooga, CO - Safford, AZ - Moab, UT - El Paso, TX

Revision Description Date By Chkd

15024 E302 Reach 26.3 - Electrical NTUA Diagram.dwg
4/28/2018 8:12:22 AM Thane

[illegible]

CLIENT: The Navajo Nation
TOWN: Reach 26.3 To Torreon

REACH 26.3 - ELECTRICAL DETAILS

NAVAJO GALLUP WATER SUPPLY
PROJECT - REACH 26.3

SANDOVAL & MCKINLEY COUNTIES, NEW MEXICO

**NOTICE OF EXTENDED
PAYMENT PROVISION:**
THIS CONTRACT ALLOWS THE
OWNER TO MAKE PAYMENT
WITHIN 45 DAYS AFTER
SUBMISSION OF
AN UNDISPUTED REQUEST
FOR PAYMENT.

