
B C D E F G H I J K L M N O P

NAVAJO NATION



LOWER GREASEWOOD WATER SYSTEM IMPROVEMENTS
DRAWINGS FOR CORNFIELDS PARALLEL AND LOWER
GREASEWOOD INTERCONNECTION PIPELINES
JUNE 2017

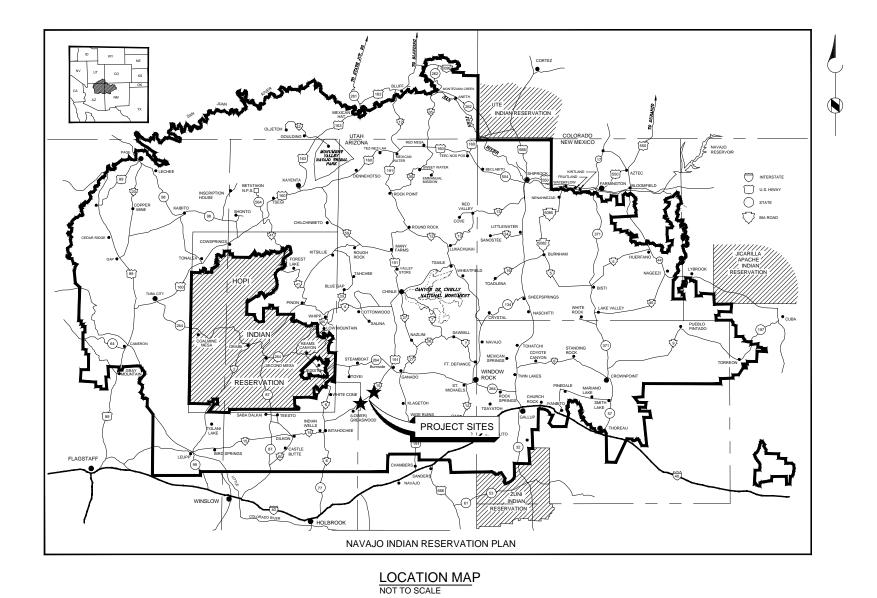




Call at least two full working days before you begin excavation.

Arizona Bine State, Inc.

Dial 8-1-1 or 1-800-STAKE-IT (782-5348) In Maricopa County: (602) 263-1100

				LINE IS	2 INCHES	EXTERNAL REFERENCE FILES	
	Brown AND Caldw	rell			JLL SIZE LE ACCORDINGLY)		
				SCALE:	NONE		
	SALT LAKE CITY, UTAH	ł		DECICNED.	MK		B
	01. 10			DESIGNED:	IVIN		-
SUBMITTED	: Durly	DATE:	6/2/17	DRAWN:	DD		
	PROJECT MANAGER	_		CHECKED:	MAF		
A DDDOVED	. WAH	DATE:	6/2/17		N#/		

BID ISSUE

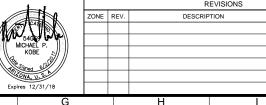





LOWER GREASEWOOD WATER SYSTEM IMPROVEMENTS DRAWINGS FOR CORNFIELDS PARALLEL AND LOWER GREASEWOOD INTERCONNECTION PIPELINES GENERAL

COVER SHEET

PIPE_G-001.dwg
BC PROJECT NUMBER
143956

DRAWING NUMBER
G-001

ECTRONIC CORV OF FINAL DOCUMENT, SEALED ORIGINAL DOCUMENT ON FILE AT REQUINAMENT AND CALDWELL MIDVALE LITA

ABCDEFGHIJKLMNOP

DRAWING INDEX

DRAWING IN	IDEX	
SHEET NUMBER	DRAWING NUMBER	DESCRIPTION
GENERAL		
1	G-001	COVER SHEET
2	G-002	INDEX OF DRAWINGS AND VICINITY MAP
SURVEY		
3	V-001	RESULTS OF SURVEY LGW WATER SYSTEM IMPROVEMENT
CIVIL		
4	C-001	GENERAL CIVIL NOTES AND SYMBOLS
5	C-002	MISCELLANEOUS DETAILS
6	C-003	PIPE CONNECTION DETAILS - 1
7	C-004	PIPE CONNECTION DETAILS - 2
8	C-100	KEY PLAN
9	C-101	STA 0+00 TO STA 2+30 PLAN AND PROFILE
10	C-102	STA 1000+00 TO STA 1010+00 PLAN AND PROFILE
11	C-103	STA 1010+00 TO STA 1020+00 PLAN AND PROFILE
12	C-104	STA 1020+00 TO STA 1030+00 PLAN AND PROFILE
13	C-105	STA 1030+00 TO STA 1040+00 PLAN AND PROFILE
14	C-106	STA 1040+00 TO STA 1050+00 PLAN AND PROFILE
15	C-107	STA 1050+00 TO STA 1060+00 PLAN AND PROFILE
16	C-108	STA 1060+00 TO STA 1070+00 PLAN AND PROFILE
17	C-109	STA 1070+00 TO STA 1080+00 PLAN AND PROFILE
18	C-110	STA 2000+00 TO STA 2010+00 PLAN AND PROFILE
19	C-111	STA 2010+00 TO STA 2020+00 PLAN AND PROFILE
20	C-112	STA 2020+00 TO STA 2030+00 PLAN AND PROFILE
21	C-113	STA 2030+00 TO STA 2040+00 PLAN AND PROFILE
22	C-114	STA 2040+00 TO STA 2050+00 PLAN AND PROFILE
23	C-115	STA 2050+00 TO STA 2060+00 PLAN AND PROFILE
24	C-116	STA 2060+00 TO STA 2070+00 PLAN AND PROFILE
25	C-117	STA 2070+00 TO STA 2080+00 PLAN AND PROFILE
26	C-118	STA 2080+00 TO STA 2090+00 PLAN AND PROFILE
27	C-119	STA 2090+00 TO STA 2100+00 PLAN AND PROFILE
28	C-120	STA 2100+00 TO STA 2110+00 PLAN AND PROFILE
29	C-121	STA 2110+00 TO STA 2120+00 PLAN AND PROFILE
30	C-122	STA 2120+00 TO STA 2130+00 PLAN AND PROFILE
31	C-123	STA 2130+00 TO STA 2140+00 PLAN AND PROFILE
32	C-124	STA 3000+00 TO STA 3007+00 PLAN AND PROFILE
33	C-125	STA 3007+00 TO STA 3017+00 PLAN AND PROFILE
34	C-126	STA 3017+00 TO STA 3020+00 PLAN AND PROFILE
35	C-127	CORNFIELDS EAST TANK SITE PLAN

CORNFIELDS PRV SITE PLAN

RECORD DRAWINGS (REFERENCE)

W-35

W-36

W-39

W-39

W-40

SHT NO 30 TANK SITE NO. 2 DETAILS (NOT A CONTRACT DOCUMENT)

ROAD CROSSINGS

STRAW BALES

MARKER POST DETAIL SILT FENCE (DRAWING 1 OF 2)

SILT FENCE (DRAWING 2 OF 2)

IHS STANDARD DETAILS (REFERENCE) W-1 FLUSH VALVE 2-INCH W-2 AIR RELEASE VALVE W-3 WATER SERVICE LINE 1" URBAN W-3A WATER SERVICE LINE 1" URBAN W-4 WATER SERVICE LINE 1" URBAN W-4A WATER SERVICE LINE 1" URBAN W-7 3/4" x 2" x 2" PRESSURE REDUCING VAULT W-11 CONCRETE THRUST BLOCK W-12 2" x 4" PRESSURE REDUCING VALVE W-13 GAS/OIL LINE CROSSING GATE VALVE INSTALLATION W-16 W-24 INSTALLATION OF PVC PIPE IN CASING W-27 TYPICAL TRENCH DETAIL W-28 ALTITUDE VALVE VAULT W-33 HDPE WASH CROSSING

Steamboat Canyon

CORNFIELDS

STEAMBOAT CANYON

CORNFIELDS

CORNFI

VICINITY MAP

Call at least two full working days before you begin excavation.

ARTONASI

Arizona Blue Stake, Inc.

Dial 8-1-1 or 1-800-STAKE-IT (782-5348) In Maricopa County: (602) 263-1100

Brown AND Caldwell

SALT LAKE CITY, UTAH

DESIGNED: MK

DRAWN: DD

CHECKED: MAF

APPROVED: MK

DATE: ____6/2/17

C-128

MICHAEL KOBE

BID ISSUE

11	REVISIONS								
	ZONE	REV.	DESCRIP	TION		BY	DATE	APF	
FY (*************************									
540 9 W									
MICHAEL P. KOBE									
Signed 51210									
ONA, U.S.h									
ires 12/31/18									
G			Н	I				Е	





LOWER GREASEWOOD WATER SYSTEM IMPROVEMENTS
DRAWINGS FOR CORNFIELDS PARALLEL AND LOWER
GREASEWOOD INTERCONNECTION PIPELINES
GENERAL

INDEX OF DRAWINGS AND VICINITY MAP

FILENAME	
PIPE_G-002.dwg	
BC PROJECT NUMBER	
143956	

G-002
SHEET NUMBER
2 OF 36

ELECTRONIC COPY OF FINAL DOCUMENT; SEALED ORIGINAL DOCUMENT ON FILE AT BROWN AND CALDWELL, MIDVALE UTAH

S 86°44'43" E 2506.56' RTH W 2640.00' (R1,R2) SEC. 13 SEC. 18 T. 25 N., R. 23 E. T. 25 N., R. 24 E. G&S.R.M. P.O.T. STA. 957+84.86 N 89°55'00" W 2657.16' (R2) N 89°55'00" W 2640.00' (R2 N 89°53'23" E 2656.98' N 89°52'53" E 2640.04 SCALE: 1" = 600P.O.T. STA. 991+28.14 SEC. 24 SEC. 19 DETAIL "E" SCALE 1"=200 -S 35°01'34" W 366.17 N 89°53'47" E 2651.37' N 89°53'36" E 2651.24' DETAIL "F" SCALE 1"=200" SEC. 25 _N77°33'40" E 2389.12' -S 30°38'51" E 94.69' S 30°38'47" E 35.83'

RESULTS OF SURVEY

LOWER GREASEWOOD WATER SYSTEM IMPROVEMENT 9.68 ± ACRE

LOCATED IN SECTIONS 24 & 25, T. 25 N., R. 23 E., G.&S.R.M. AND SECTIONS 18 & 19, T. 25 N., R. 24 E., G.&S.R.M. **DISTRICT 17, NAVAJO NATION** GREASEWOOD, NAVAJO COUNTY, ARIZONA

A STRIP OF LAND 30 FEET WIDE SITUATED WITHIN SECTION 24 & 25, TOWNSHIP 25 NORTH, RANGE 23 EAST, GILA & SALT RIVER MERIDIAN, AND WITHIN SECTIONS 18 & 19, TOWNSHIP 25 NORTH, RANGE 24 EAST, G.&S.R.M., DISTRICT 17, NAVAJO NATION, IN GREASEWOOD, NAVAJO COUNTY, STATE OF ARIZONA, MORE PARTICULARLY DESCRIBED AS FOLLOWS:

COMMENCING AT THE WEST QUARTER CORNER OF SECTION 18 MARKED BY B.L.M. BRASS CAP, FROM WHICH THE SOUTHWEST CORNER OF SAID SECTION 18 LIES S 00°00'12" E, A DISTANCE OF 2640.08 FEET (BASIS OF BEARINGS, ARIZONA STATE PLANE EAST ZONE GRID BEARING)(NORTH, 2640.00 FEET PER B.L.M. SURVEY PLAT 1114-2, DATED NOVEMBER 12, 2004, R2); THENCE S 86°44'43" E, A DISTANCE OF 2506.56 FEET TO THE POINT OF BEGINNING OF THE HEREIN DESCRIBED CENTERLINE; THENCE S 33°10'52" W, A DISTANCE OF 2715.31 FEET;

THENCE S 33°11'08" W, A DISTANCE OF 1646.34 FEET THENCE S 33°11'00" W, A DISTANCE OF 1696.51 FEET

THENCE S 33°11'05" W, A DISTANCE OF 2655.54 FEET; THENCE S 33°11'05" W, A DISTANCE OF 372.40 FEET;

THENCE S 35°01'34" W, A DISTANCE OF 366.17 FEET; THENCE S 35°01'34" W, A DISTANCE OF 826.25 FEET;

THENCE S 35°01'09" W, A DISTANCE OF 1610.34 FEET

THENCE S 63°11'36" F. A DISTANCE OF 1976.23 FEET

THENCE S 30°38'51" E, A DISTANCE OF 94.69 FEET

THENCE S 58°40'17" W. A DISTANCE OF 56.12 FEET:

THENCE S 30°38'47" E, A DISTANCE OF 35.83 FEET TO THE POINT OF TERMINUS OF SAID CENTERLINE.

THE SIDE LINES OF SAID 30 FOOT WIDE EASEMENT LYING 15 FEET ON EACH SIDE OF CENTERLINE TO BE EXTENDED OR SHORTENED TO MEET AT ANGLE POINTS AND TO TERMINATE AT THE CENTERLINE OF EXISTING WATER LINE.

SAID PARCEL BEING 9.68 ACRES MORE OR LESS AND BEING SUBJECT TO ANY AND ALL EXISTING EASEMENTS FOR UTILITIES LOCATED THEREIN.

EXHIBIT "A"

■ - FOUND 3" BRASS CAP, B.L.M. SECTION CORNER

● FOUND 3" BRASS CAP, B.L.M. 1/4 CORNER

△ - FOUND 3" BRASS CAP, B.L.M. REFERENCE MARKER → FOUND 3" BRASS CAP, B.I.A RIGHT-OF-WAY

O - CALCULATED POINT, NOTHING FOUND OR SET

REFERENCES: (R1) BUREAU OF LAND MANAGEMENT SURVEY PLAT 1114-1, DATED MARCH 30, 2004.

(R2) BUREAU OF LAND MANAGEMENT SURVEY PLAT 1114-2, DATED NOVEMBER 12, 2004.
(R3) CONSTRUCTION PLANS, N15(3)2&4 SUNRISE SPRINGS TO GREASEWOOD, BUREAU OF INDIAN AFFAIRS, DIVISION OF TRANSPORTATION, DATED SEPTEMBER 22, 1964.
(R4) STATE PLANE COORDINATES PER NATIONAL GEODETIC SURVEY, O.P.U.S. PROCESSED GPS DATA.

BASIS OF BEARINGS:
THE WEST SECTION LINE OF SECTION 18, T. 25 N., R. 24 E., WITH ARIZONA STATE PLANE COORDINATE EAST ZONE GRID BEARING OF S 00°12'00" E AND A B.L.M. BEARING OF NORTH PER B.L.M. PLAT 1114-2.

CERTIFICATION:
THIS IS TO CERTIFY THAT THE SURVEY DESCRIBED AND PLATTED HEREON WAS MADE UNDER MY DIRECTION DURING THE MONTHS OF MARCH & APRIL OF 2013 AND JANUARY OF 2014; THAT THE SURVEY IS TRUE AND COMPLETE AS SHOWN; THAT MONUMENTS SHOWN ACTUALLY EXIST OR WILL BE SET AS SHOWN; THAT THEIR POSITIONS ARE CORRECTLY SHOWN; AND THAT SAID MONUMENTS ARE SUFFICIENT TO ENABLE THE SURVEY TO BE RETRACED.

HALBERT O. GOLDTOOTH, AZ RLS 42048



DRAWING NUMBER V-001

GOLDTOOTH PRECISION SOLUTIONS, INC.


P O BOX 640 TUBA CITY. AZ 86045 Ph: (928)283-4652 Fax: (928)283-5073


Surveyed: March & April 2013 and January 1, 2014


File: 1311 Lower Greasewoood ROW.dv Drawn by: H.Goldtooth Checked by: H.Goldtooth


Revised: n/a Scale: 1" = 600' Sheet: 1 of 1




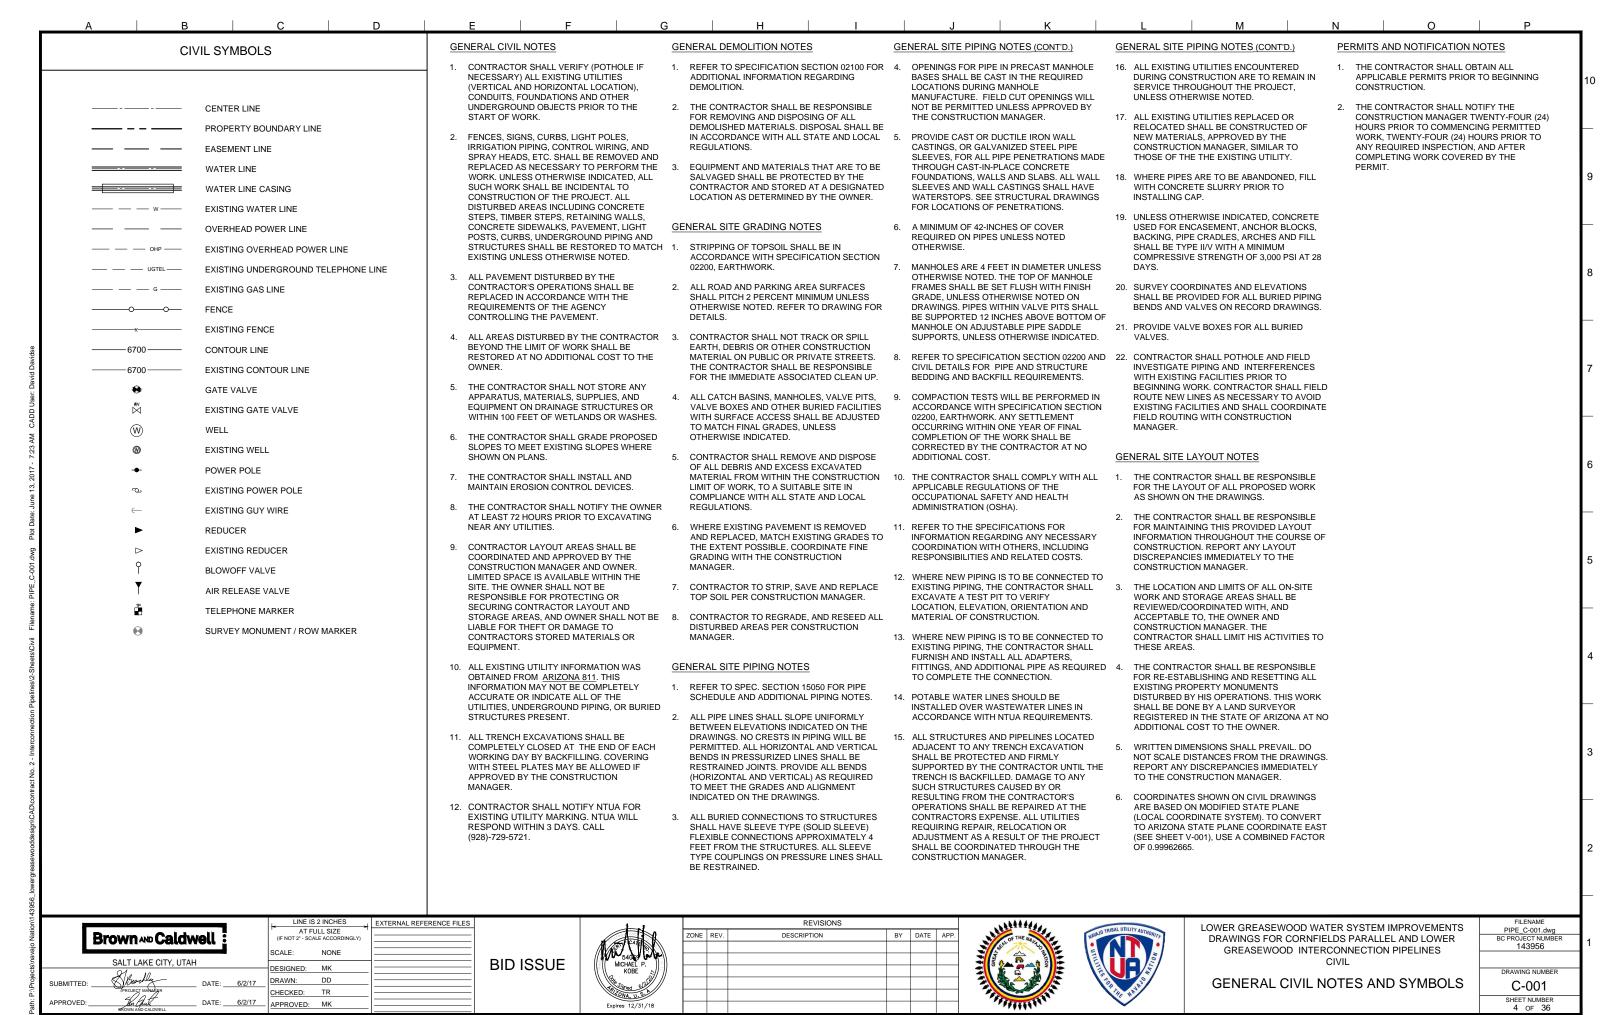


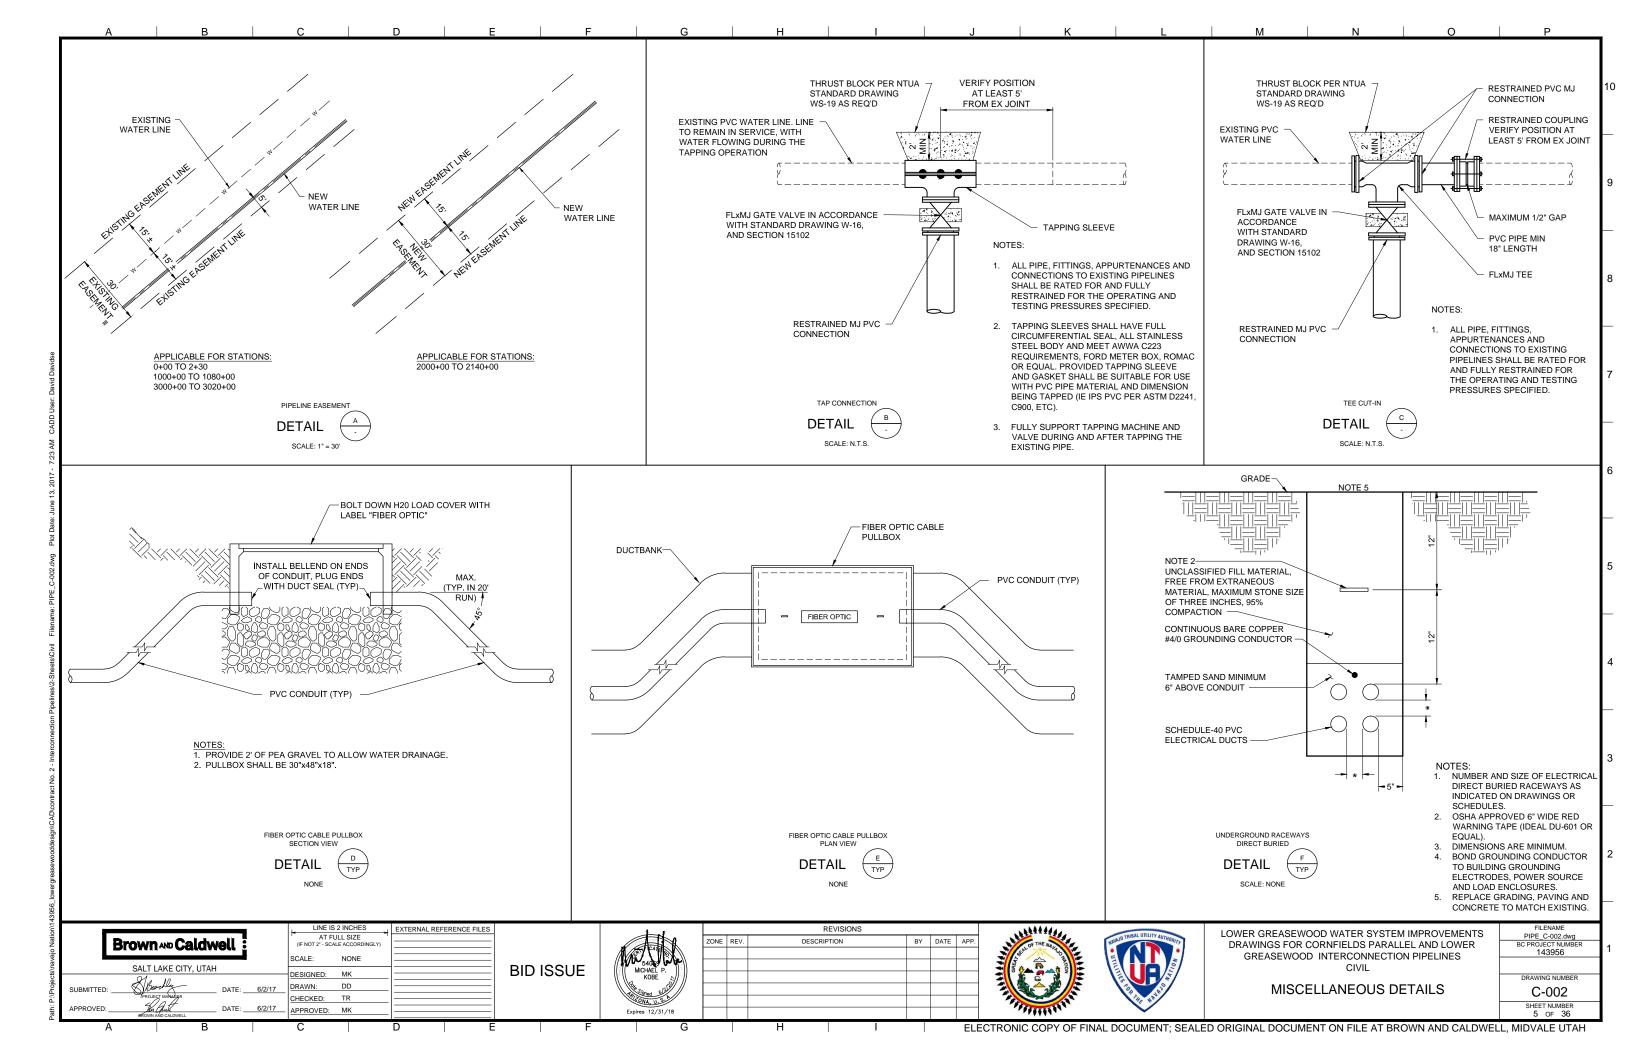


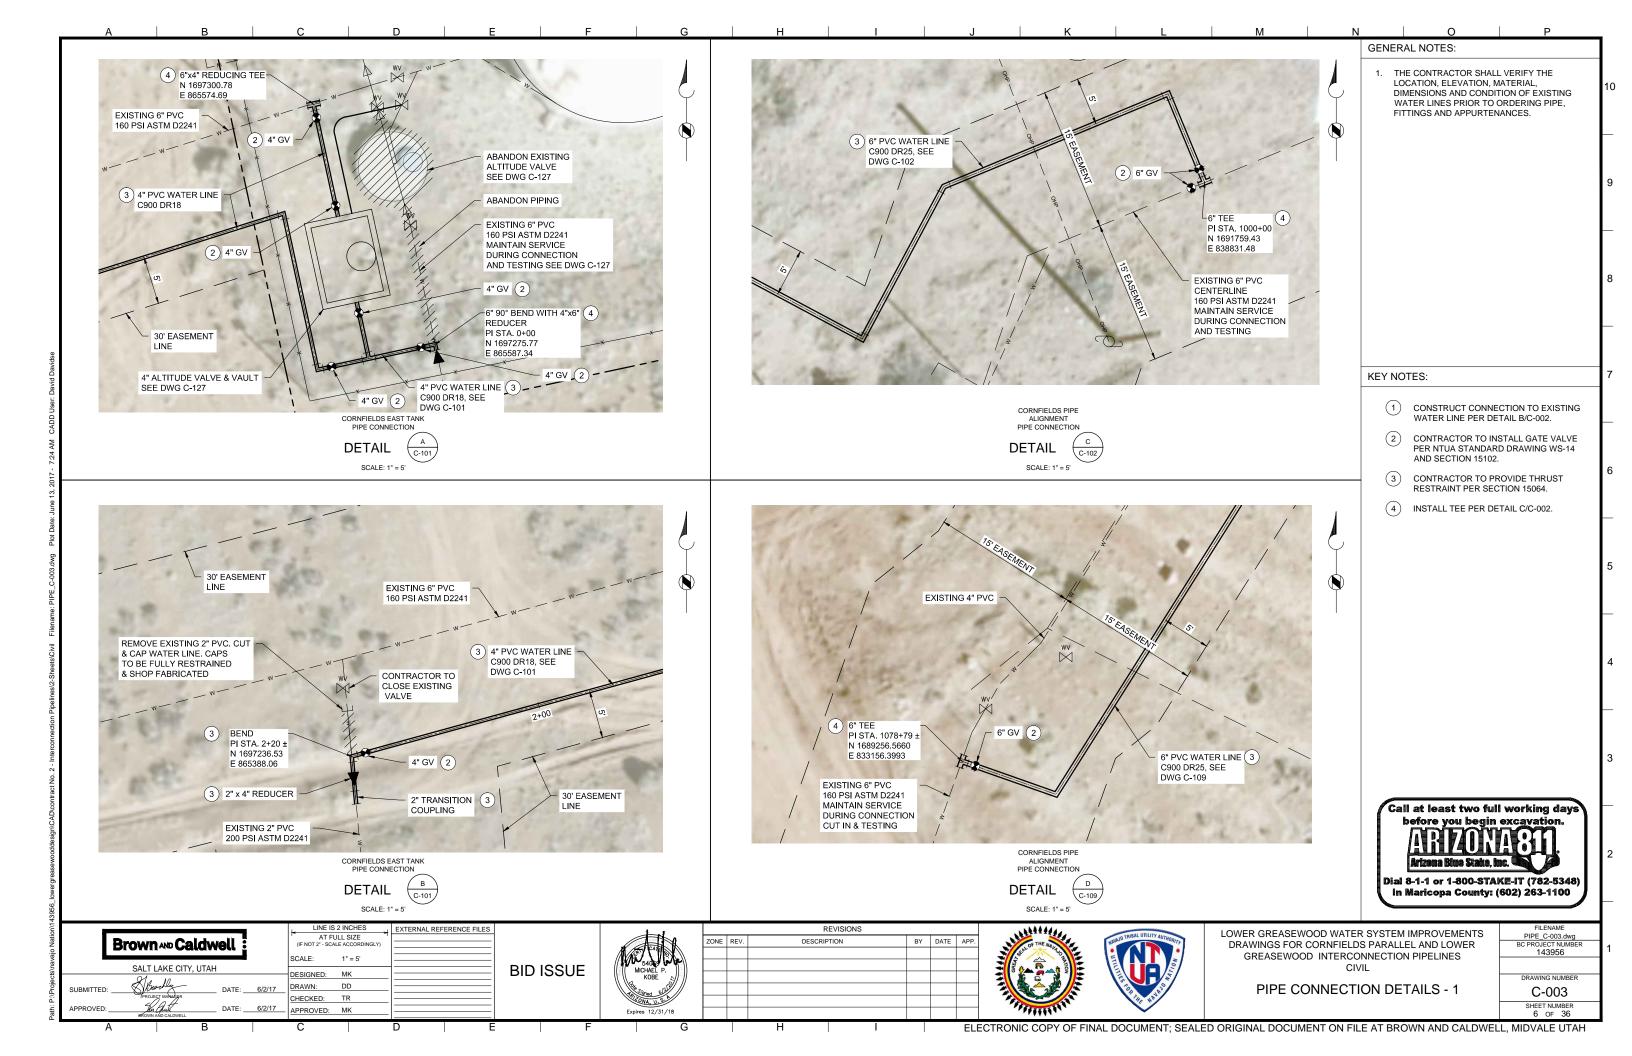


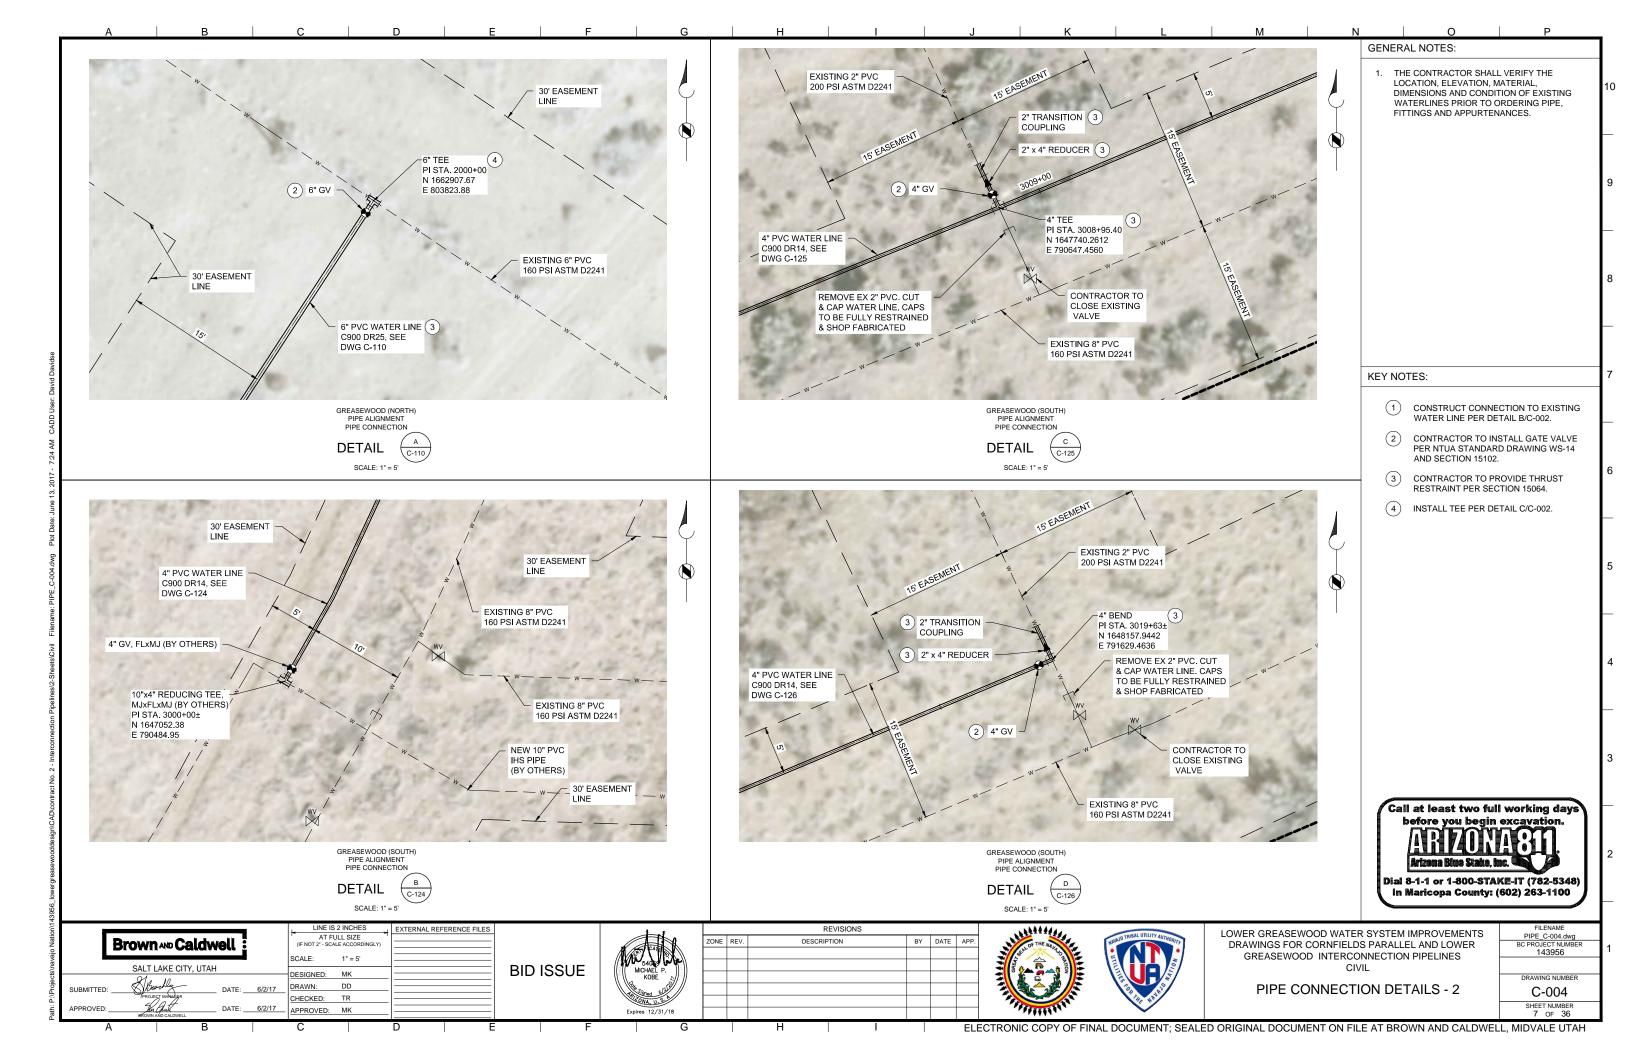


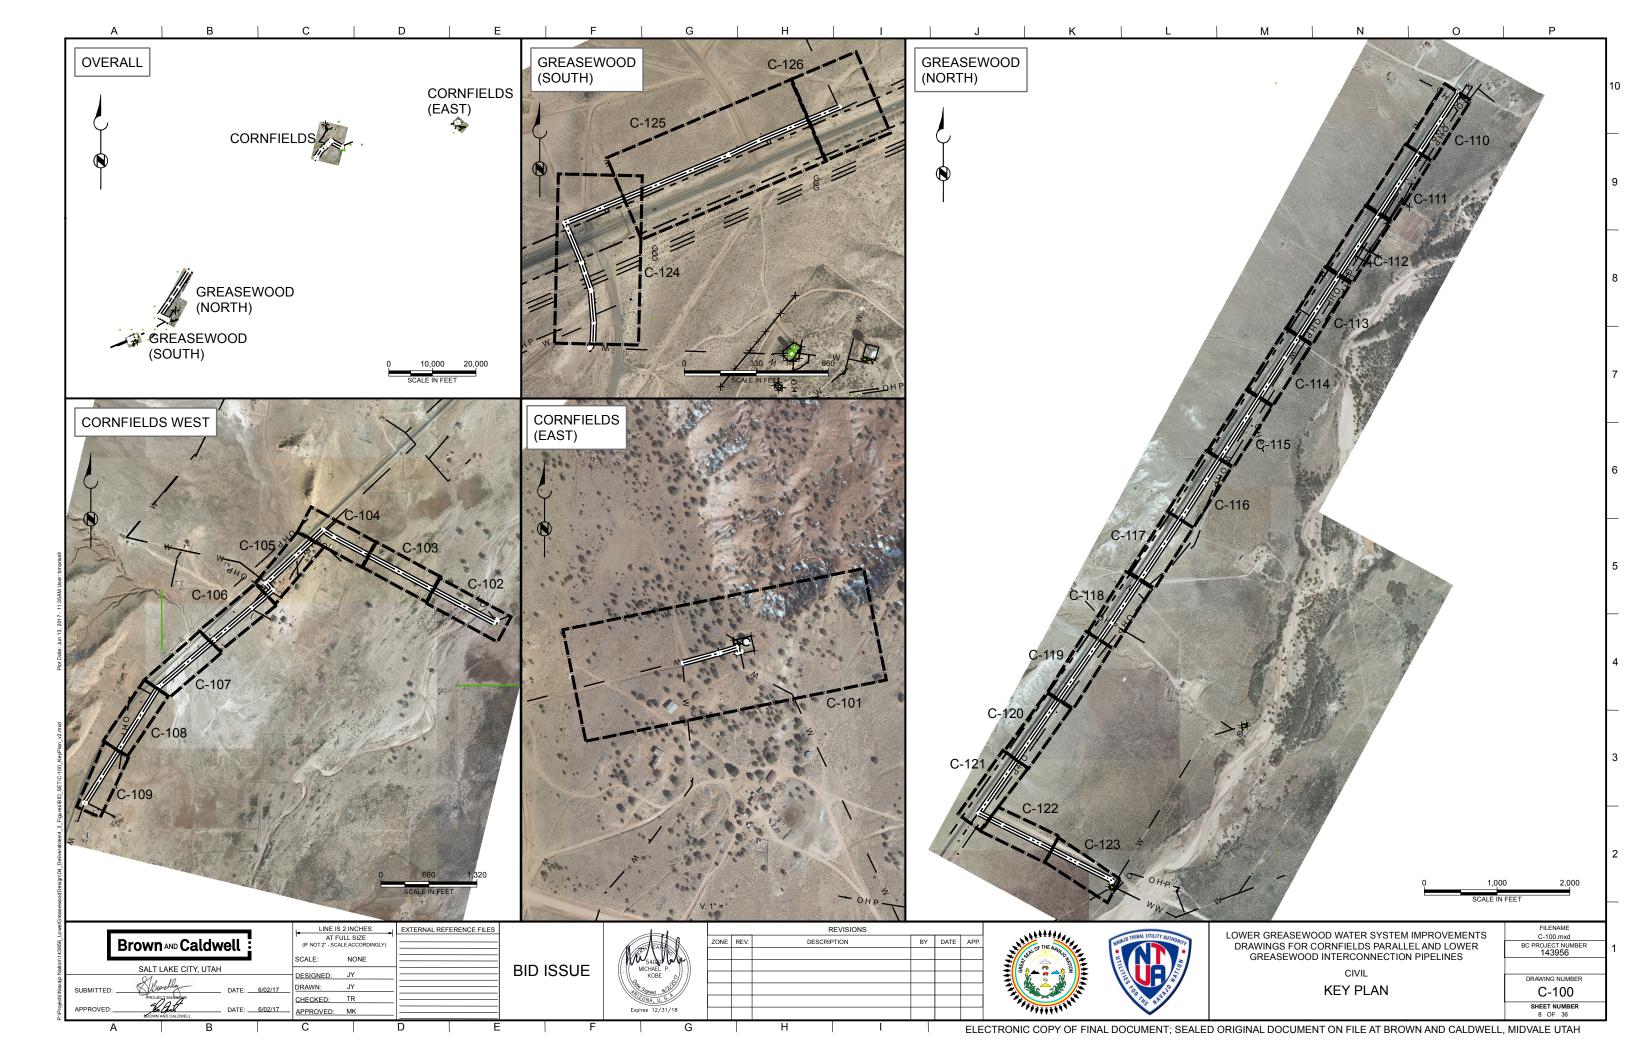


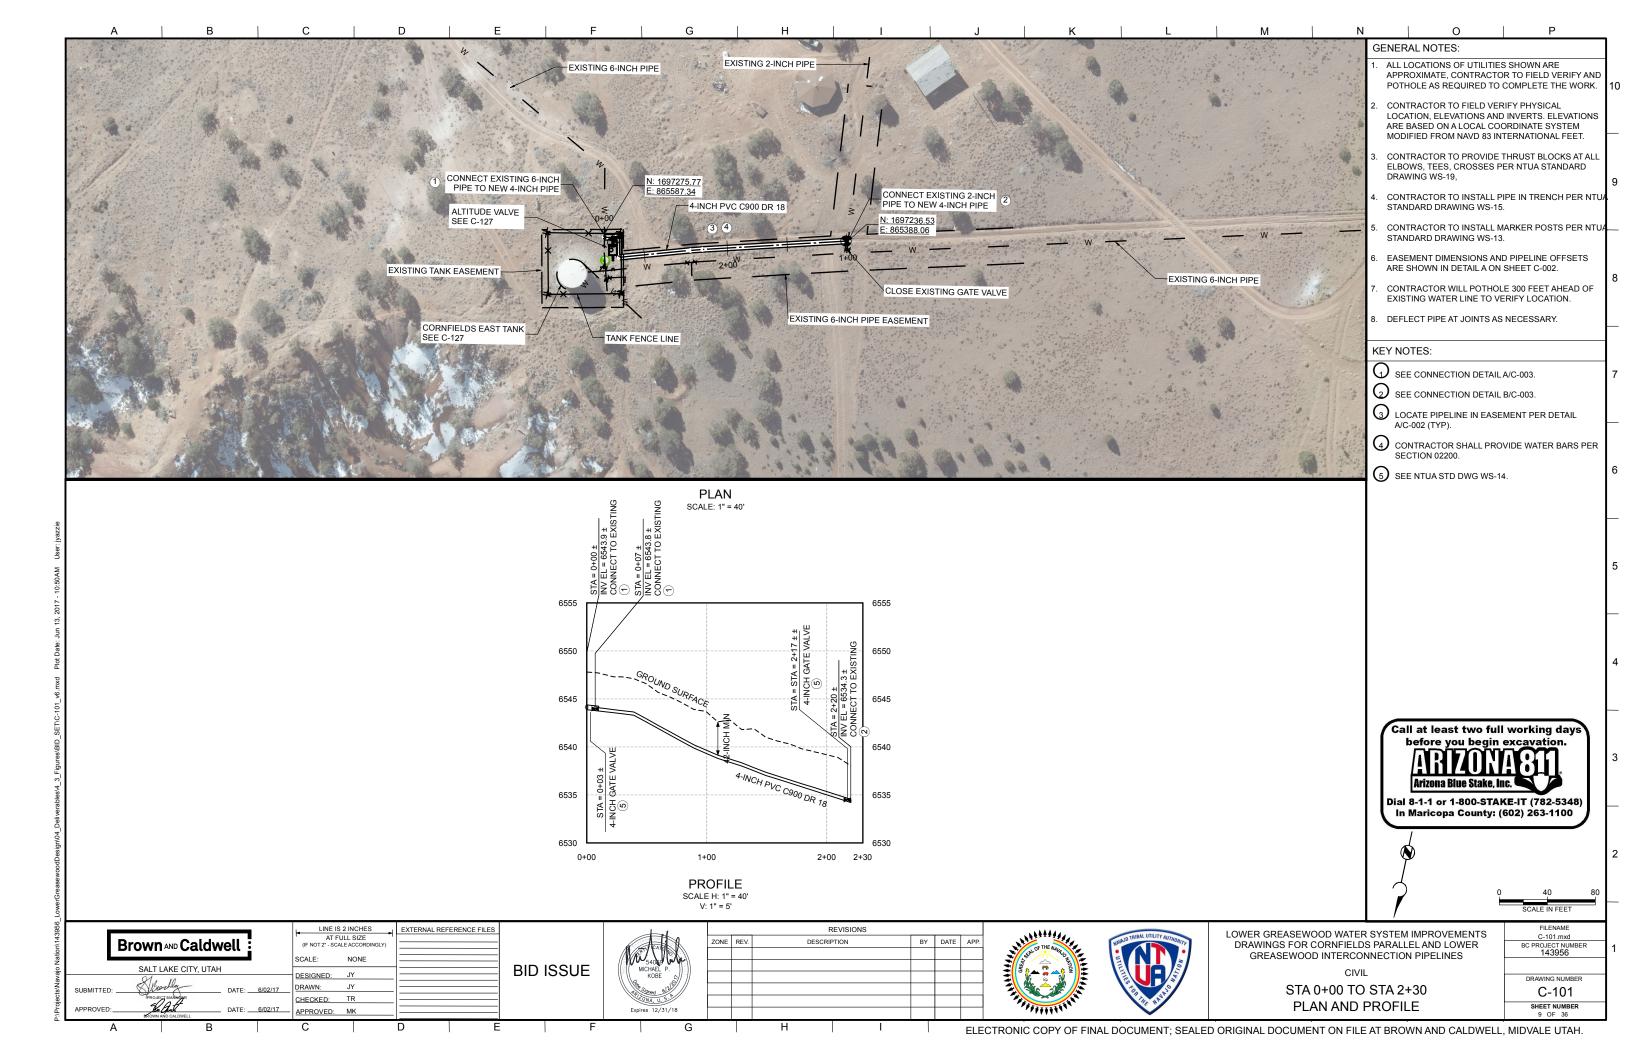


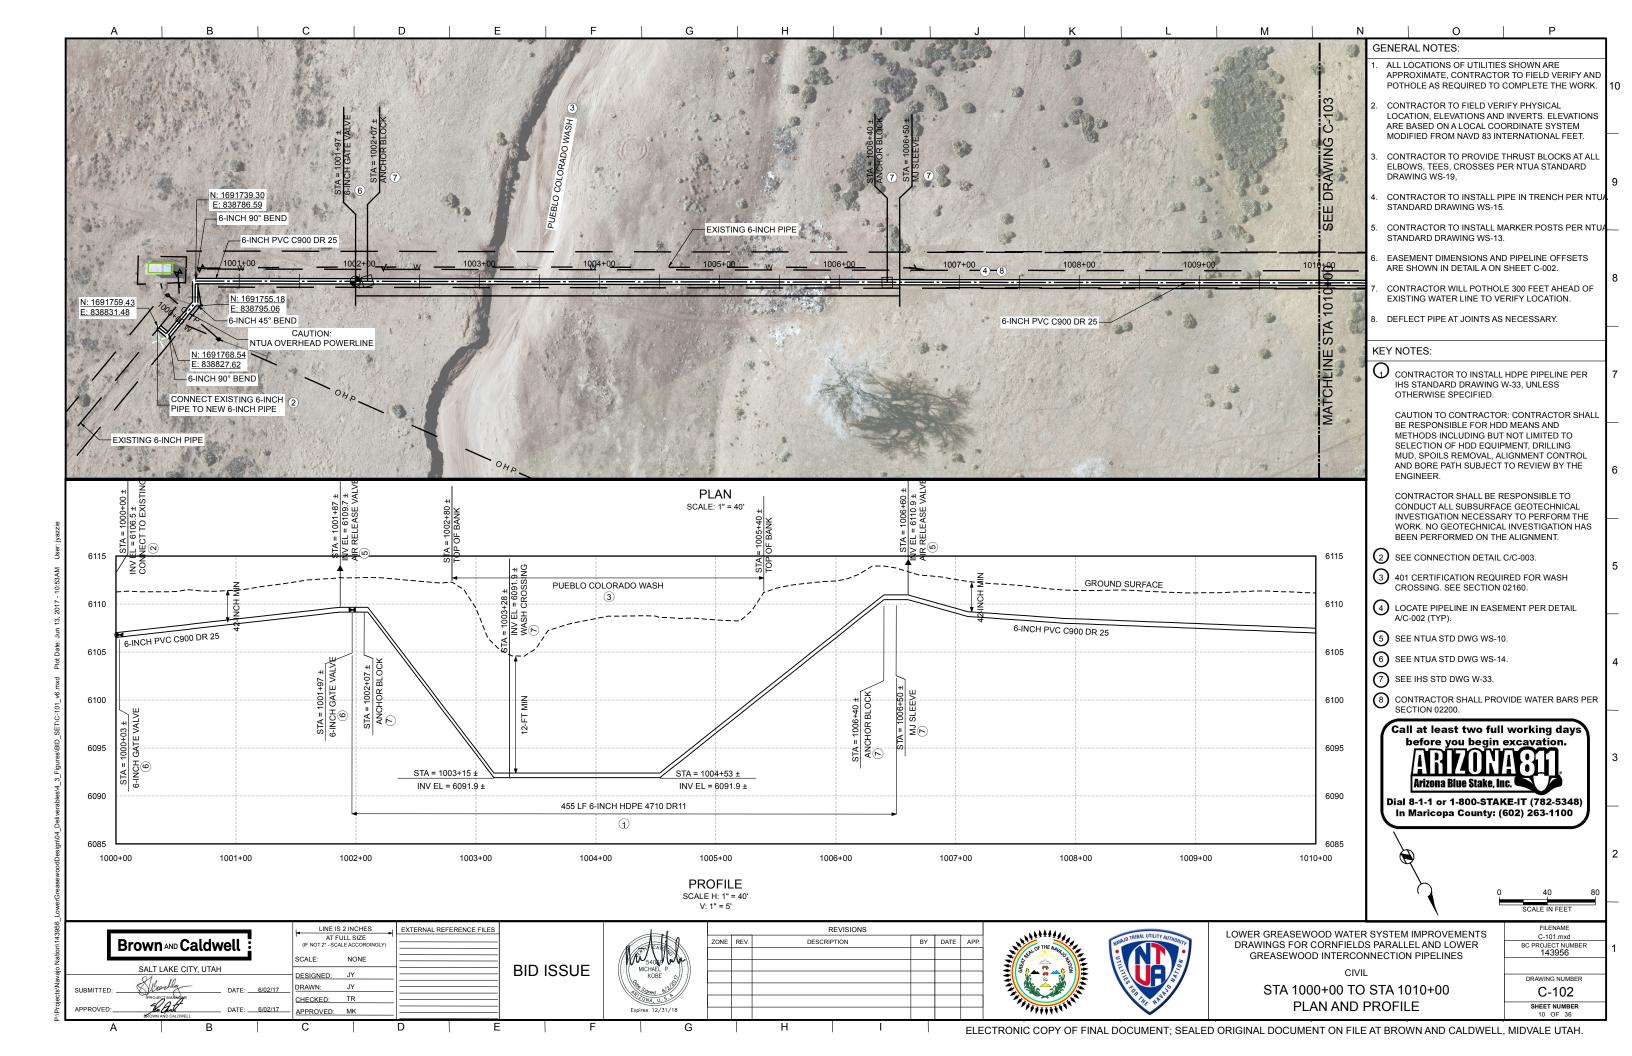


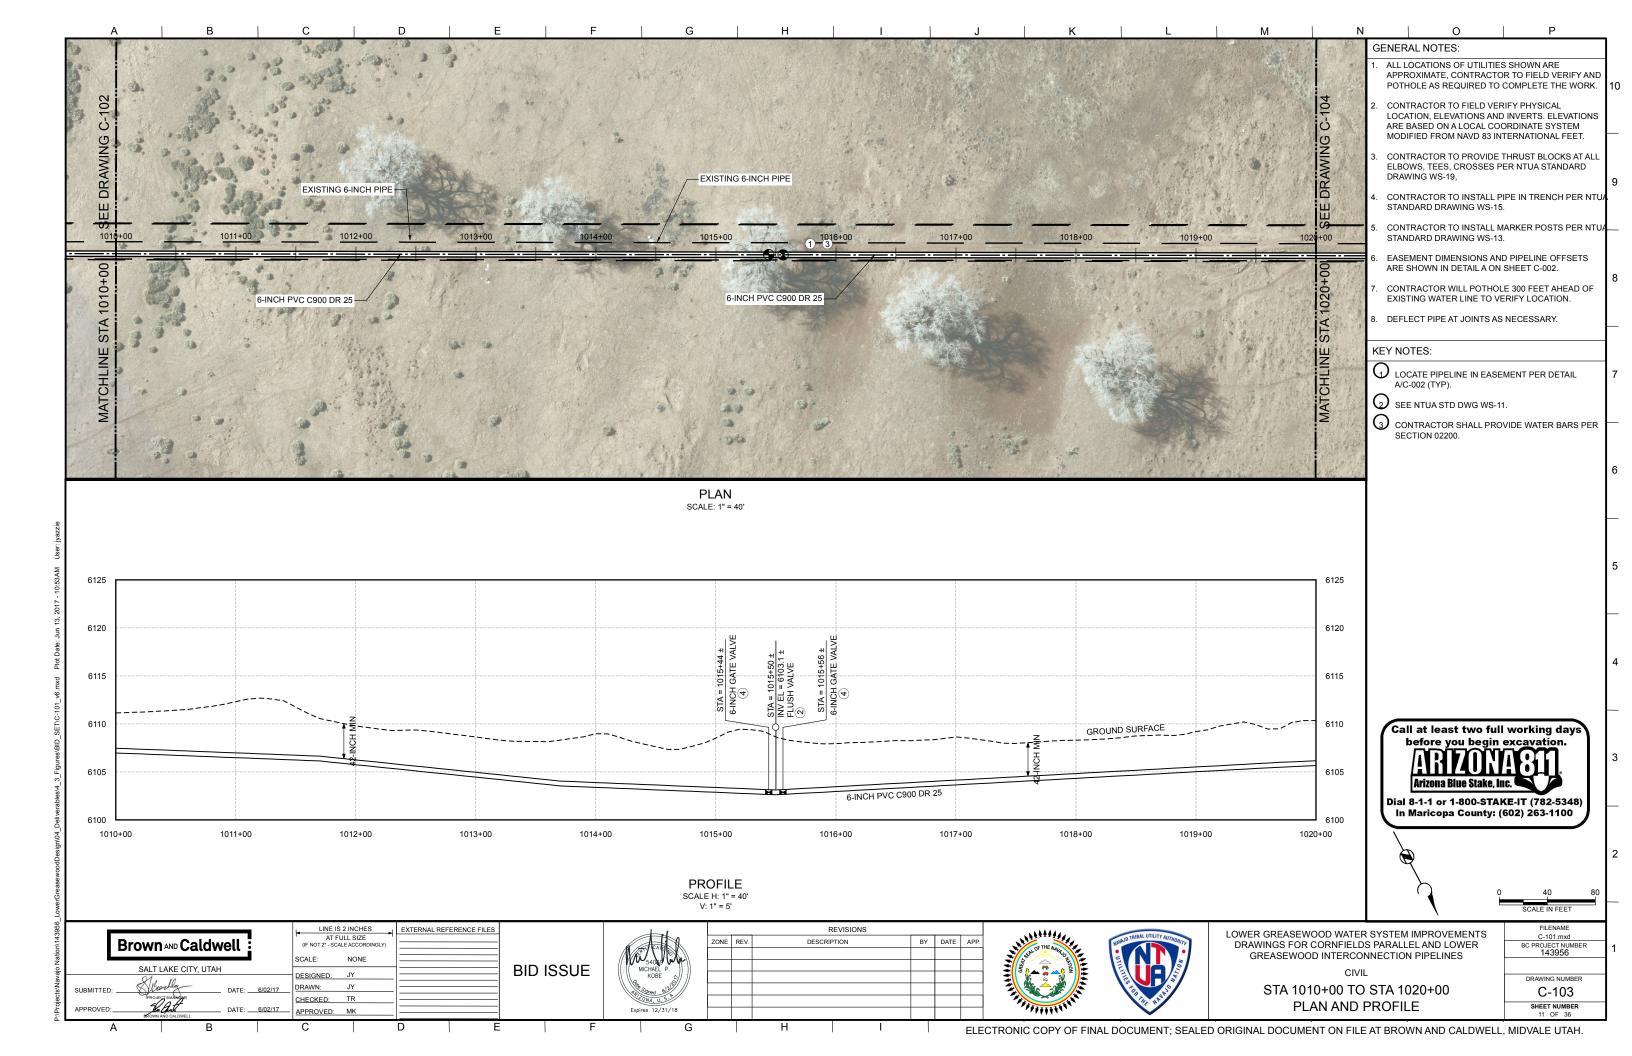


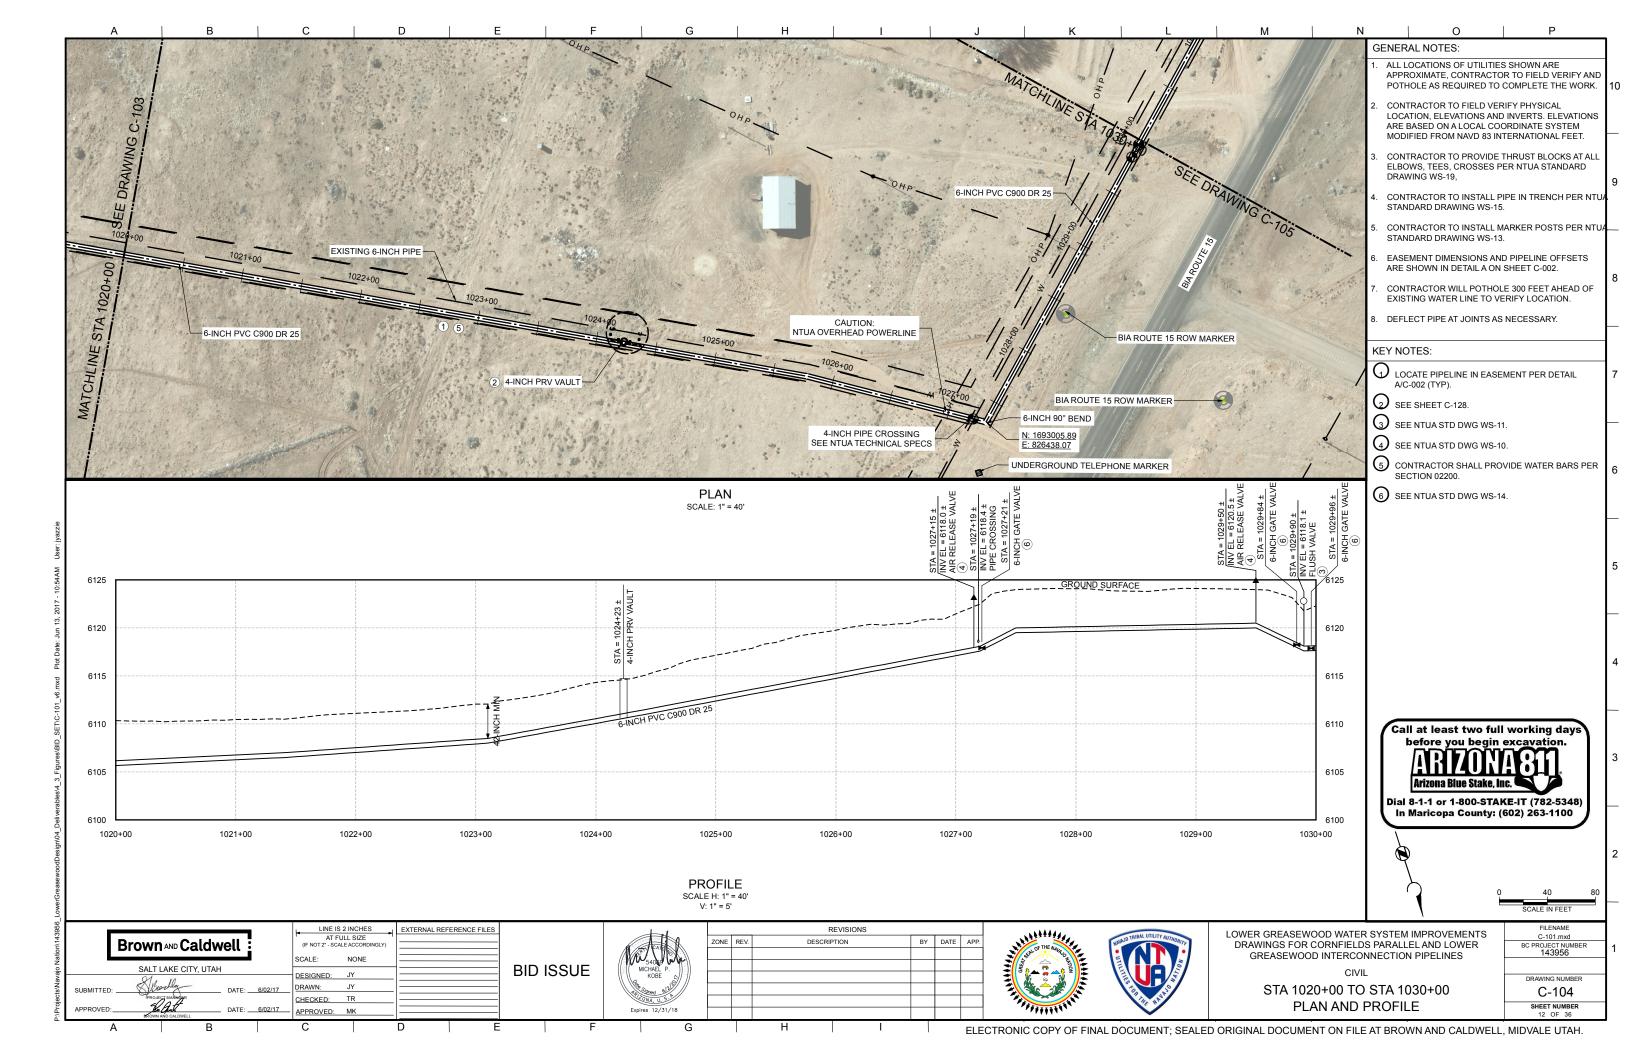


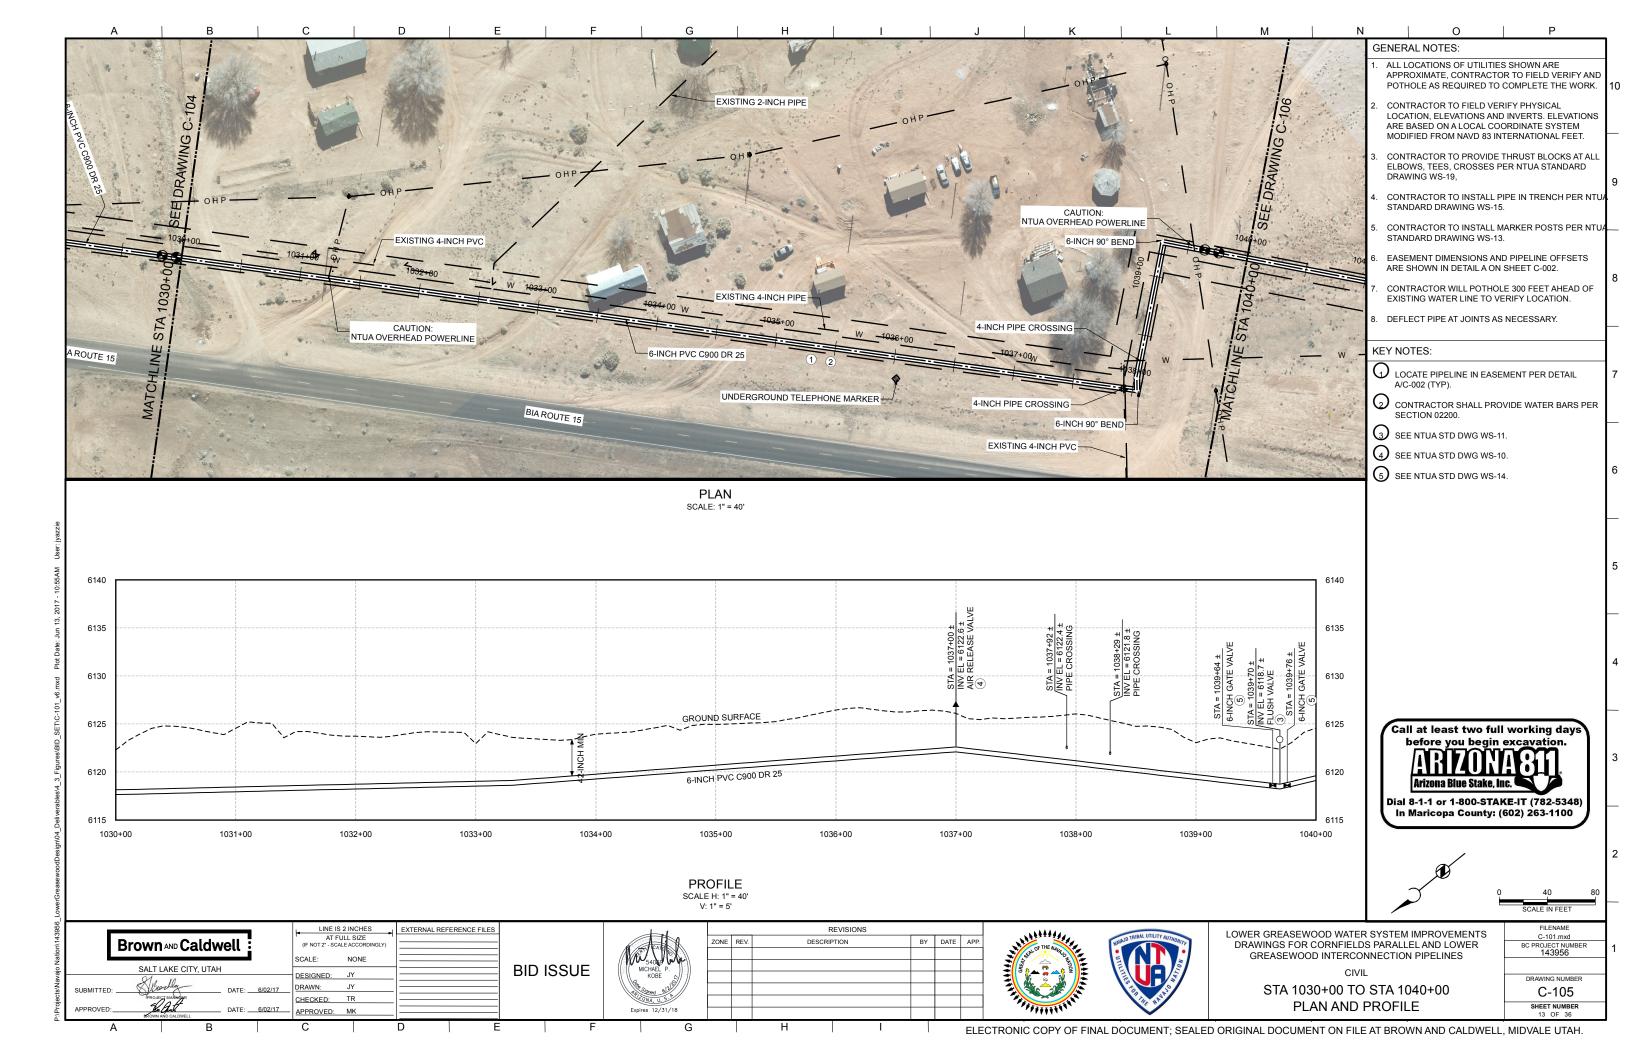


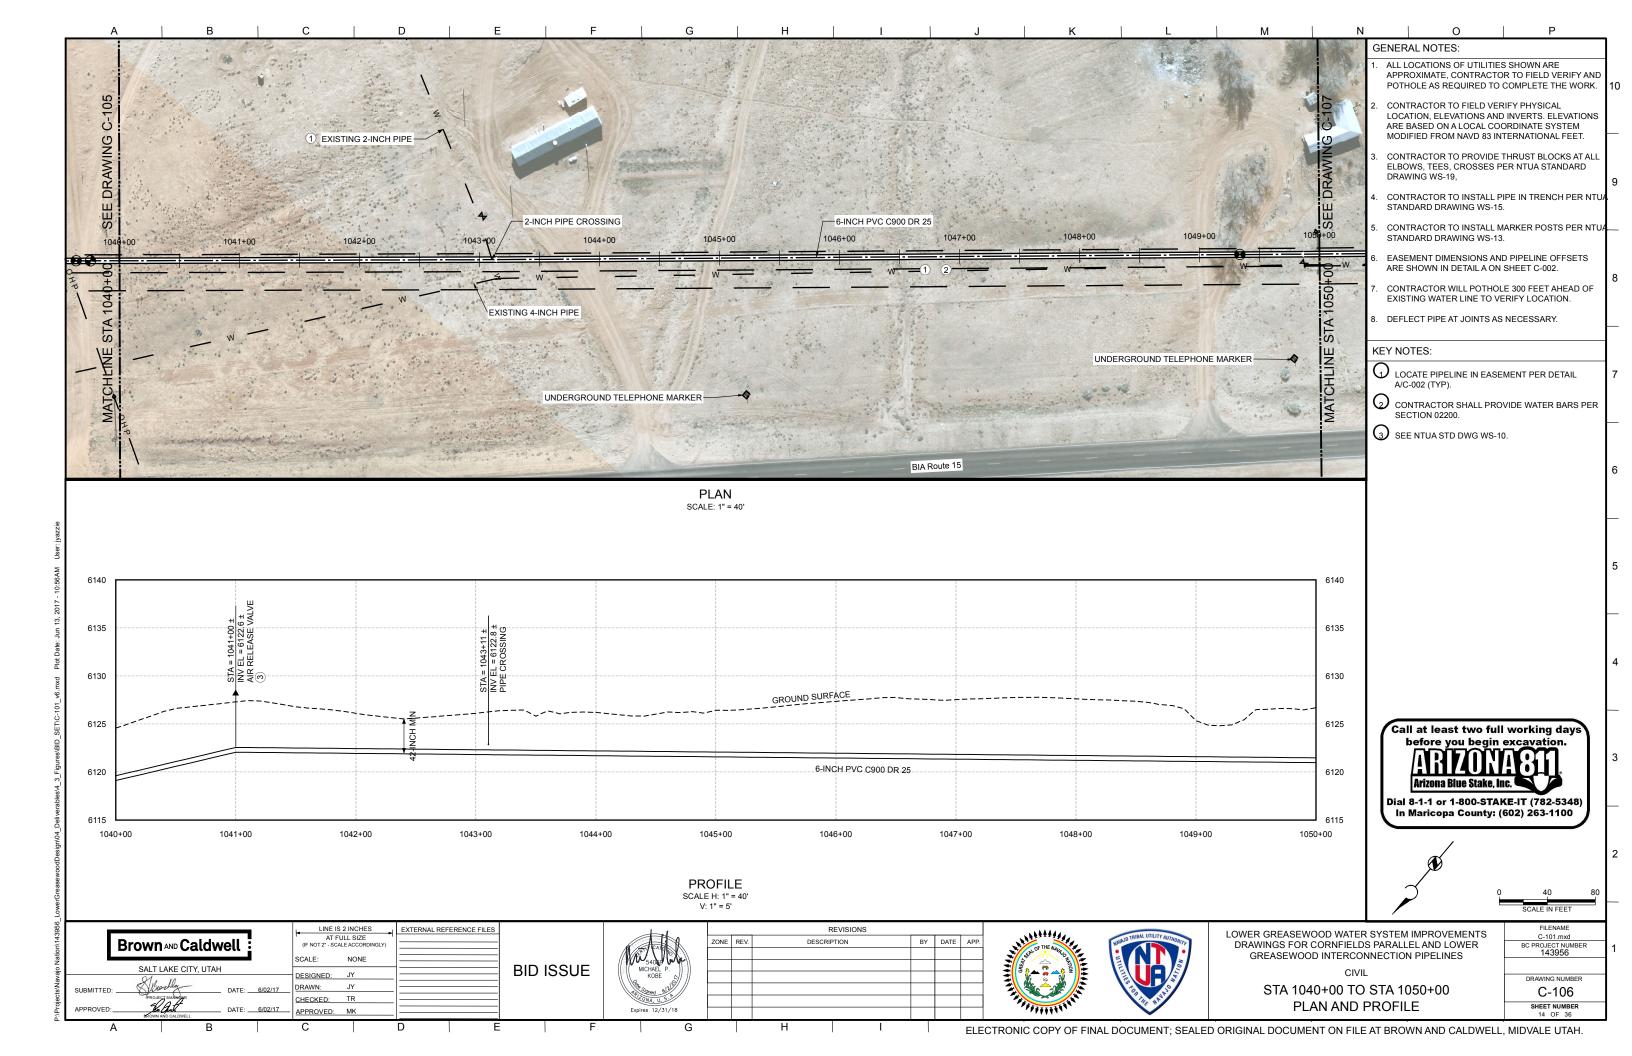


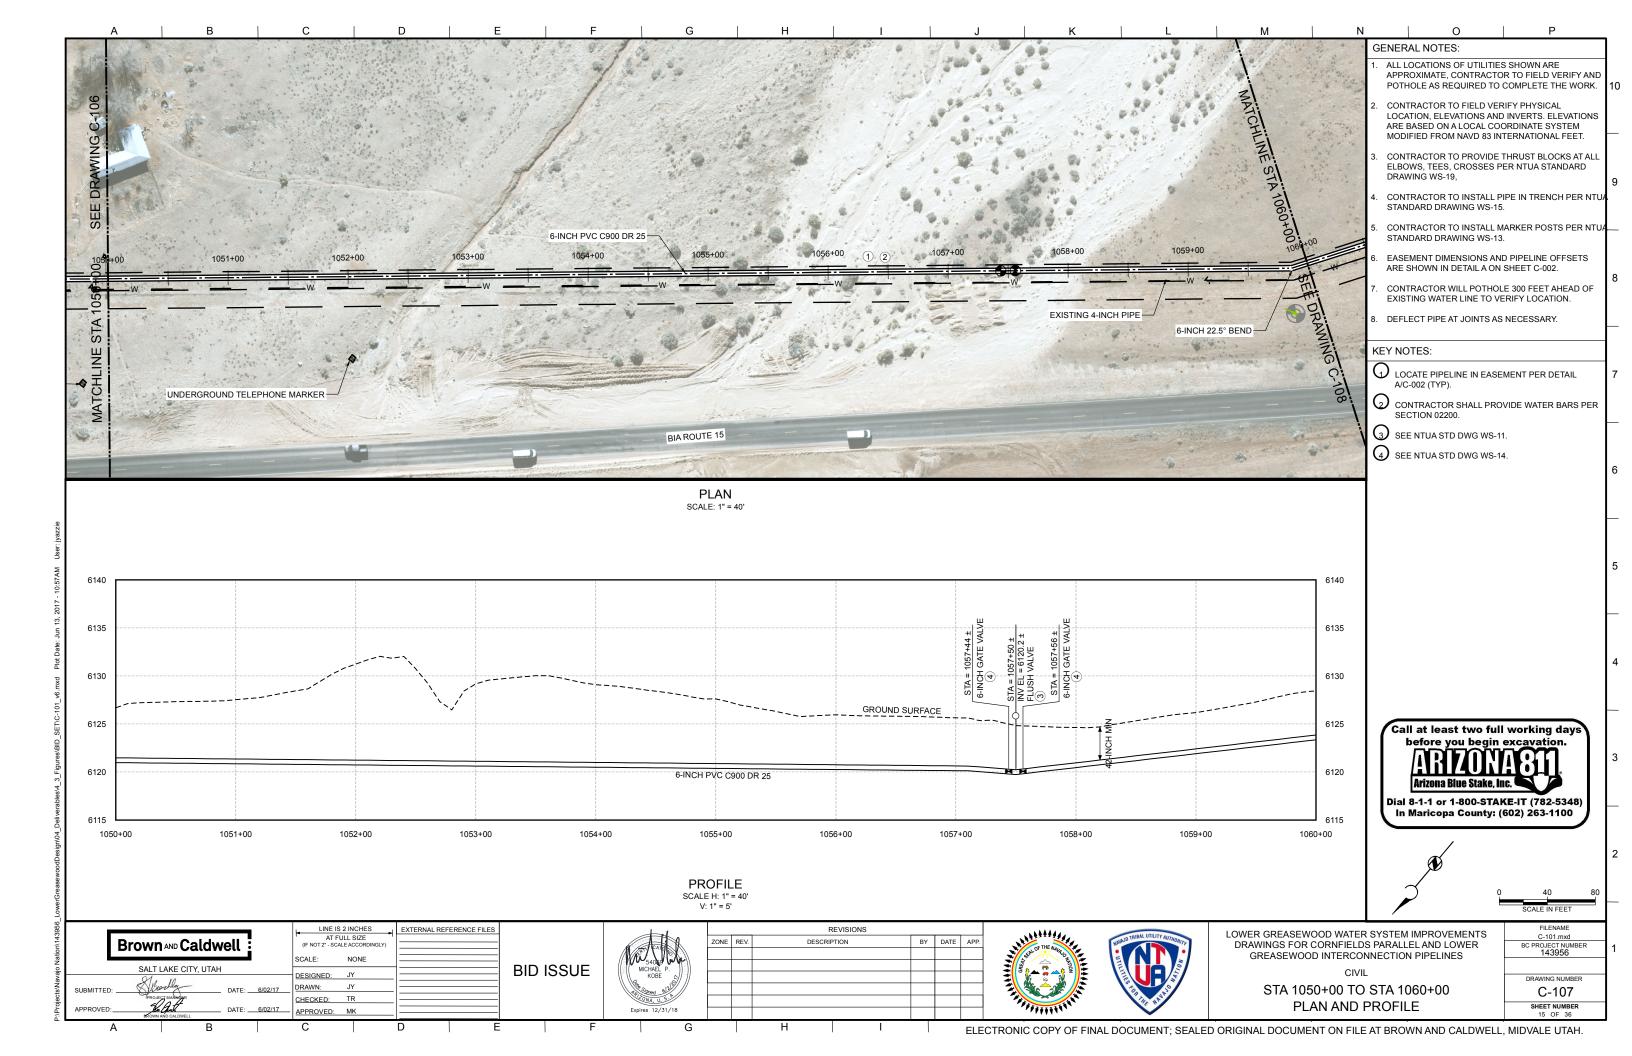


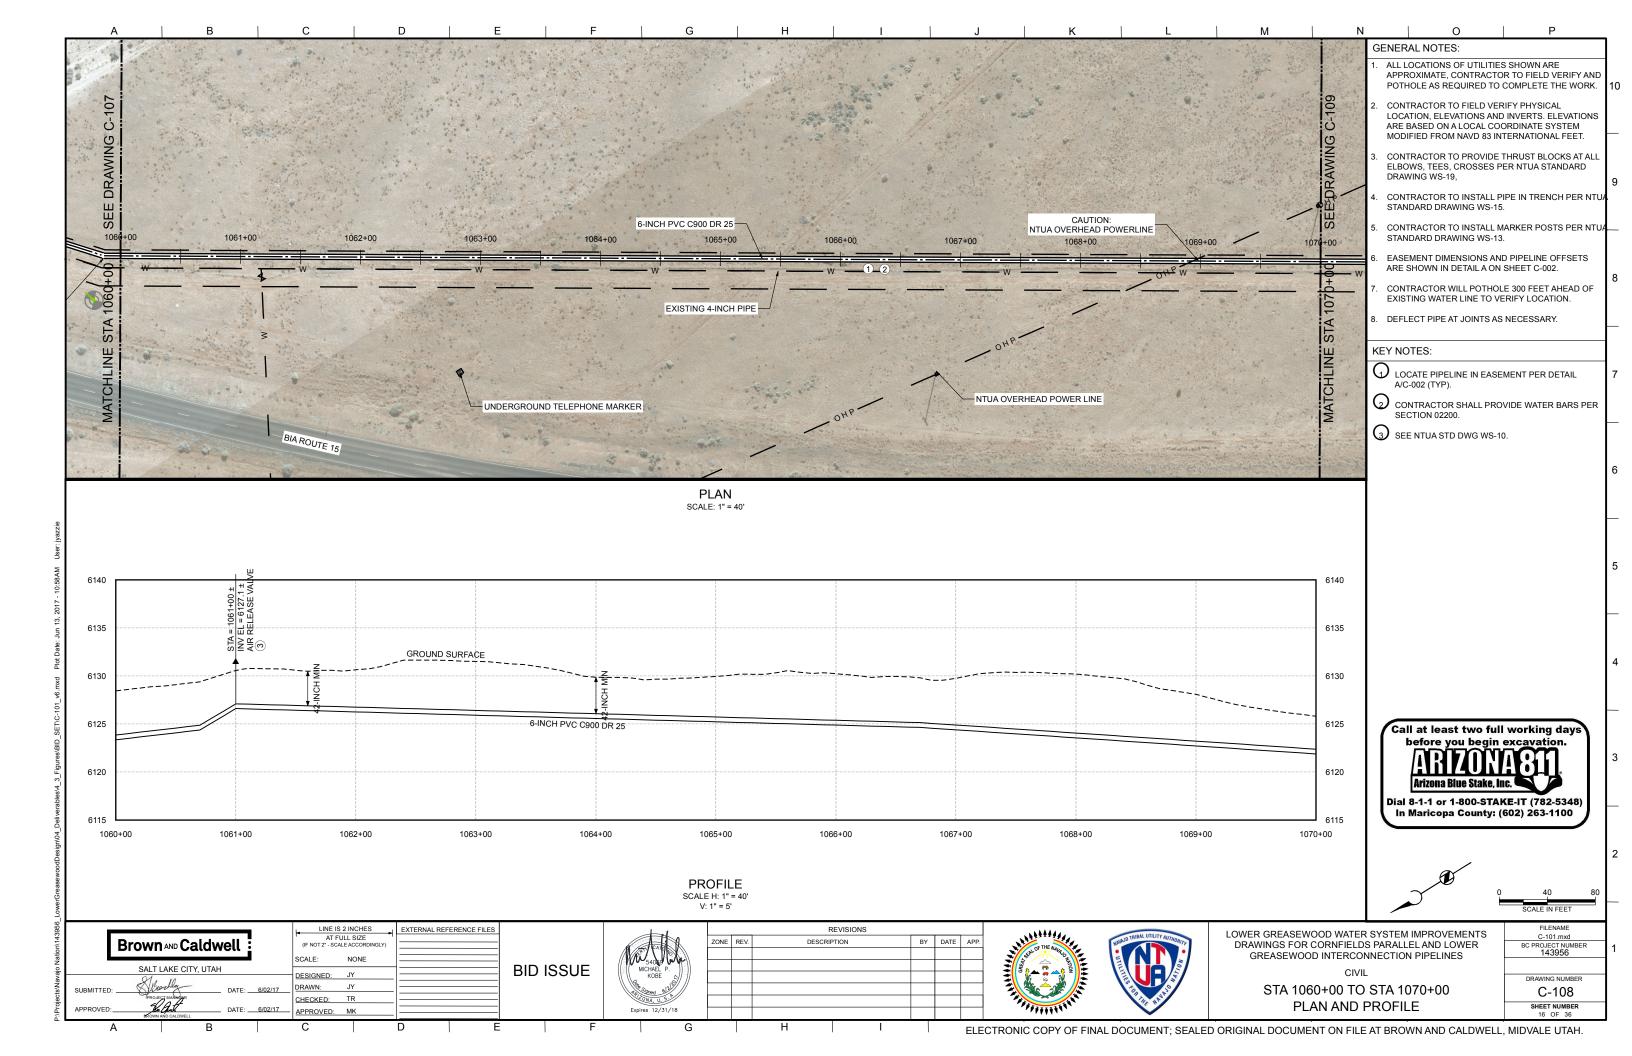


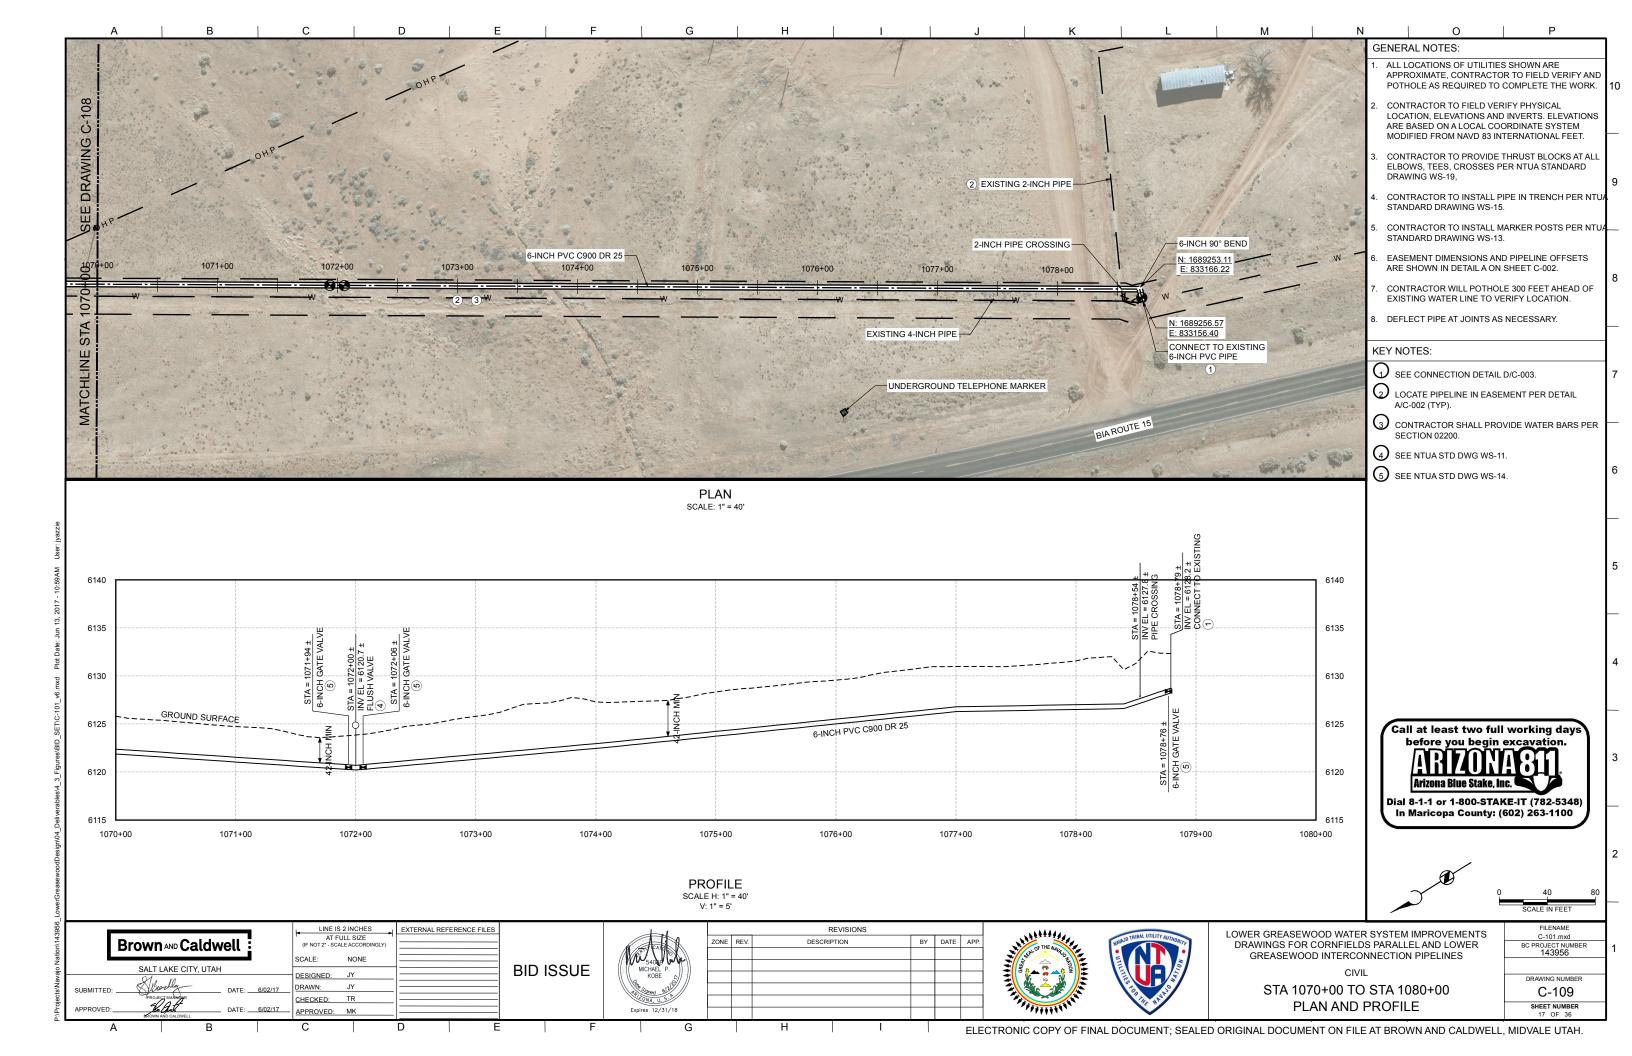


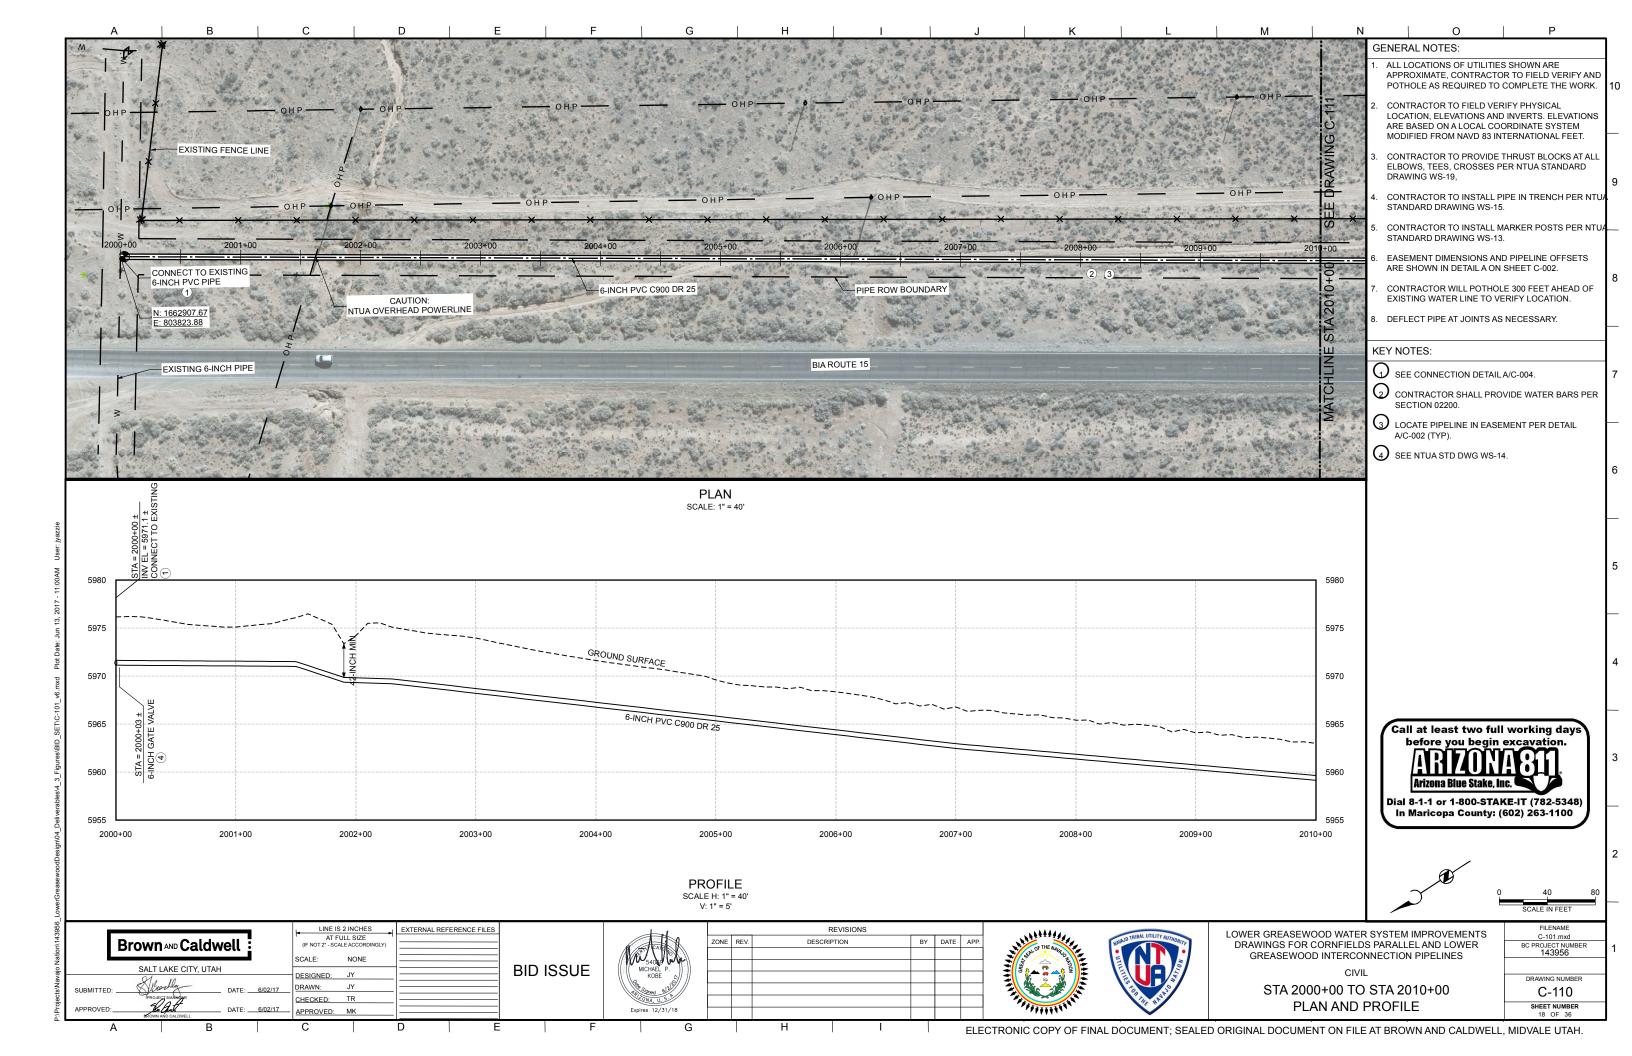


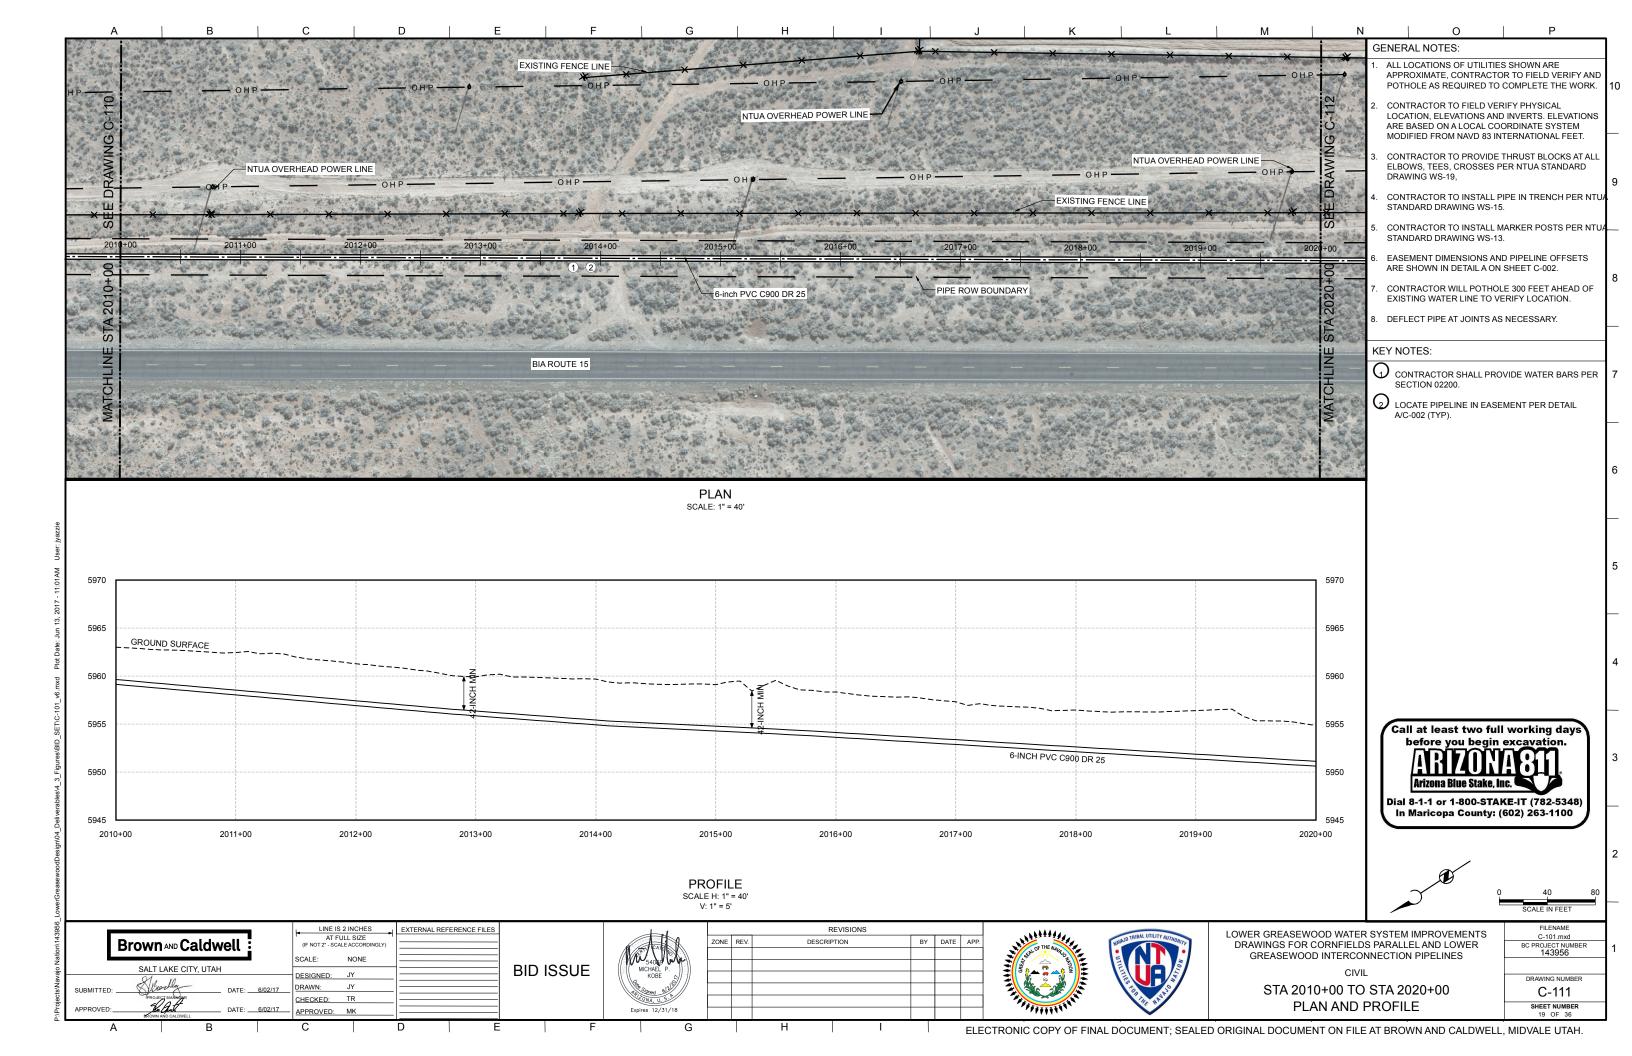


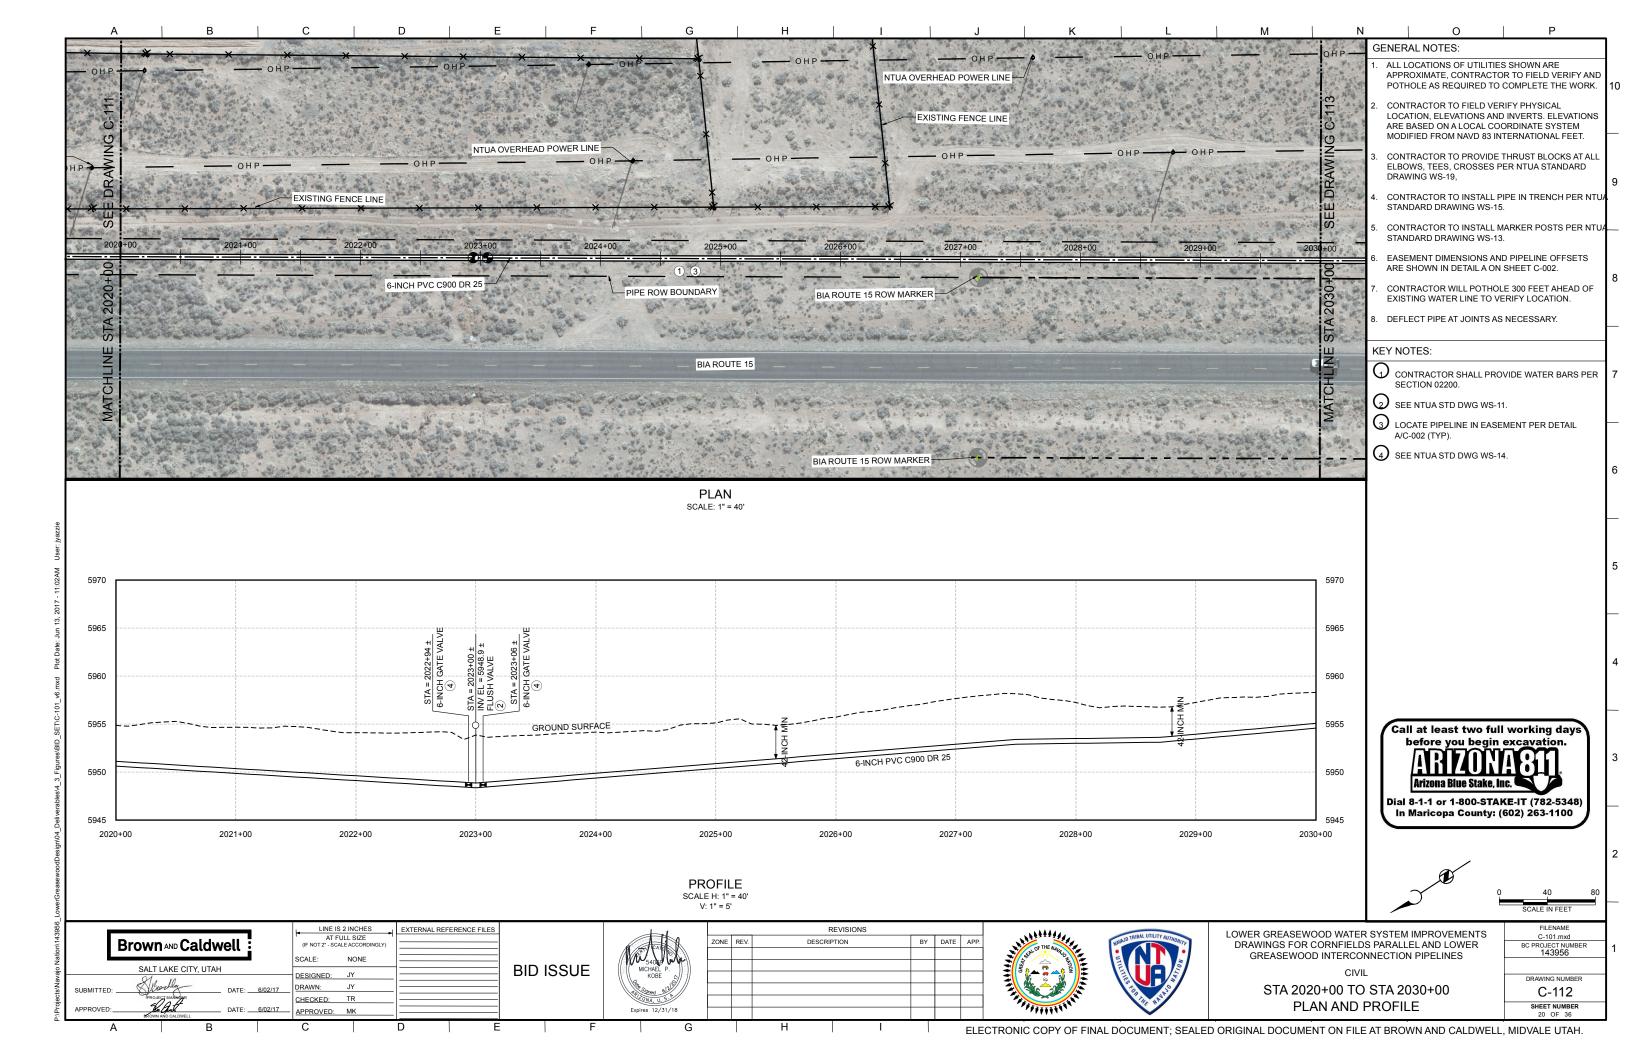


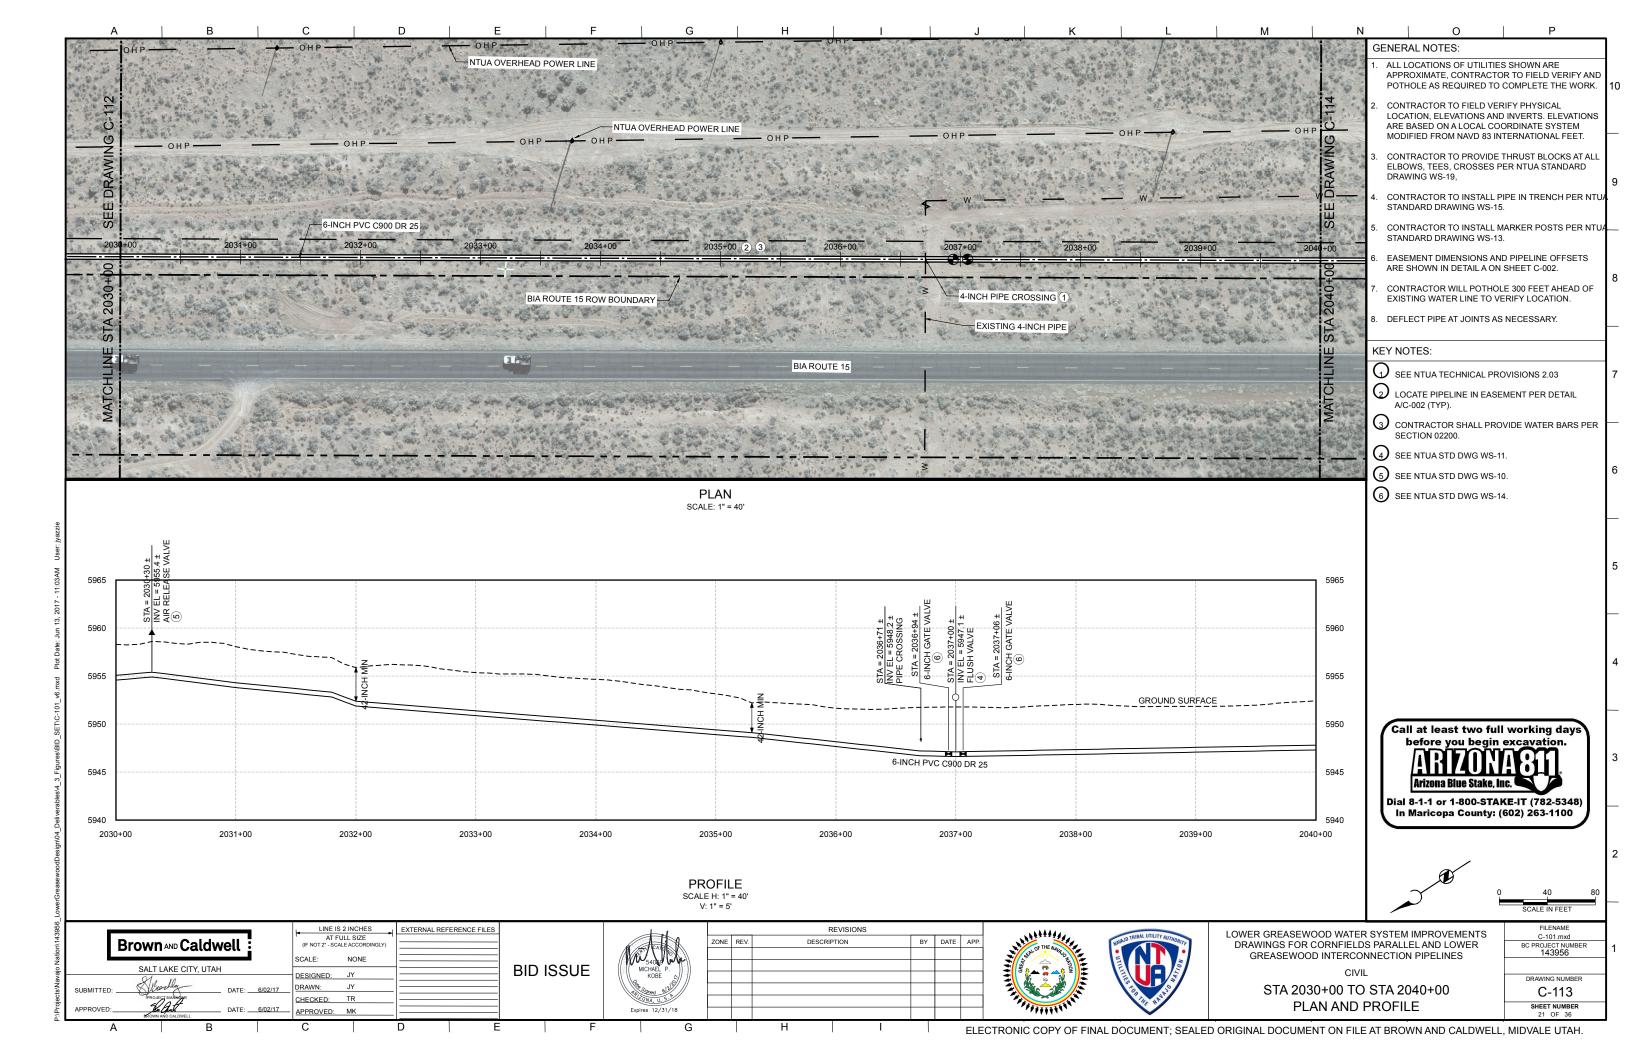


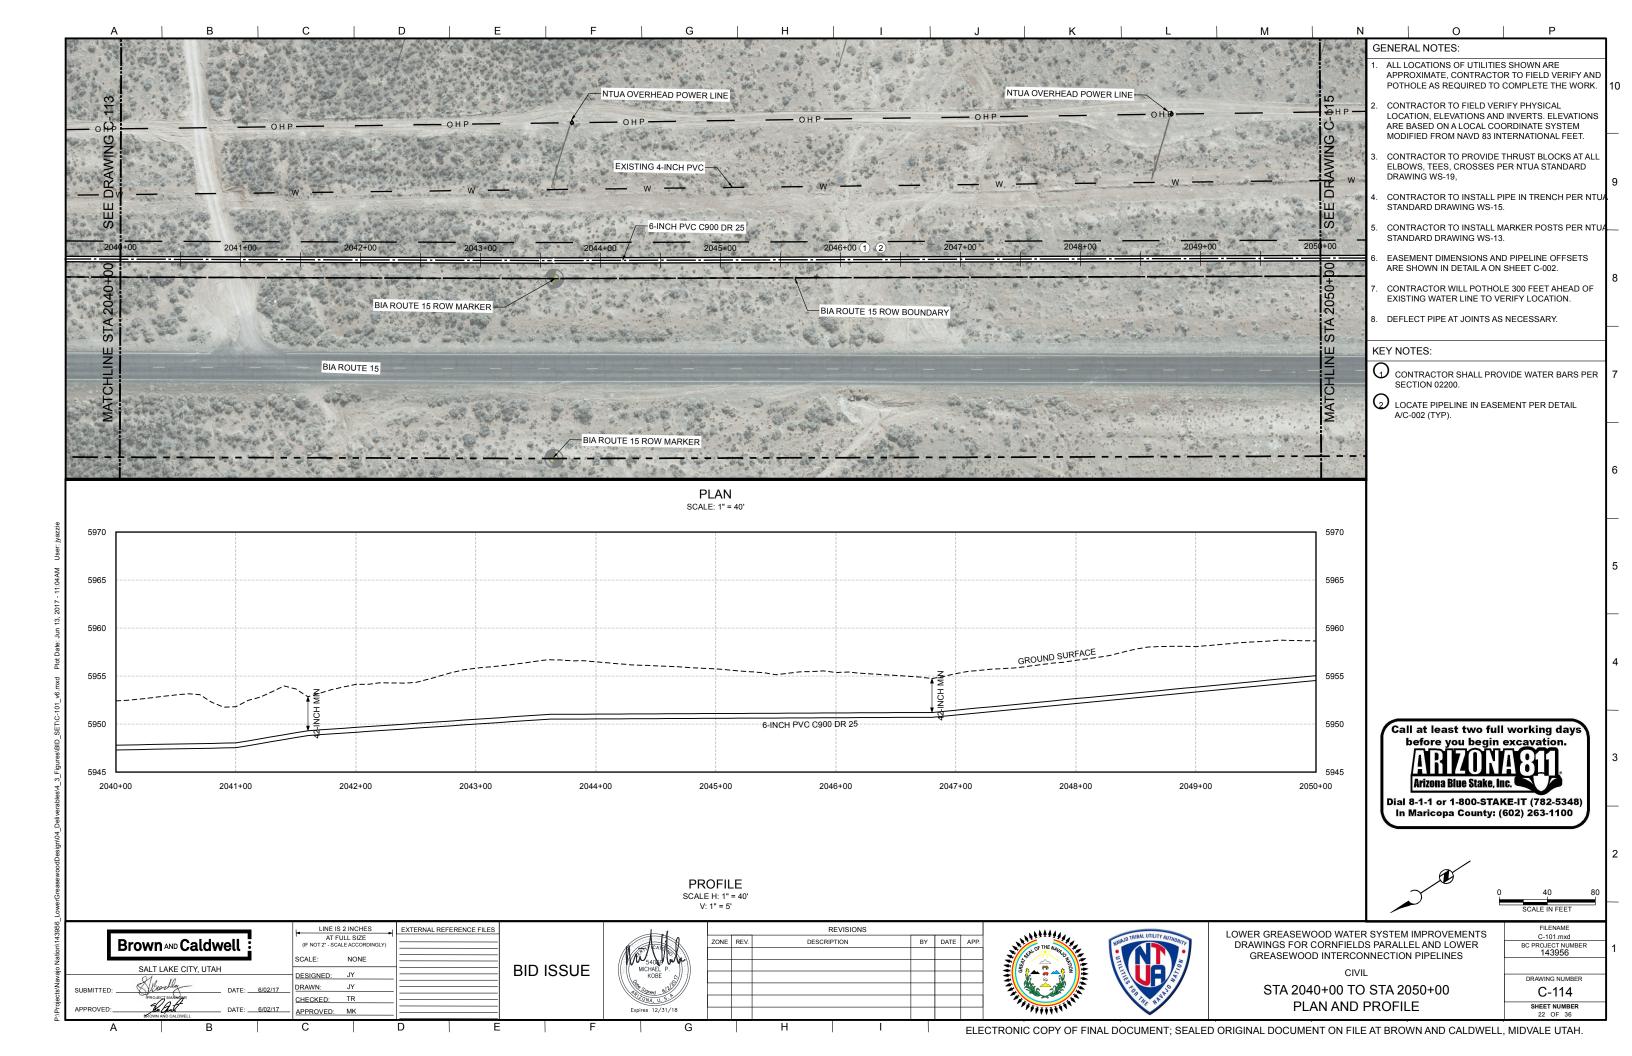


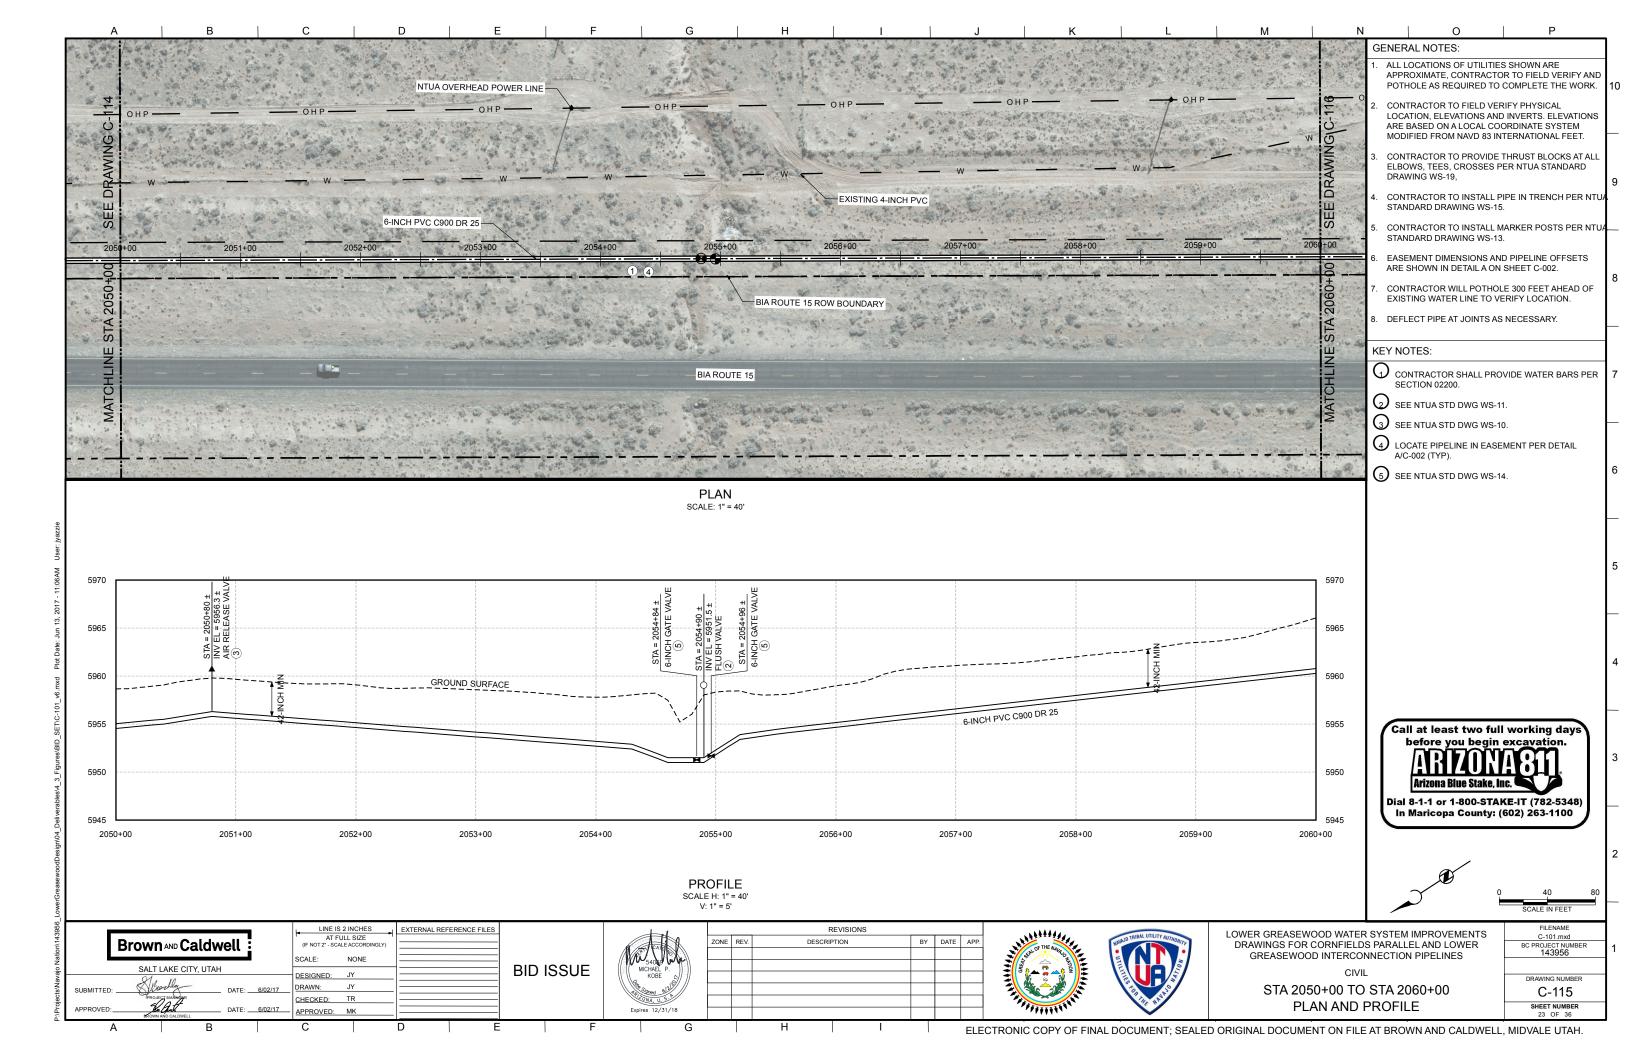


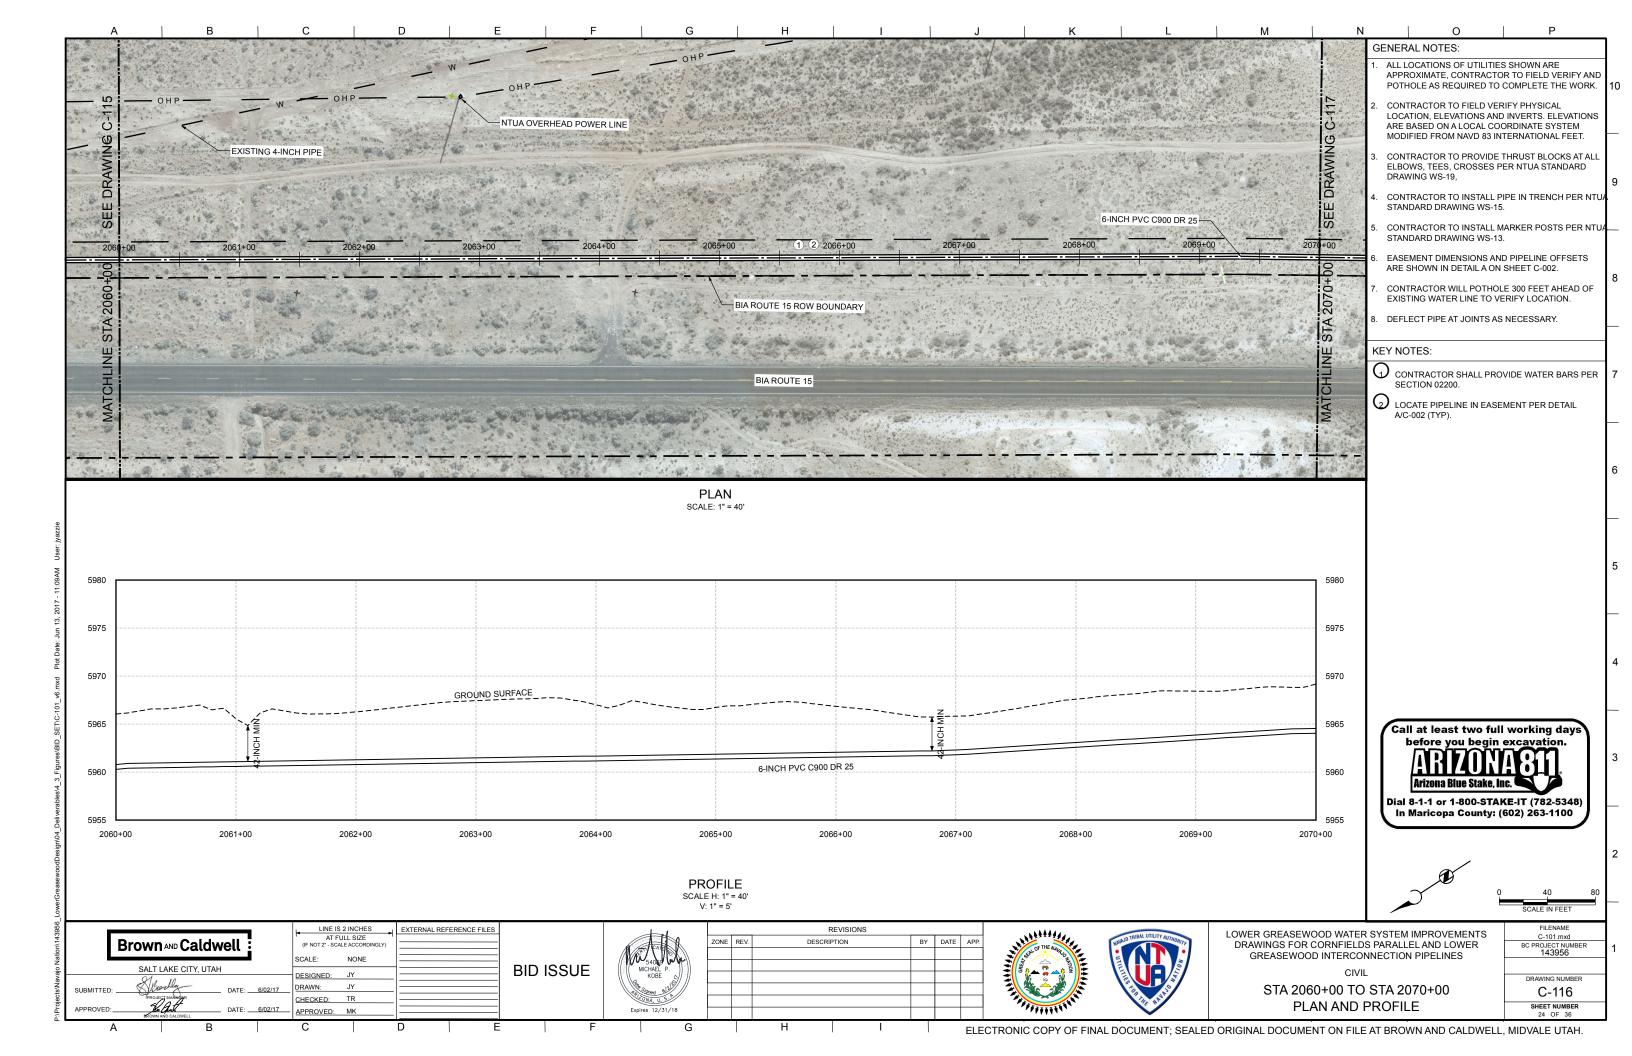


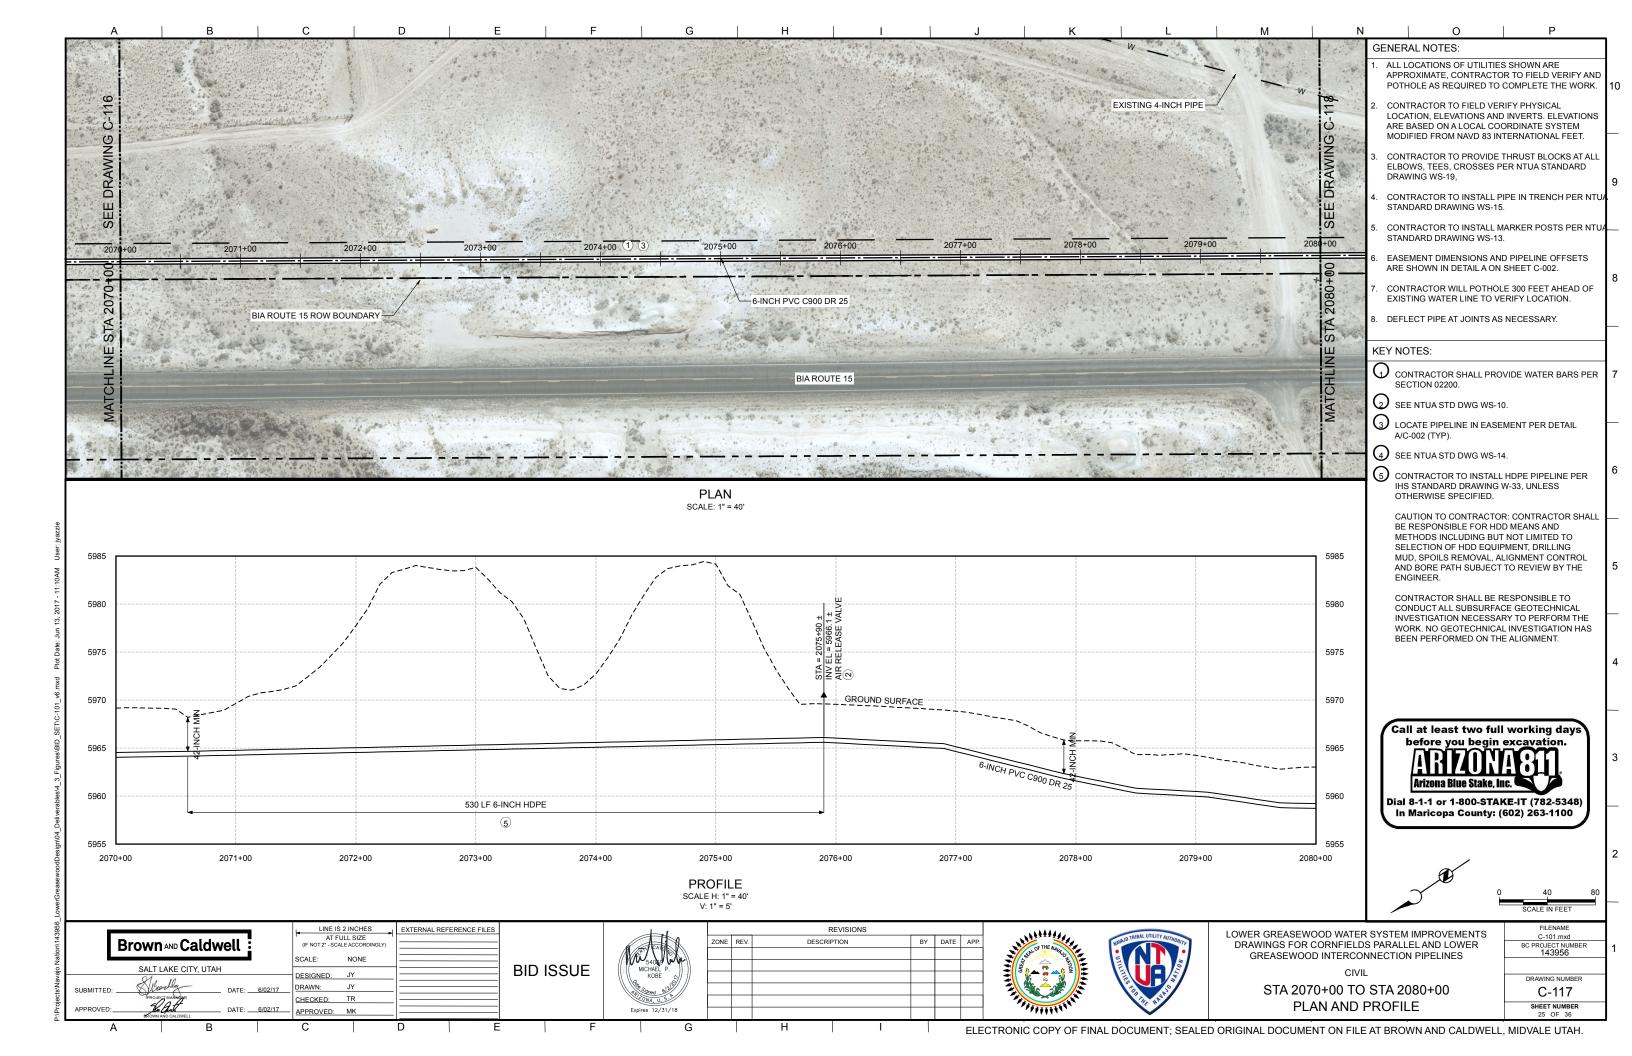


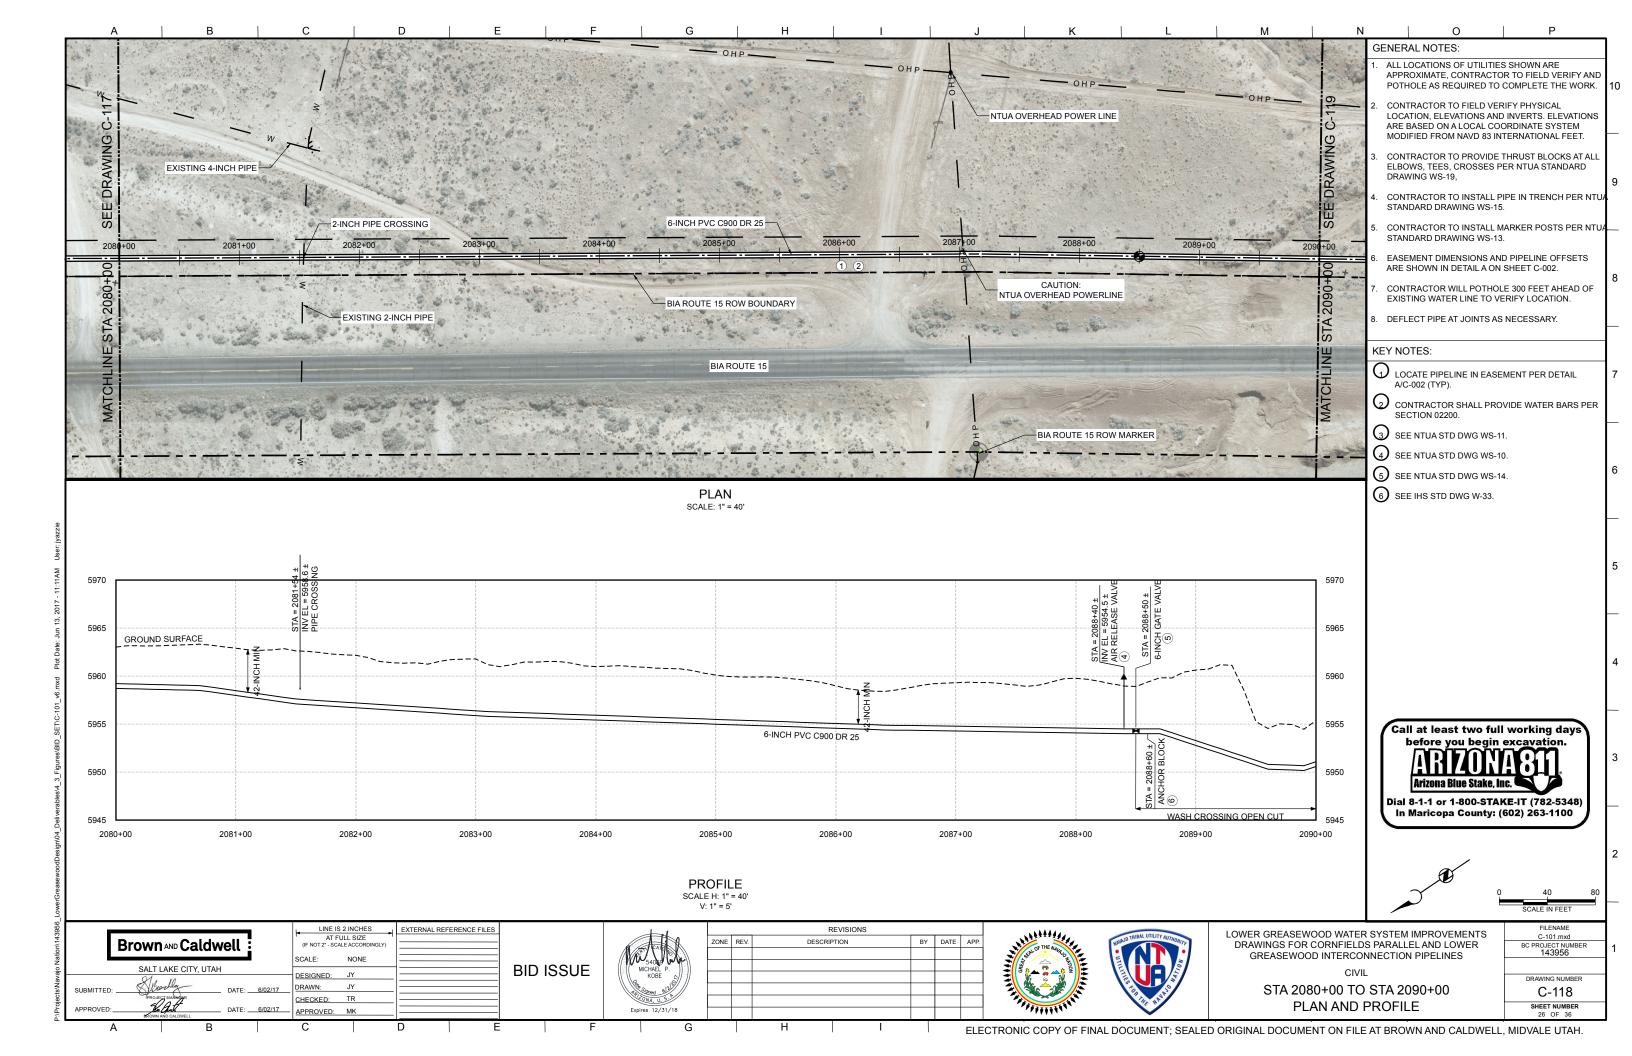


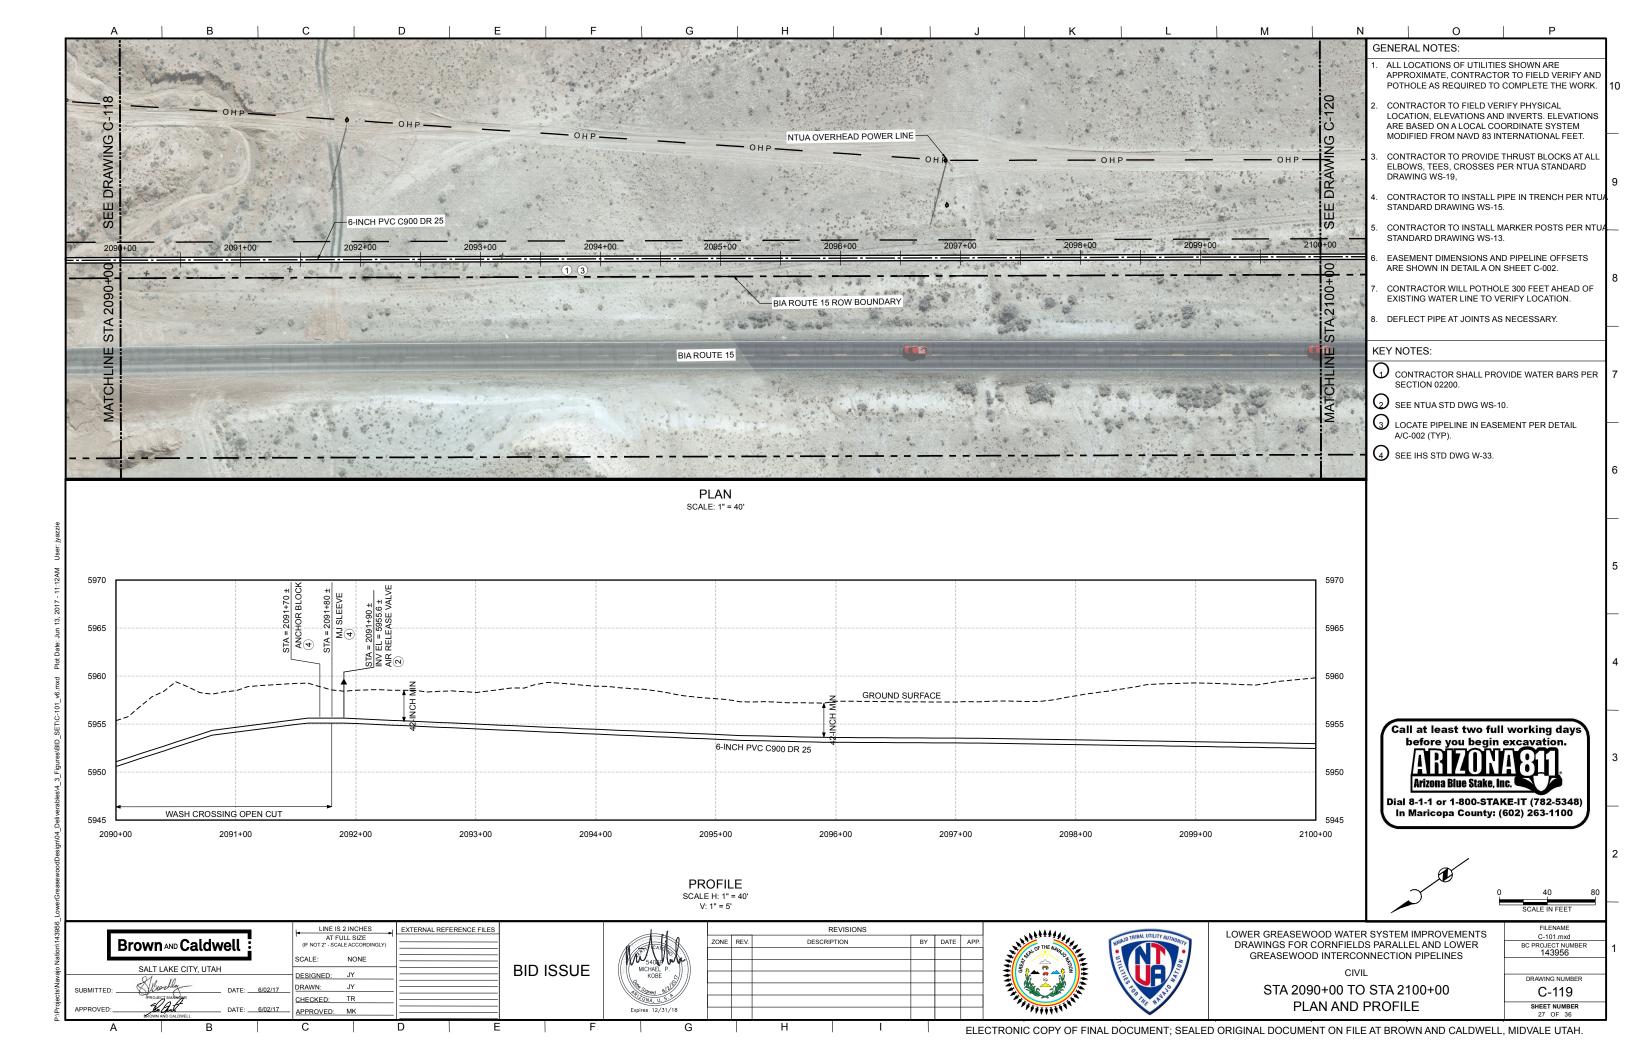


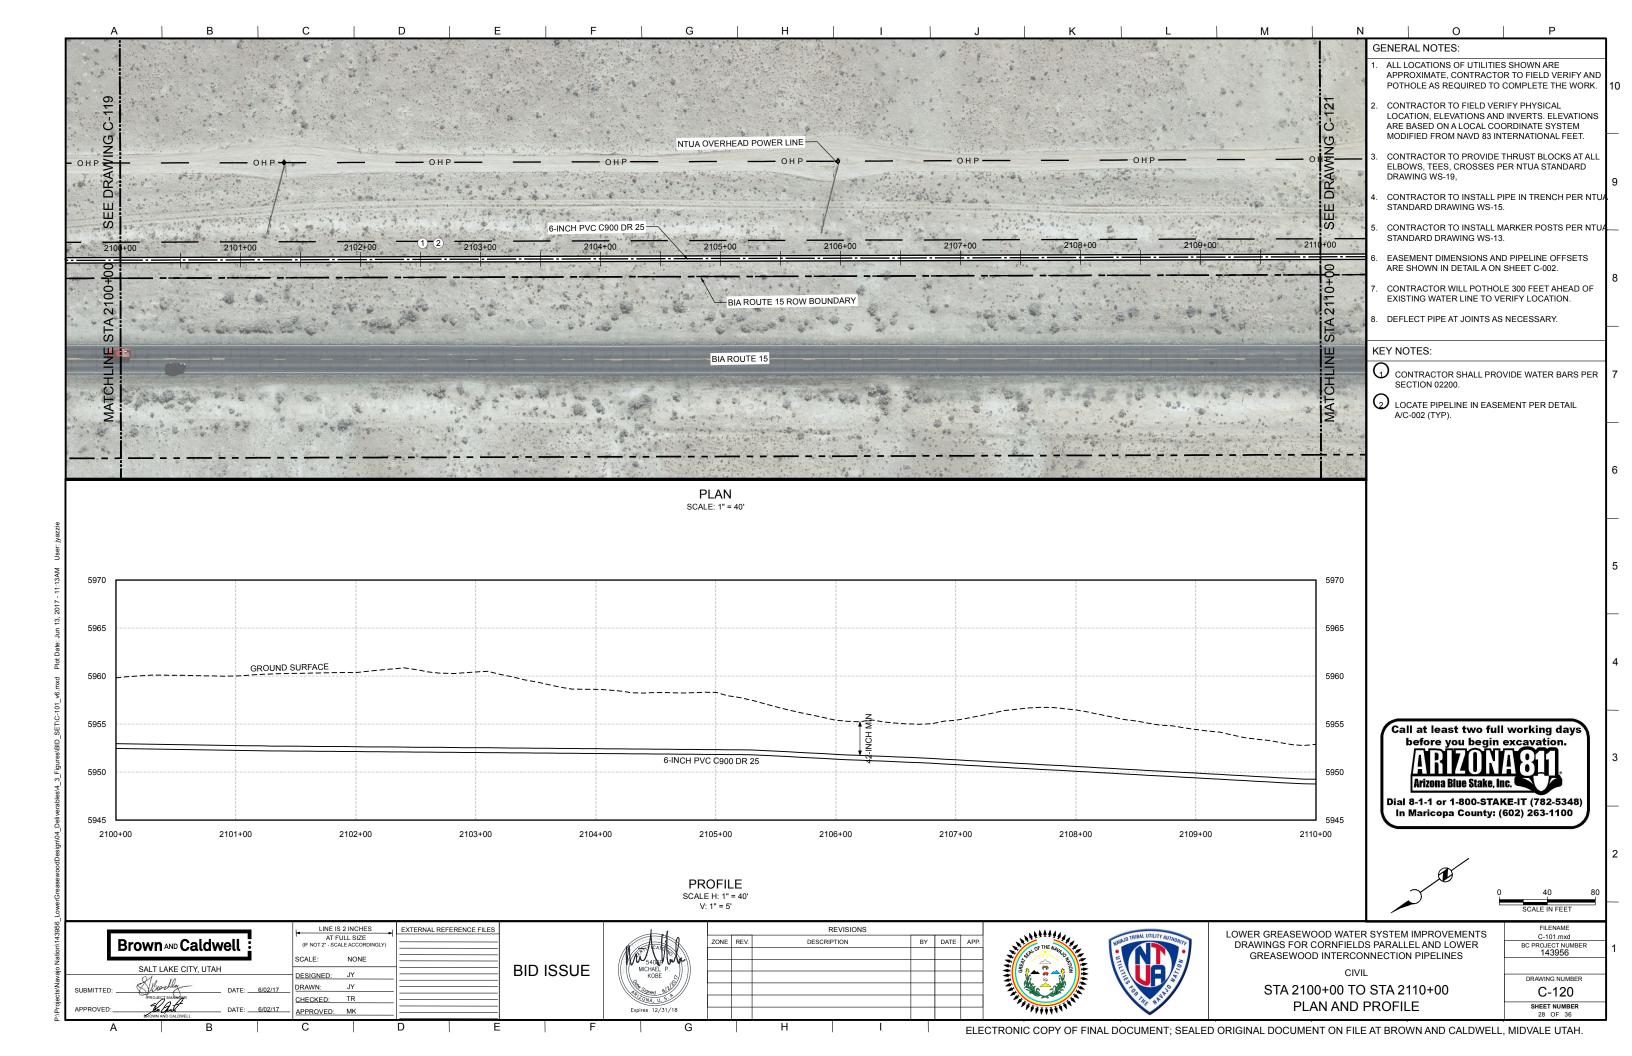


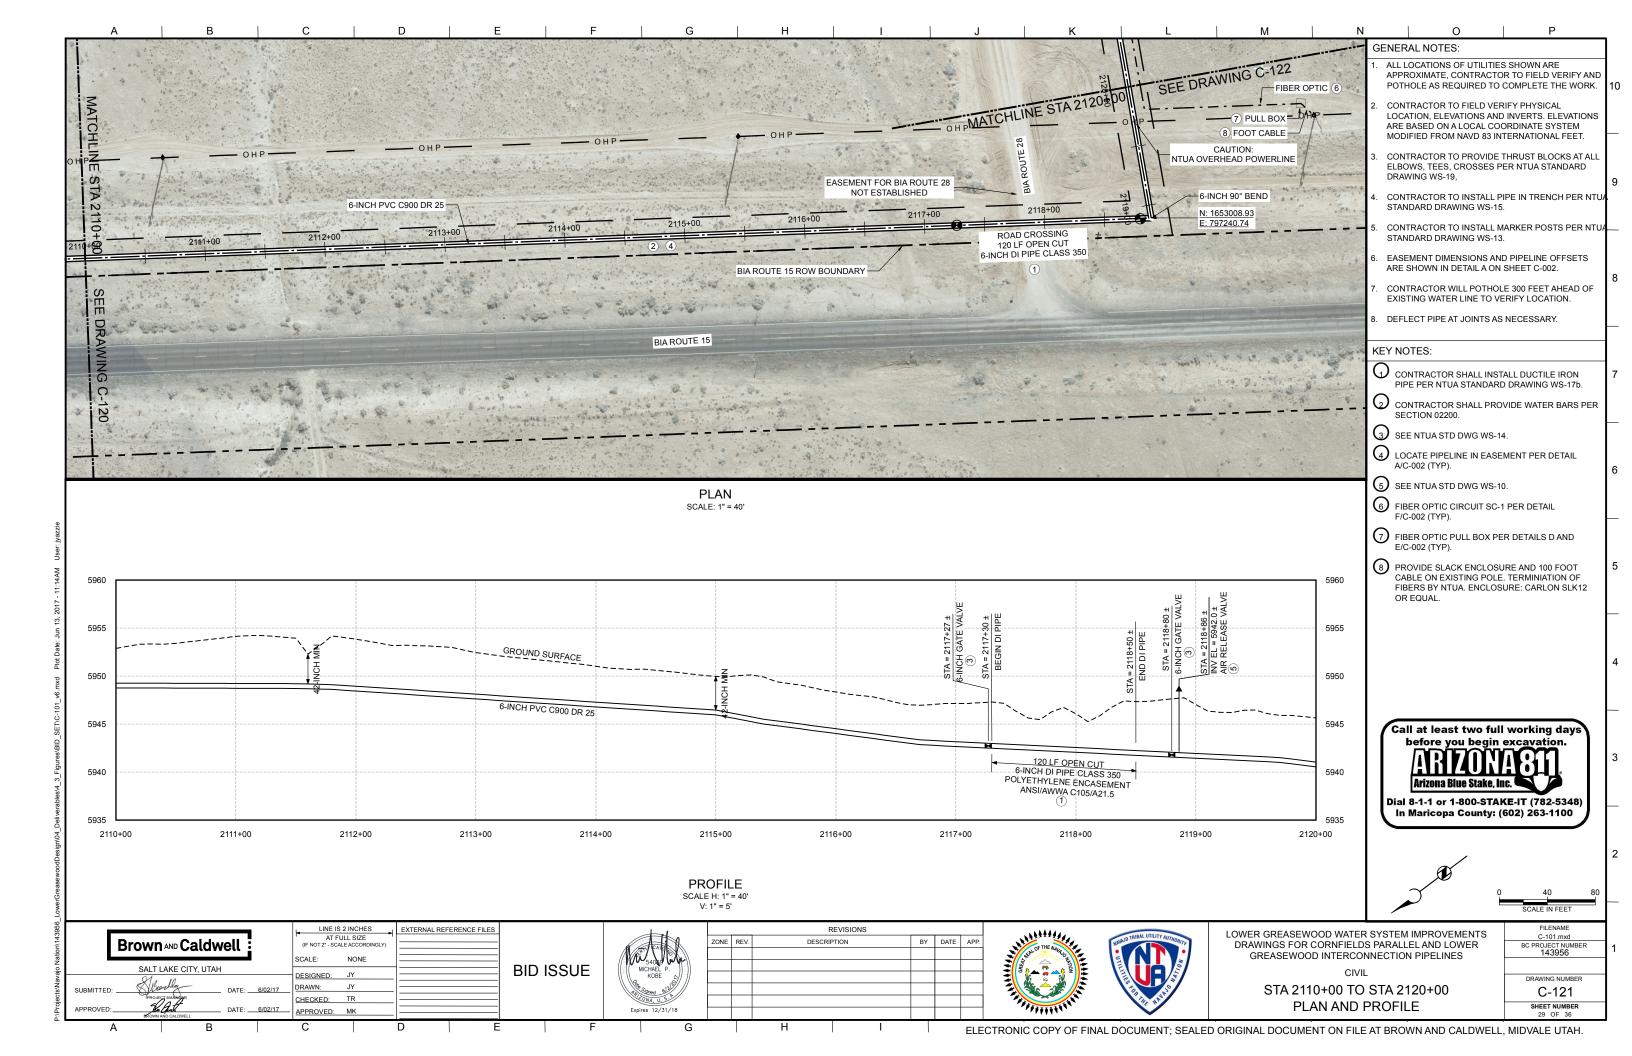


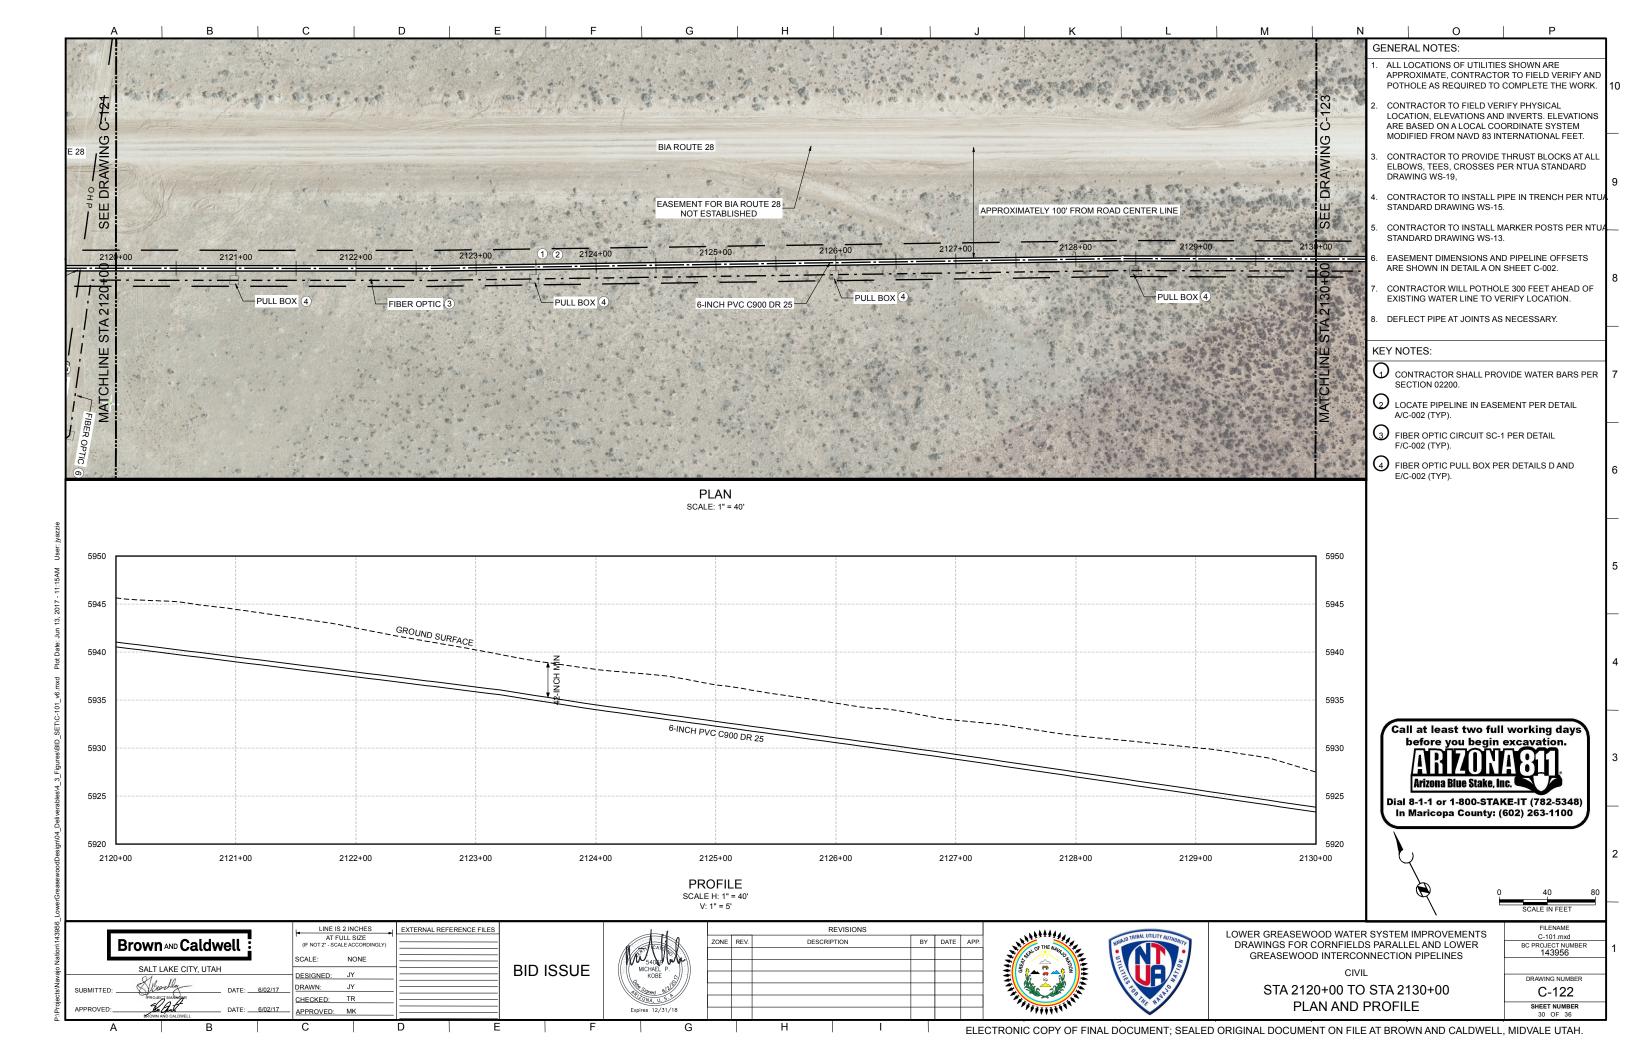


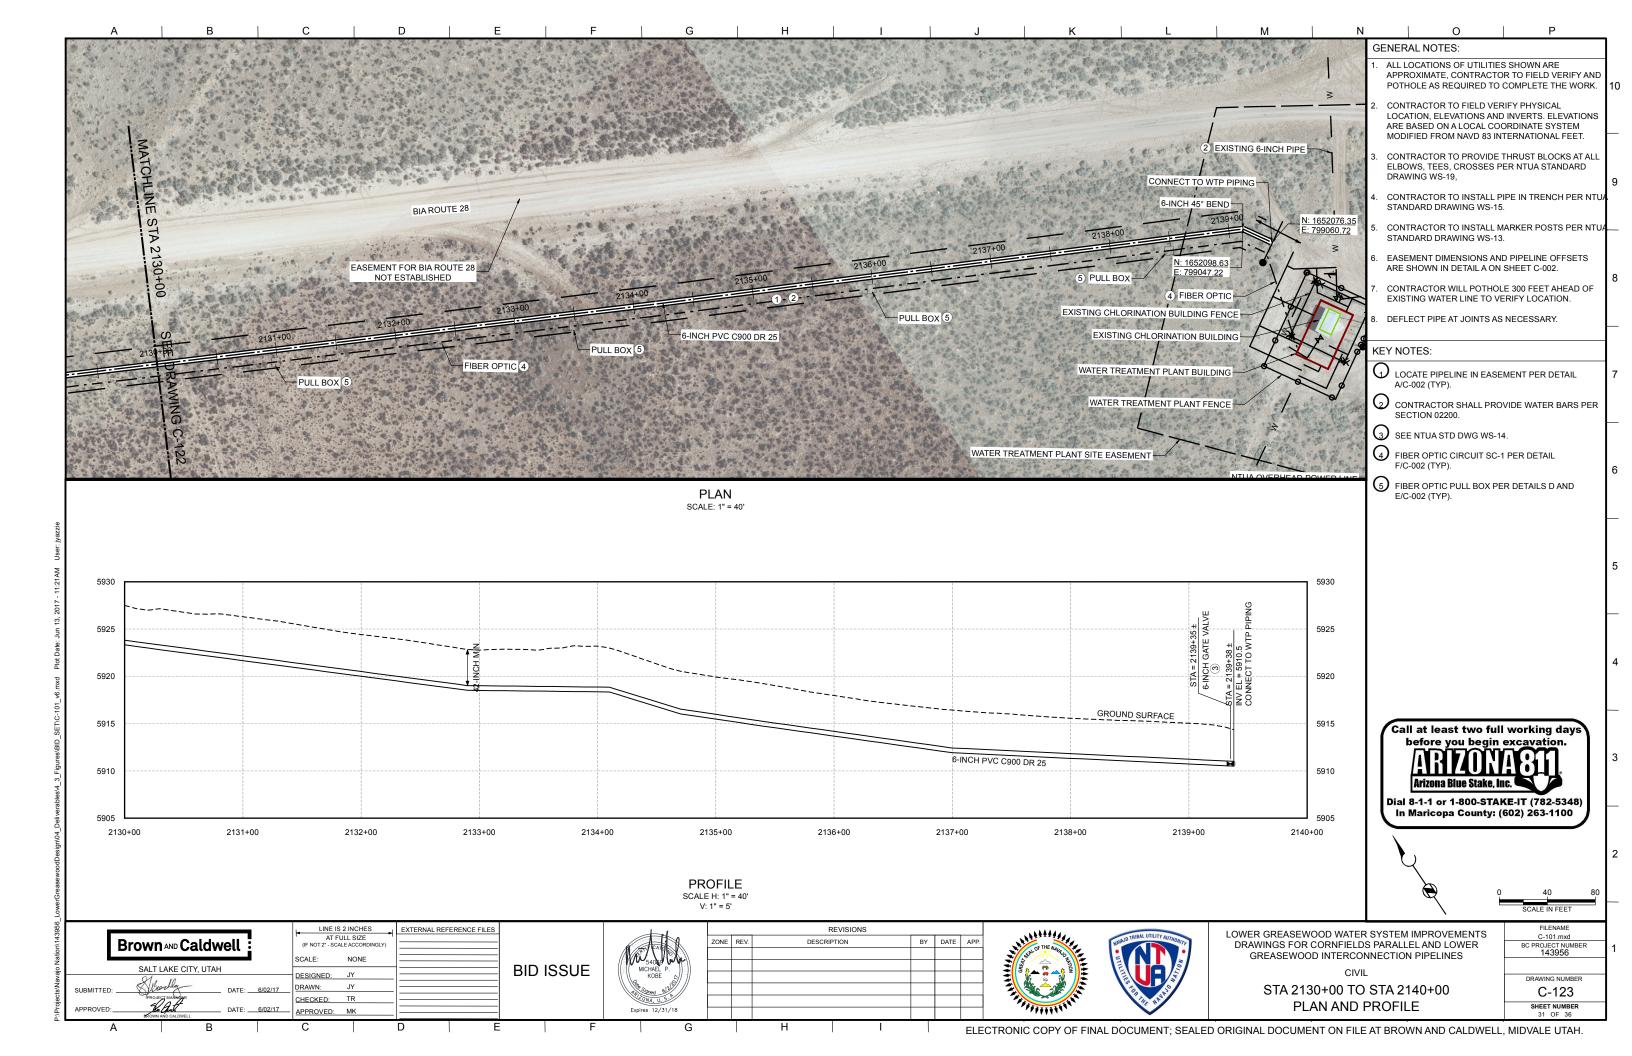


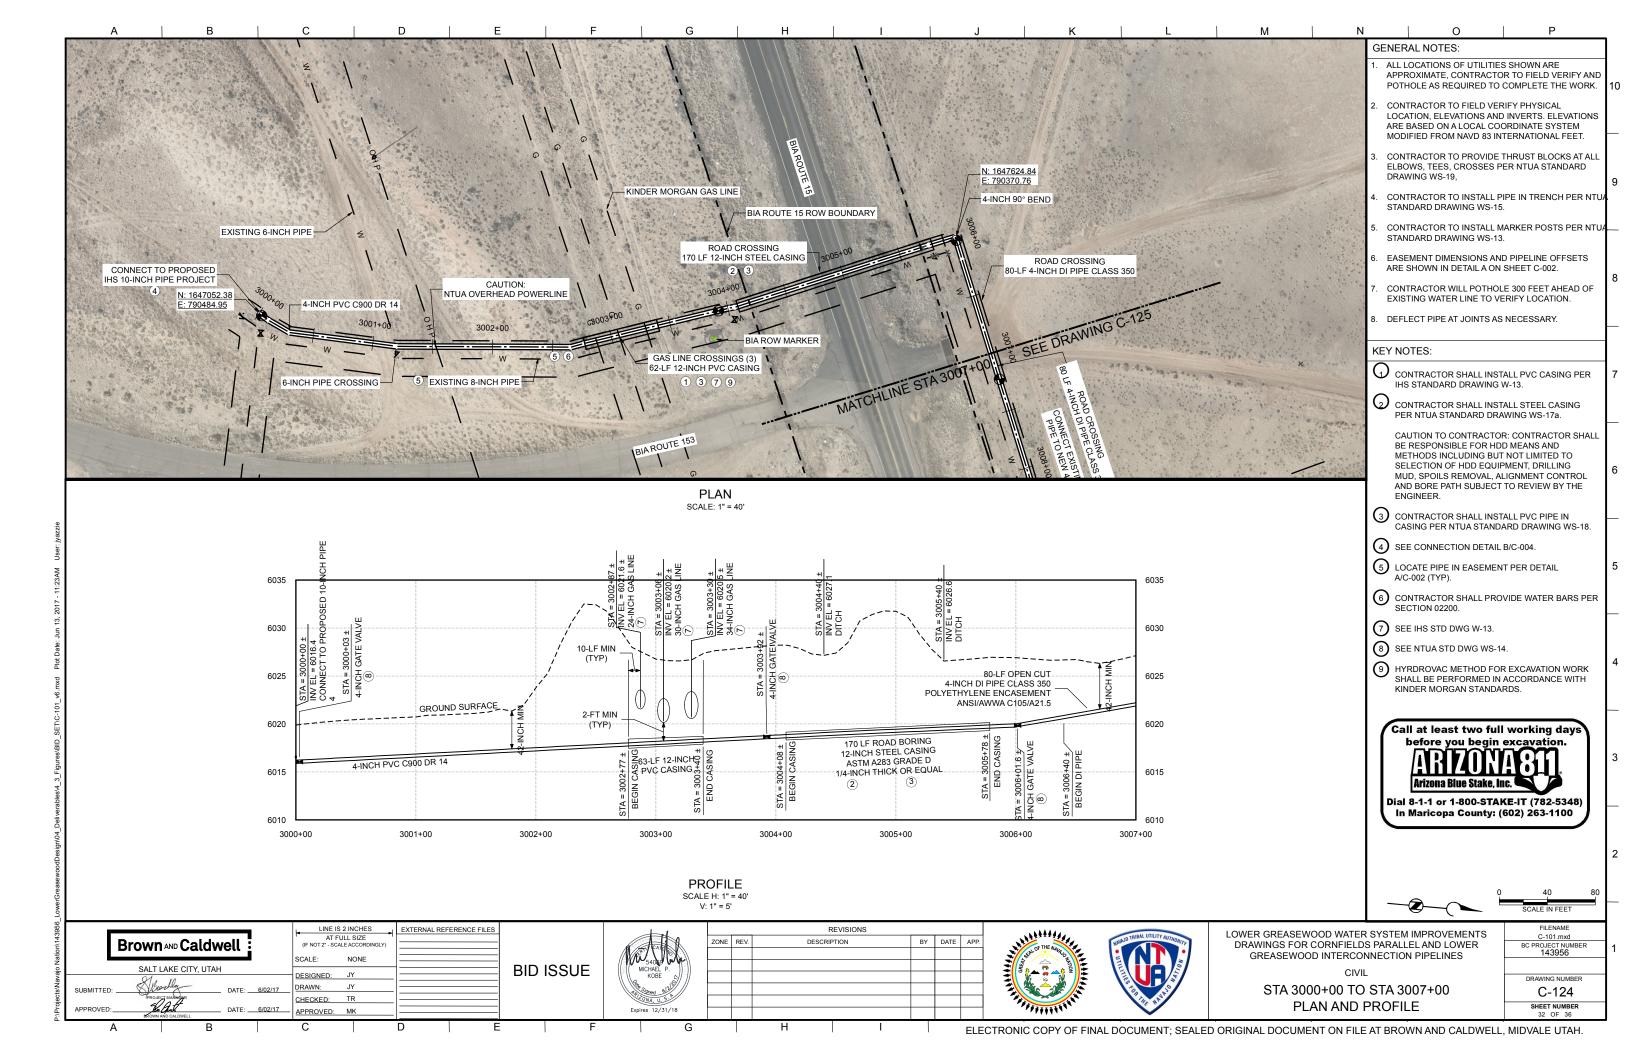


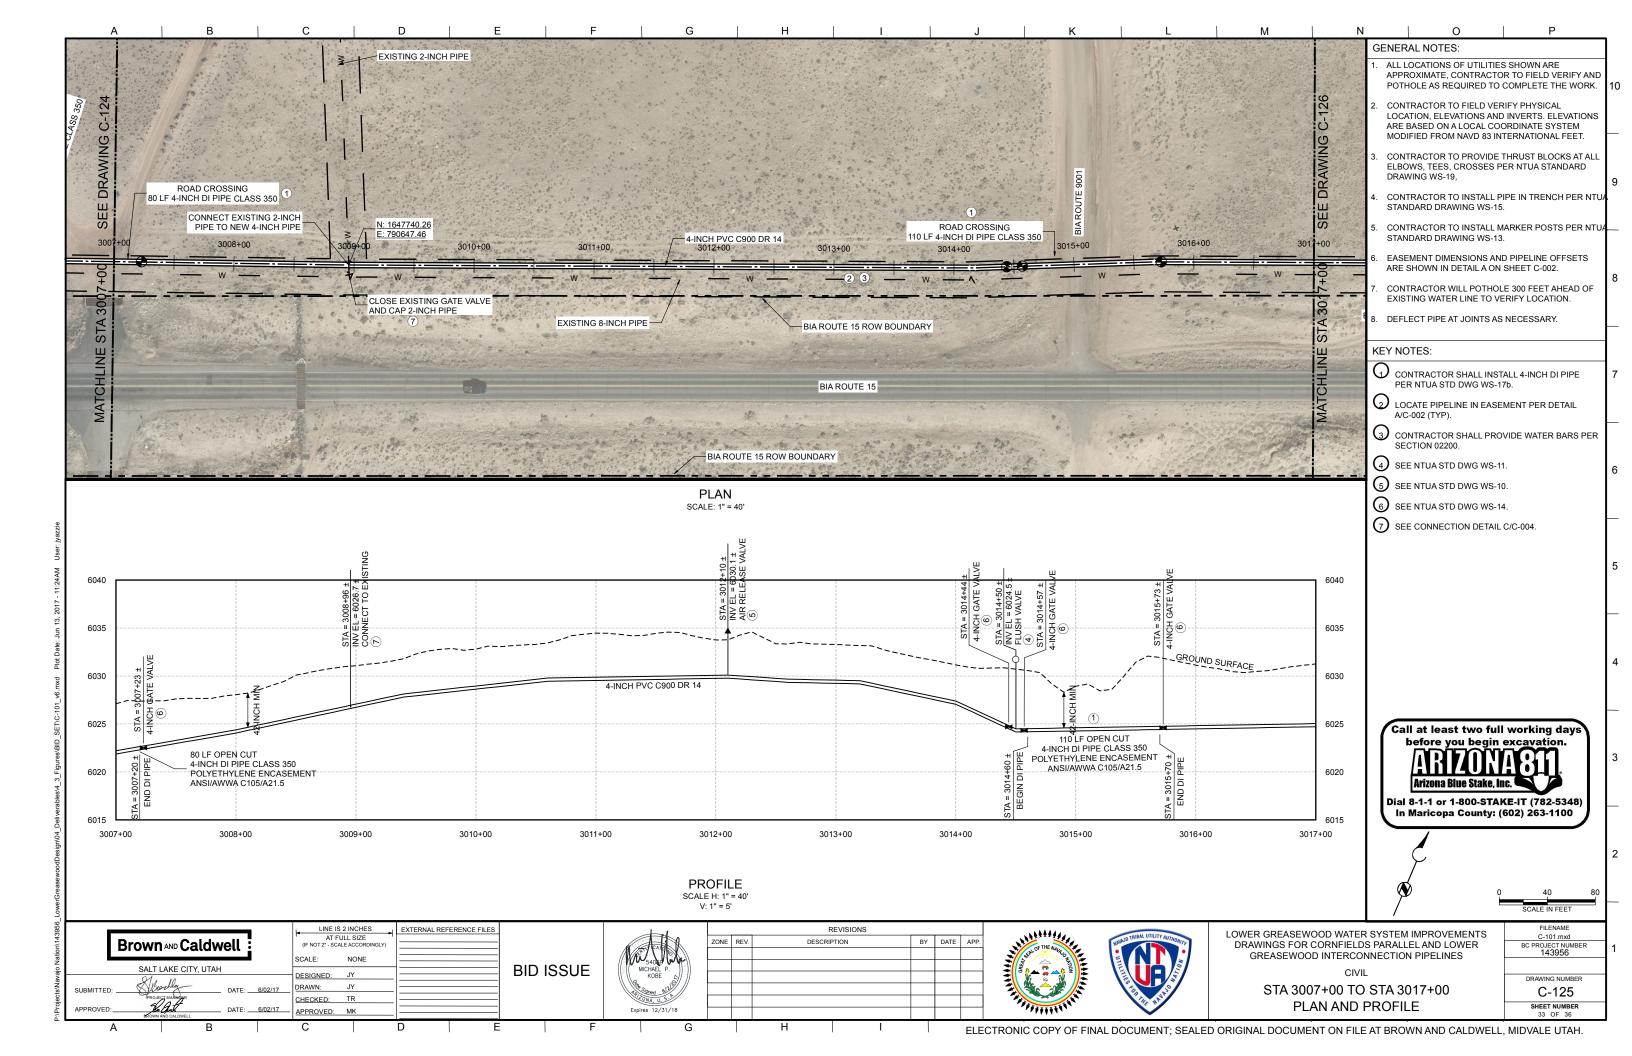

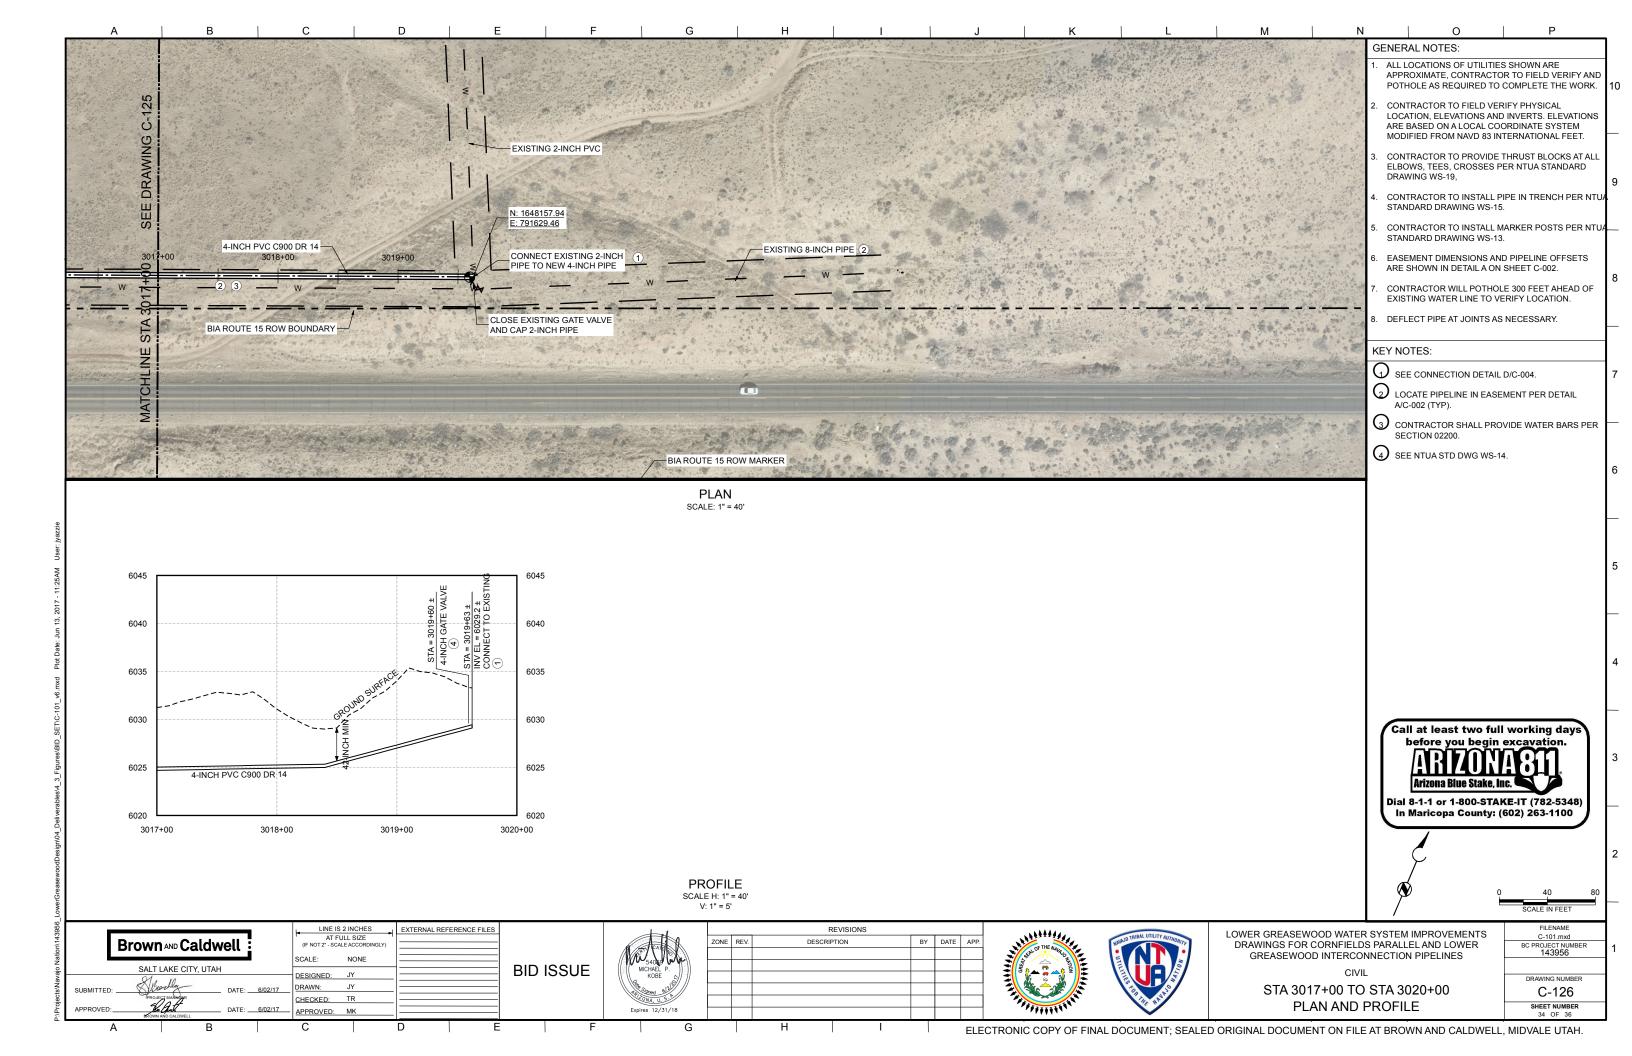

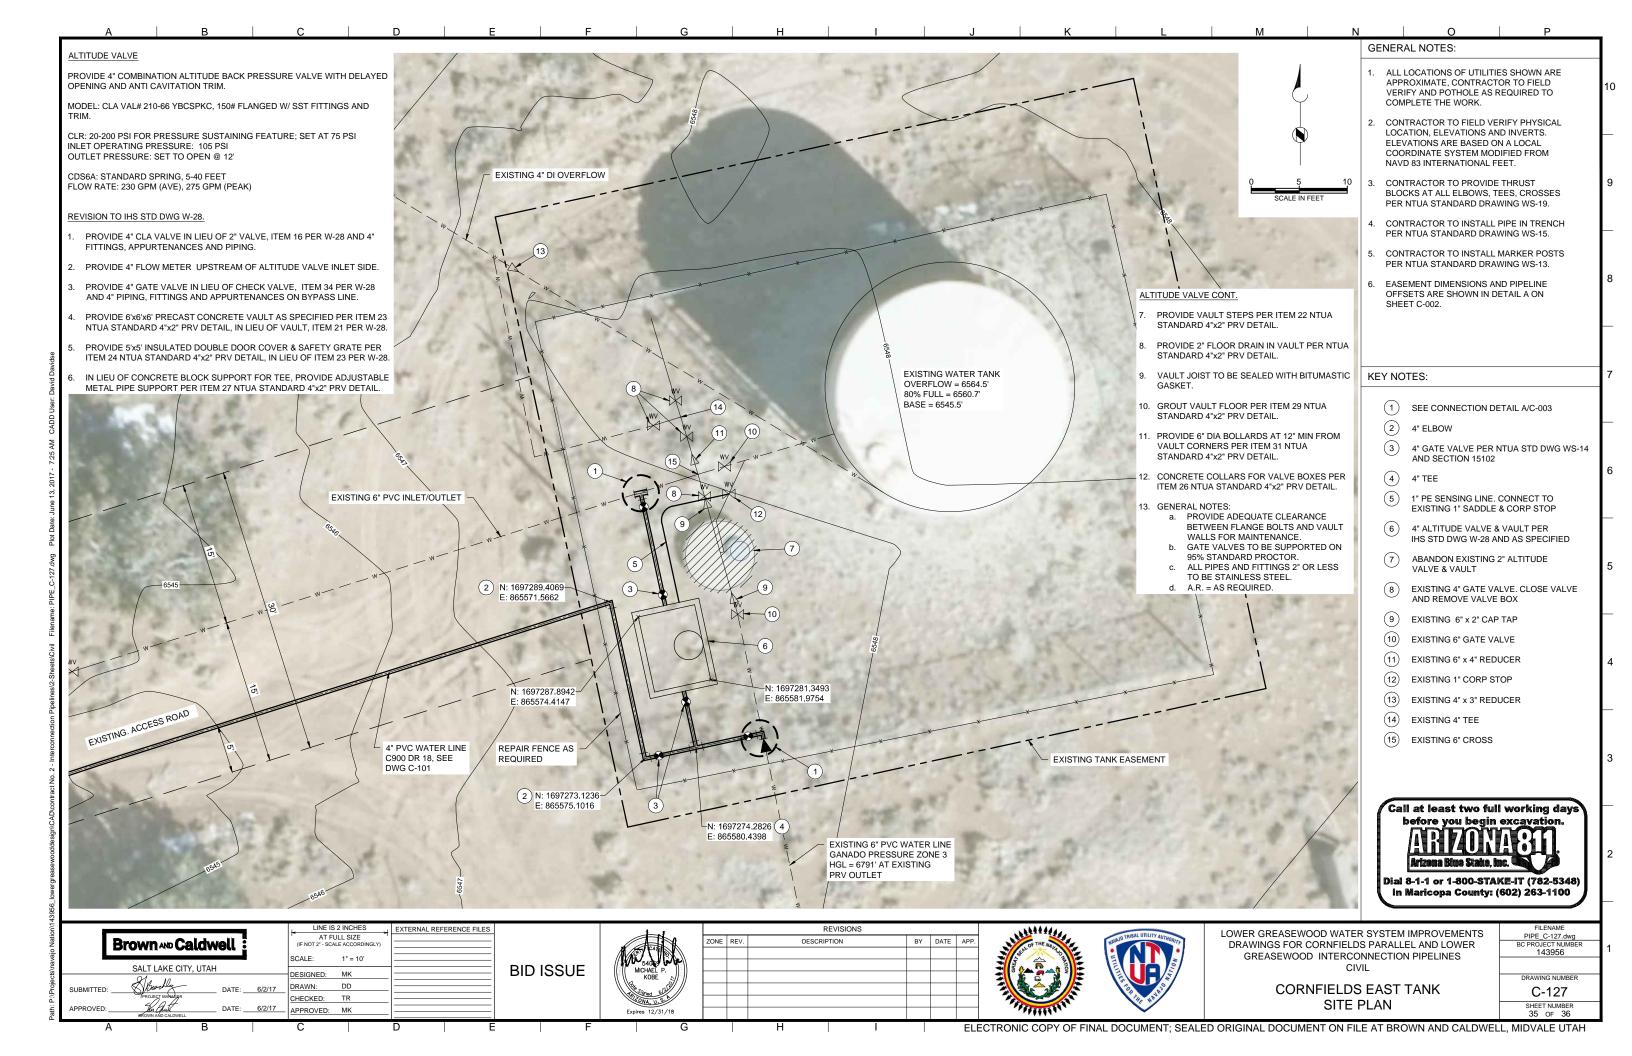


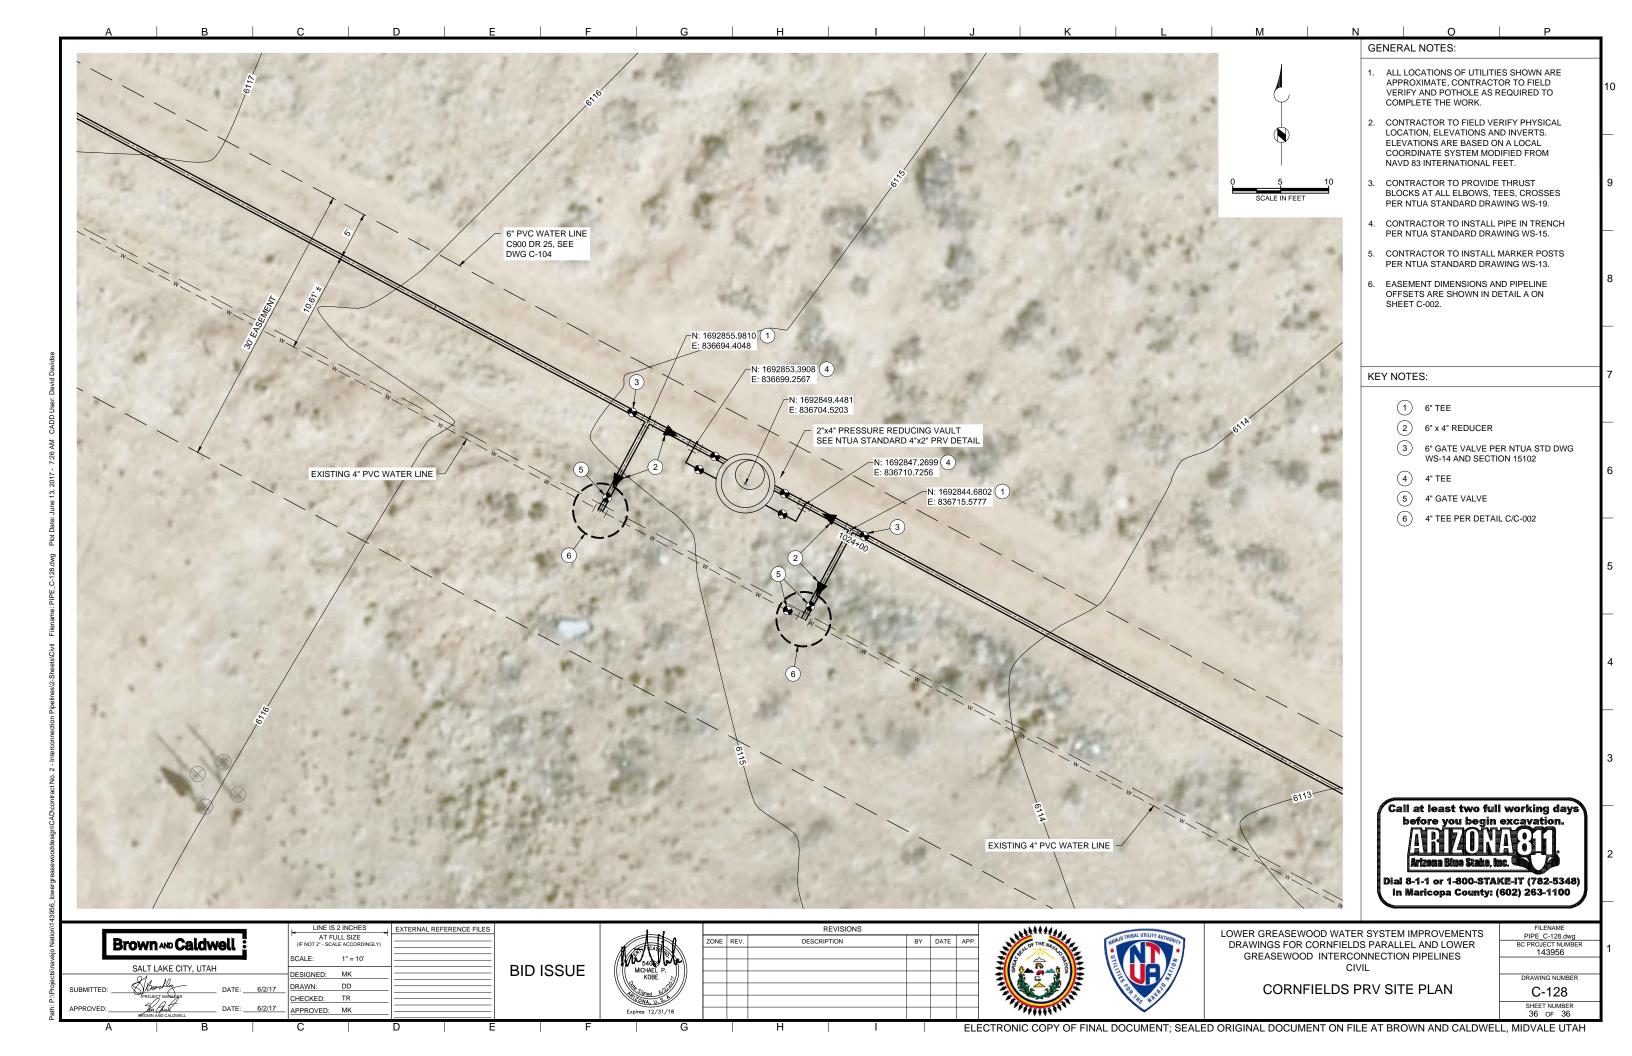

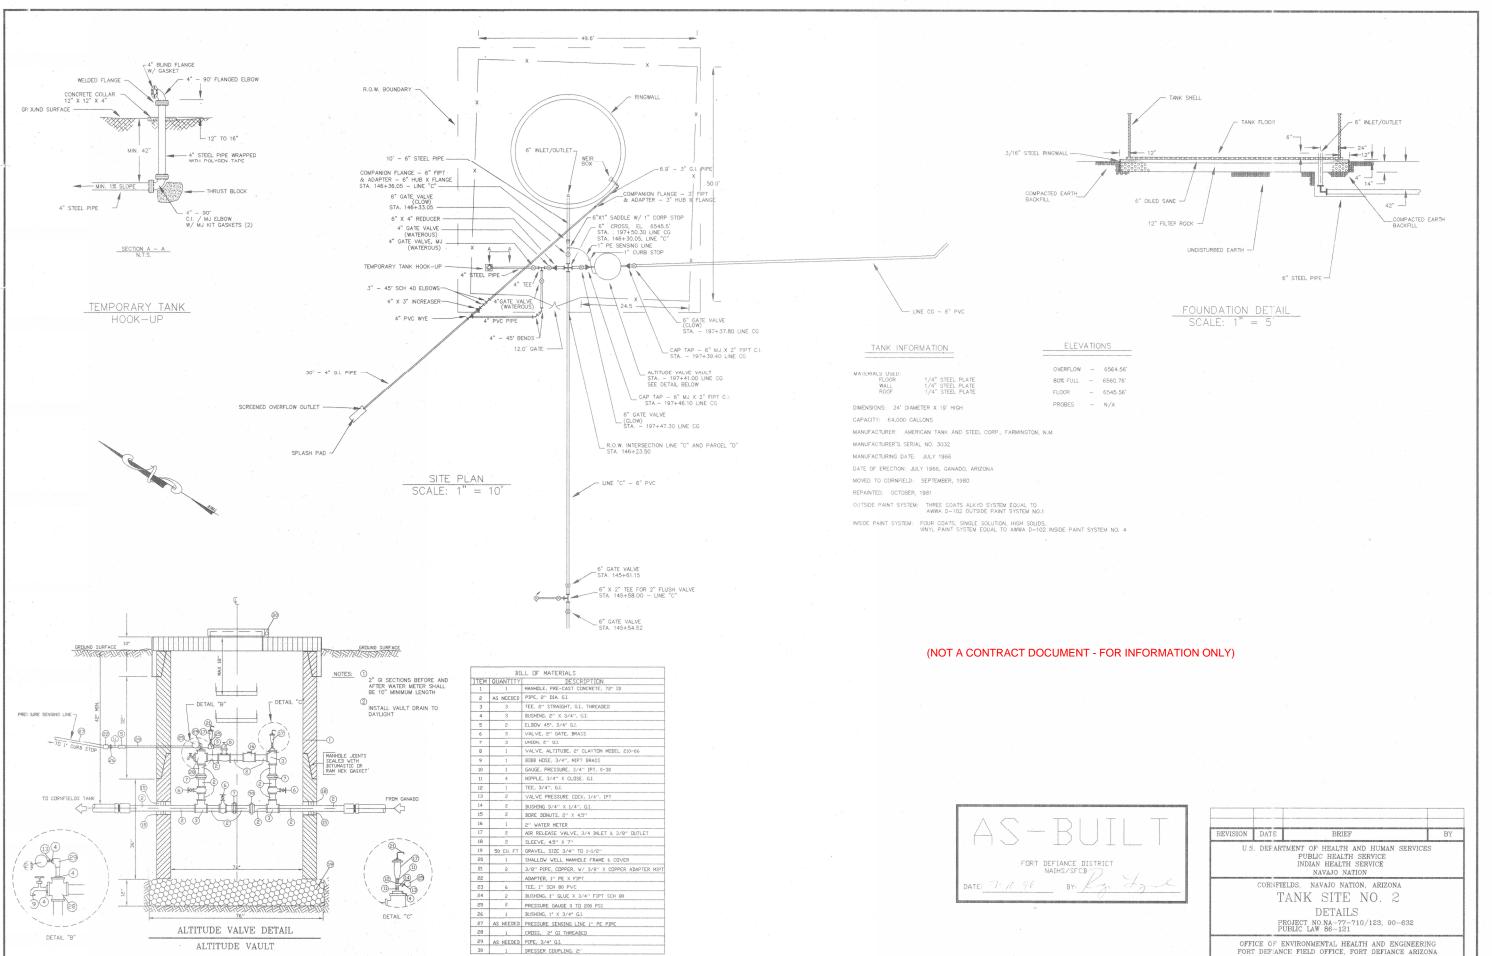

APPR. BY: P.S. AUTOCAD DATE: 5-94 632TANK.DWG SHEET NO. 30 OF 46 TOTAL SHEETS

DRAWN BY: L.D.S. CHECKED BY: G.P. APPR. BY: P.S. DATE: 5-94 DATE: 5-94

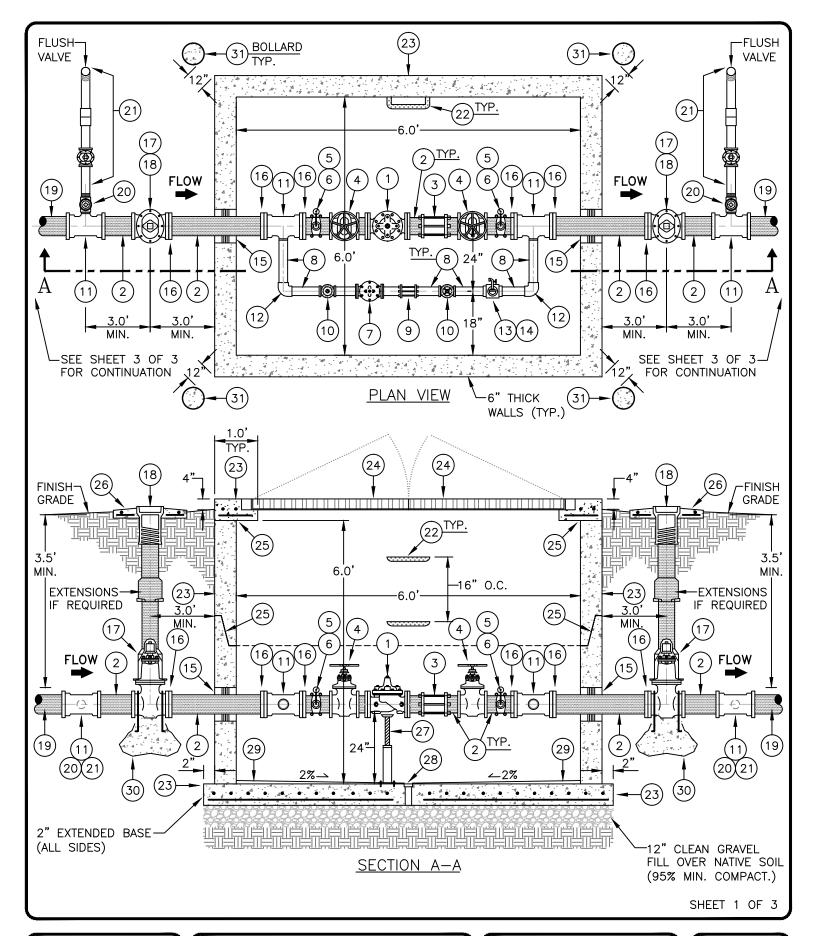

DESIGNED BY:	NTUA
SURVEYED BY:	1
DRAFTED BY:	NTUA
APPROVED BY:	NTUA
DATE:	12/2014
PROJECT NO.	•
SCALE:	NTS
ACAD FILENAME:	NTUA Water Details.dwg
DETAIL NO.	Custom Detail

NAVAJO TRIBAL UTILITY AUTHORITY CIVIL ENGINEERING DEPARTMENT

4" x 2" P.R.V.

E&TS HEADQUARTERS FT.DEFIANCE, AZ

\cap	REVISIONS			
No.	Date	Brief	By	
01	12/14	2014 Addition	A.S.	
02				
03				
04				
05				
(06				



		4" × 2" P.R.V.				
#		MATERIAL LIST				
ITEM	QTY	DESCRIPTION				
1	1	4" CLA-VAL, PRESSURE REDUCING VALVE, THREADED ENDS, STAINLESS STEEL (S.S.) TRIM & PILOT TUBING, 90 SERIES W/ OPTIONS A, B, C, D, V & M				
2	A.R.	4" DUCTILE IRON (D.I.) PIPE, CLASS 350, PLAIN END, CUT AS NEEDED				
3	1	4" DRESSER COUPLING (6" LONG FOR D.I. PIPE)				
4	2	4" GATE VALVE, F.I.P.T., N.R.S., R.H.T., HAND WHEEL				
5	2	2" DOUBLE STRAP W/ 2" x 3/4" BUSHING AND 3/4" x 1/4" BUSING FOR PRESSURE GAGE				
6	2	PRESSURE GAUGE W/ 1/4" BRASS SHUTOFF VALVE				
7	1	2" CLA-VAL, PRESSURE REDUCING VALVE, THREADED ENDS, STAINLESS STEEL (S.S.) TRIM & PILOT TUBING, 90 SERIES W/ OPTIONS A, B, C, D, V & M				
8	A.R.	2" S.S. PIPE, THREADED, CUT AS NEEDED				
9	1	2" DRESSER COUPLING (6" LONG FOR S.S. PIPE)				
10	2	2" GATE VALVE, F.I.P.T., N.R.S., R.H.T., HAND WHEEL				
11	4	4" x 4" x 2" D.I., M.J. TAPPED TEE, CLASS 350, FLANGED				
12	2	2" 90° S.S. ELBOW, F.I.P.T.				
13	1	2" S.S. HOSE BIB				
14	1	2" S.S. TEE W/ 2" x 3/4" BUSHING AND 3/4' x 1/4" BUSHING FOR HOSE BIB				
15	2	VAULT BORE DONUT, 6" W/ 4" HOLE				
16	6	4" D.I. 'E-Z' FLANGED ADAPTER, CLASS 350				
17	2	4" GATE VALVE, M.J., RESILIENT SEAT, FLANGED, N.R.S., R.H.T., W/ 2" OPERATING NUT				
18	4	VALVE BOX, 2-PIECE SCREW TYPE, 5-1/4" SHAFT W/ CAST IRON DROP LID				
19	_	4" SDR-21 PVC PIPE -OR- EXISTING WATER LINE				
20	2	2" CORPORATION STOP, MIPT x FIPT				
21	2	INSTALL 2" FLUSH VALVE PER NTUA STD. DTL. WS-11 (AFTER THE CORP. STOP)				
22	A.R.	PLASTIC COATED STEEL OR ALUMINUM STEP @ 16" O.C., INSTALL TO 12" ABOVE VAULT FLOOR				
23	1	6' x 6' x 6' (INT. DIM.) PRECAST CONCRETE VAULT (4,000 PSI MIN.), 6" THICK WALLS W/ 6" THICK REINFORCED CONCRETE TOP (NON-TRAFFIC RATED) AND 6" REINFORCED CONCRETE BASE				
24	1	5' x 5' SQ., INSULATED, DOUBLE DOOR COVER AND SAFETY GRATE, ALUMINUM CHANNEL FRAME W/ T-HANDLE SLAM LOCK AND COVERED PADLOCK CLIP				
25	A.R.	VAULT JOINTS TO BE SEALED WITH BITUMASTIC GASKET				
26	4	24" x 24" x 4" CONCRETE COLLAR W/ #4 REBAR, E.W., INDICATE PIPE SIZE & FLOW DIRECTION				
27	2	ADJUSTABLE METAL PIPE SUPPORT (UNDER BOTH PRV'S INSIDE VAULT)				
28	1	2" FLOOR DRAIN W/ SCREEN, DRAIN TO 5" CLEAN GRAVEL (ADJUST PER FIELD CONDITIONS)				
29	A.R.	CEMENT, NON-SHRINK GROUT, SLOPE FINISH @ 2% (0.02%) TOWARD VAULT DRAIN				
30	A.R.	CONCRETE ANCHOR BLOCK PER NTUA STD. DTL. WS-19 & WS-19a				
31	4	6" DIA. BOLLARDS AT 12" MIN. FROM VAULT CORNERS PER MAG. STD. 140, TYPE 1				

GENERAL NOTES:

- 1. PROVIDE ADEQUATE CLEARANCE BETWEEN FLANGE BOLTS AND VAULT WALLS FOR MAINTENANCE.
- 2. GATE VALVES TO BE SUPPORTED ON 95% STANDARD PROCTOR. 2-INCH
- 3. ALL PIPES AND FITTINGS 4" OR LESS TO BE STAINLESS STEEL.
- 4. HEX HEAD BOLTS/NUTS TO BE STAINLESS STEEL, TYPE 304.
- 5. A.R. = AS REQUIRED.

SHEET 2 OF 3

NTUA
-
NTUA
NTUA
12/2014
-
NTS
NTUA Water Details.dwg
Custom Detail

NAVAJO TRIBAL UTILITY AUTHORITY CIVIL ENGINEERING DEPARTMENT


MATERIAL LIST: 4" x 2" P.R.V.

E&TS HEADQUARTERS

FT.DEFIANCE, AZ

$\overline{}$		REVISIONS	
No.	Date	Brief	By
01	12/14	2014 Addition	A.S.
02			
03			
04			
05			
06			



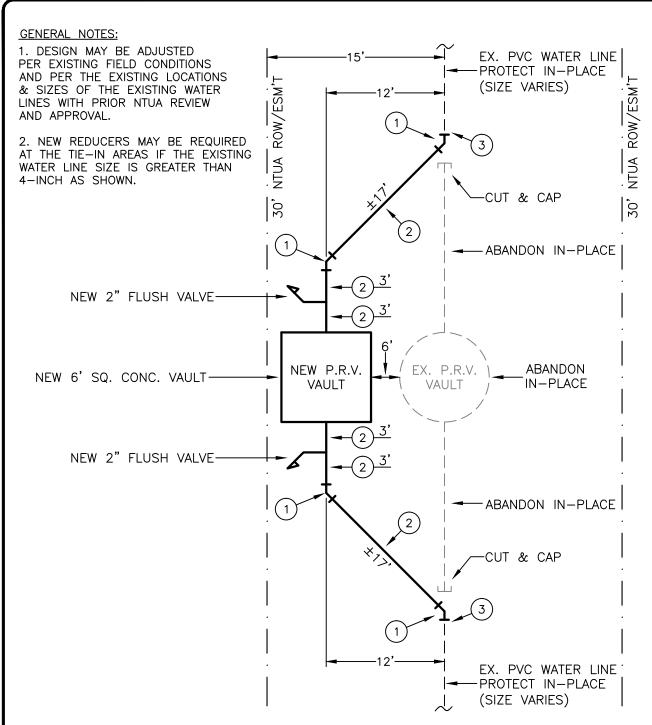

		CONCRETE VAULT INSTALLATION AREA (4" x 2" P.R.V.)
#		MATERIAL LIST
ITEM	QTY	DESCRIPTION
1	4	4" x 45 DEGREE ELL, D.I.P., CLASS 350, MJ, W/ CONCRETE THRUST BLOCK PER WS-19
2	A.R.	4" D.I. PIPE, CLASS 350, PLAIN END, CUT AS NEEDED
3	2	4" D.I. TRANSITION COUPLING, CLASS 350, D.I. x P.V.C. (IPS) 6" LONG

SHEET 3 OF 3

DESIGNED BY:	NTUA
SURVEYED BY:	-
DRAFTED BY:	NTUA
APPROVED BY:	NTUA
DATE:	12/2014
PROJECT NO.	-
SCALE:	NTS
ACAD FILENAME:	NTUA Water Details.dwg
DETAIL NO.	Custom Detail

NAVAJO TRIBAL UTILITY AUTHORITY CIVIL ENGINEERING DEPARTMENT


CONCRETE VAULT INSTALLATION AREA (4" x 2" P.R.V.)

E&TS HEADQUARTERS

FT.DEFIANCE, AZ

REVISIONS			
<u>_</u>			
s.			
_			
_			
_			



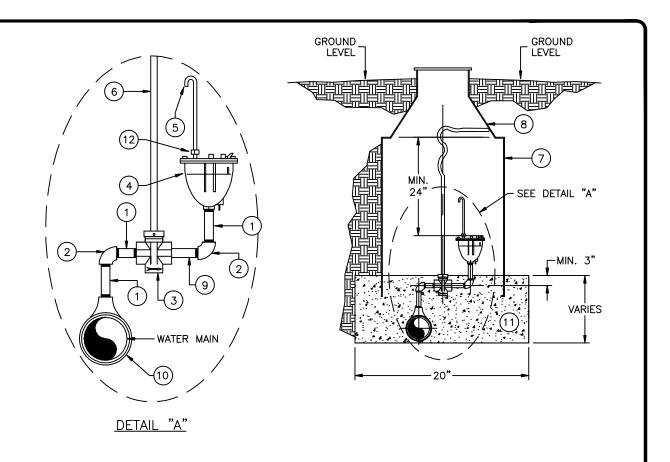


		MATERIAL LIST			
ITEM	QUAN	DESCRIPTION			
1	3	3/4' x 3" NIPPLE, BRASS			
2	2	3/4" x 90' ELBOW, BRASS			
3	1	3/4" CURB STOP VALVE, FIPT, MUELLER H-10287, OAE			
4	1	3/4" IN x 3/8" OUT AIR RELEASE VALVE			
5	1	3/8" O.D. PIPE, COPPER, 12" MIN.			
6	1	STATIONARY ROD, 42"			
7	1	METER CAN, 20" O.D. x 30" DEPTH, SONOLOC			
8	1	METER CAN COVER W/ DOUBLE LID (FROST PLATE) FOR 20" O.D. CAN, CASTING M-70			
9	1	3/4" x 6" NIPPLE, BRASS			
10	1	SADDLE, BRASS, 3/4" TAP x APPROPRIATE PIPE O.D. SIZE			
11	3 CF*	1" TO 2" FILTER ROCK			
12	1	ADAPTER, 3/8" MIPT x 1/2" COMPRESSION			
*CF =	CUBIC	FEET			

UA
UA
JA
/08
2
ter Standard
S-10.DWG

NAVAJO TRIBAL UTILITY AUTHOR no civil encommence deplacation?	ITY
AIR RELEASE	
VALVE DETAIL	
HQ-ENGINEERING	FT.DEFIANCE, AZ

		REVISIONS	
No.	Date	Brief	Ву
01	04/08	Revised	L.H.
02			
03			
04			
05			
06			



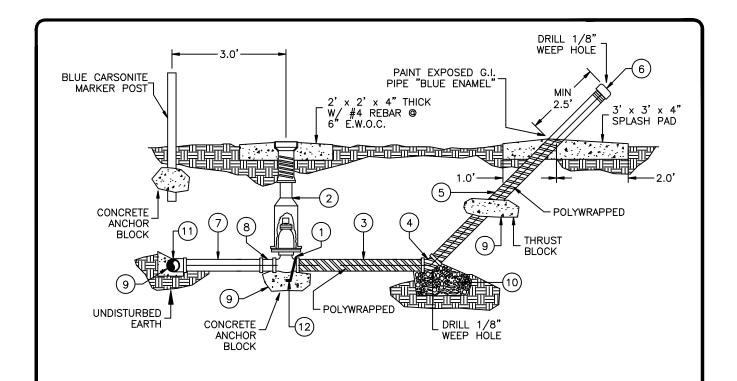


	MATERIAL LIST				
ITEM	QUAN	DESCRIPTION			
1	1	2' GATE VALVE, C.I., FIPT, RW, NRS, RHT, W/ 2' OPERATING NUT, MUELLER A-2360-37			
2	1	VALVE BOX, SCREW-TYPE, C.I., 2 PIECE, 5 1/4" SHAFT, TYLER 6850			
3	1	2" x 3' PIPE (MIN.), G.I., COATED OR POLYWRAPPED			
4	1	2" x 45' ELBOW, G.I., W/ 1/8" WEEP HOLE			
5	1	2" PIPE, G.I. x CUT TO LENGTH AS NEEDED			
6	1	2" CAP, G.I. W/ 1/8" VENT HOLE			
7	1	2" PIPE, PVC CUT TO LENGTH AS NEEDED			
8	1	2" ADAPTER, PVC, SLIP-GASKET x MIPT, SDR-21			
9	A.R.	CONCRETE THRUST BLOCK, (DO NOT COVER JOINTS OR BOLTS), MIN. 1.5 CUBIC FEET			
10	1.5 CF	CLEAN GRAVEL			
11	1	MAIN LINE SADDLE OR TEE			
12	A.R.	#4 REBAR			

DESIGNED BY:	NTUA
SURVEYED BY:	
DRAWN BY:	NTUA
APPROVED BY:	NTUA
DATE:	04/08
PROJECT NO.	
SCALE:	NTS
ACAD FILENAME:	Water Standard
DWG. NO.	WS-11.DWG



$\overline{}$		REVISIONS	
No.	Date	Brief	Ву
01	04/08	Revised	L.H.
92			
03			
04			
05			
06			



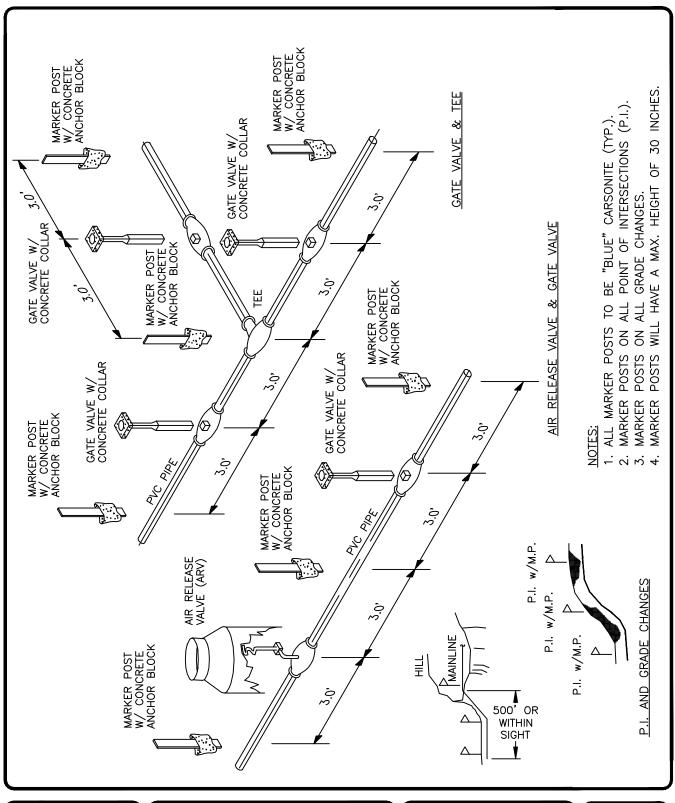

DESIGNED BY:	NTUA
SURVEYED BY:	
DRAWN BY:	NTUA
APPROVED BY:	NTUA
DATE:	04/08
PROJECT NO.	
SCALE:	NTS
ACAD FILENAME:	Water Standard
DWG. NO.	WS-13.DWG

NAVAJO TRIBAL UTILITY AUTHORITY


MARKER POST

DETAILS

-ENGINEERING FT.DI

REVISIONS					
Date	Brief	Ву			
04/08	Revised	L.H.			
	·				
		Date Brief			



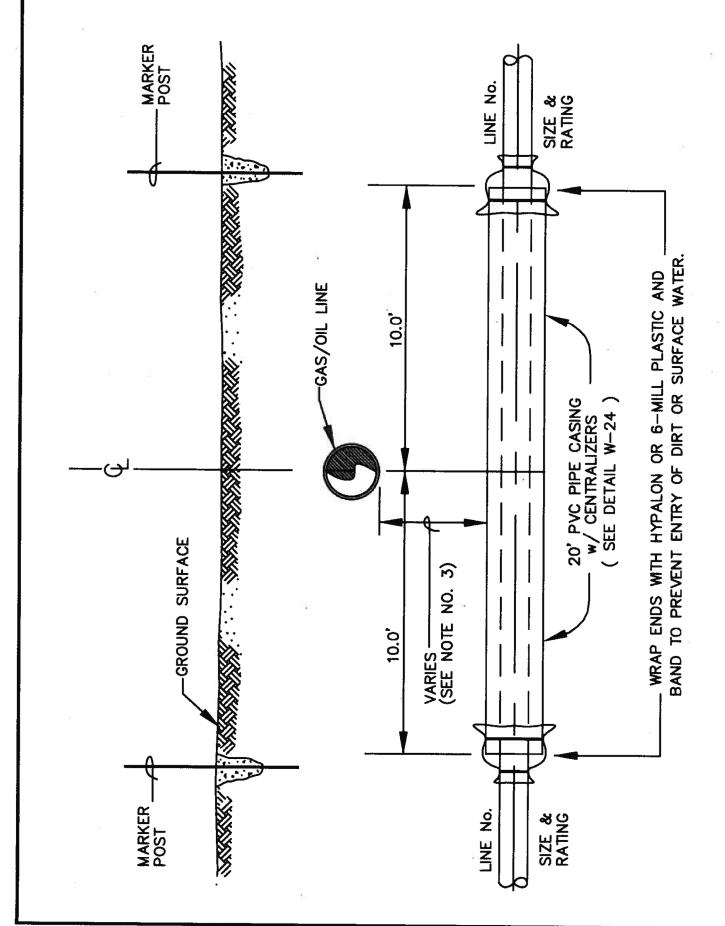


LINE-XING /OIL NOT TO SCALE GAS/ OF PROFILE


NOTES:

- - S
- UTILITY CROSSING PERMITS ARE REQUIRED FROM THE GAS OR OIL COMPANY. CASING SHOULD BE PVC SO AS NOT TO INTERFERE WITH GAS/OIL LINE CATHODIC PROTECTION.

 MINIMUM SEPARATION BETWEEN THE GAS/OIL LINE AND THE WATER LINE CASING IS 24" PER DEPT. OF TRANSPORTATION REGULATIONS. HOWEVER, ACTUAL DEPTH OF BURY AND PLACEMENT OF THE WATERLINE (ABOVE OR BELOW GAS/OIL LINE) SHOULD BE IN ACCORDANCE WITH THE CONDITIONS SET FORTH IN THE INDIVIDUAL UTILITY CROSSING PERMIT ISSUED BY THE GAS/OIL PIPELINE COMPANY. Ŋ

B.M.	BY	i de	ω	
		AN SERVICES	O. W-18	ENGINEERING ARIZONA
STANDARDIZED	BRIEF	U.S. DEPARTMENT OF HEALTH AND HUMAN SERVICES PUBLIC HEALTH SERVICE INDIAN HEALTH SERVICE NAVAJO NATION	STANDARD DRAWING NO. W-13 GAS/OIL LINE CROSSING	OFFICE OF ENVIRONMENTAL HEALTH AND ENGINEERING NAVAJO AREA OFFICE, WINDOW ROCK, ARIZONA DRAWN RV. 1.8 CHECKEN DV. D. 8 ATROCAN
2/99	DATE	S. DEPARTMENT PU INI	NDARD GAS/OIL	TCE OF ENVIRON NAVAJO ARRA (
	REVISION	Ö	STA	MA VIEVOU

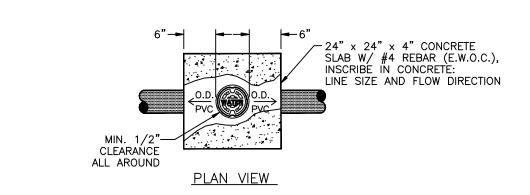

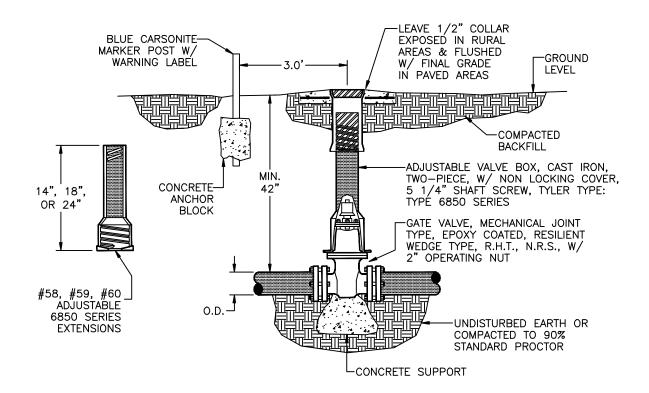

NOTES:


- 1. IF APPROPRIATE, USE SERIES 2000 PV MEGALUG GLANDS FOR SDR-21, PVC TO SECURE GATE VALVE(S) TO OTHER FITTINGS/PIPE, USE OTHER MEGALUGS FOR DIFFERENT OUTSIDE DIAMETER PIPE/TYPE.
 2. DO NOT COVER JOINTS AND BOLTS WITH CONCRETE.
- 3. SEE WS-13 FOR APPROPRIATE LOCATION OF MARKER POST.

DESIGNED BY:	NUTTURA
	NTUA
SURVEYED BY:	
DRAWN BY:	NTUA
APPROVED BY:	NTUA
DATE:	04/08
PROJECT NO.	
SCALE:	NTS
ACAD FILENAME:	Water Standard
DWG. NO.	WS-14.DWG

NAVAJO TRIBAL UTILITY AUTHORITY WATER MAIN VALVE INSTALLATION FT.DEFIANCE, AZ


		REVISIONS	
No.	Date	Brief	Ву
01	04/08	Revised	L.H.
02			
03			
04			
05			
06			Ι.
=			



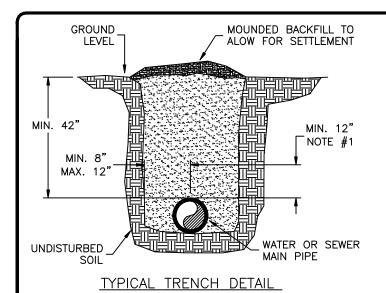


NOTES:

- HAND COMPACTED IN 6" LIFTS FROM BOTTOM OF TRENCH TO 12" ABOVE PIPE CROWN.
- 2. OPEN CUT OR PAVED OR GRAVEL ROADS (IF REQUIRED), BACK FILL MINIMUM COMPACTION 95% OPTIMUM DENSITY IN LIFTS.
- 3. REPAVING AND REGRAVELING WILL BE DONE TO ROAD OWNER'S REQUIREMENTS.
- 4. KEEP LOWER 5' OF TRENCH WALL VERTICAL IF POSSIBLE. UPPER PART OF THE TRENCH WILL VARY IN WIDTH TO COMPENSATE FOR UNSTABLE SOIL. APPLICABLE O.S.H.A. REQUIREMENTS SHALL BE MET.

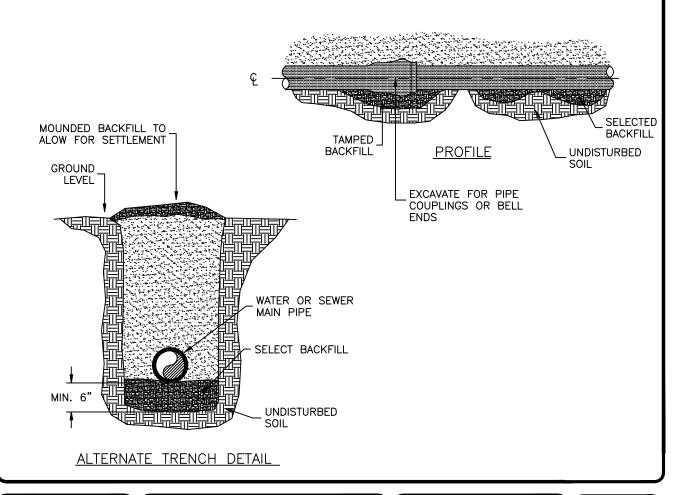


DESIGNED BY:	NTUA
SURVEYED BY:	NIOA
DRAWN BY:	NTUA
APPROVED BY:	NTUA
DATE:	04/08
PROJECT NO.	04,00
SCALE:	NTS
ACAD FILENAME:	Water Standard
DWG. NO.	WS-15.DWG

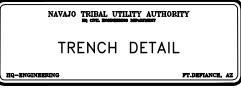

		REVISIONS	
No.	Date	Brief	Ву
01	04/08	Revised	L.H.
02			
03			
04			
05			
06			



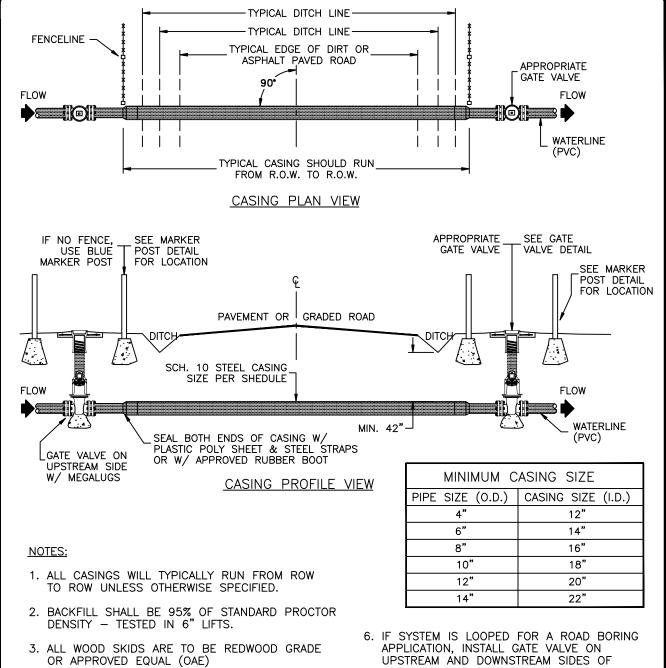

- ROADWAY.
- 7. DUCTILE IRON SHALL BE CLASS 50.
- 8. DUCTILE IRON ROAD CROSSING IN B.I.A. RURAL AREAS SHALL BE FROM 10' BEYOND DITCH LINE UNLESS OTHERWISE SPECIFIED.

SHEET 1 OF 2

DESIGNED BY:	NTUA
SURVEYED BY:	
DRAWN BY:	NTUA
APPROVED BY:	NTUA
DATE:	04/08
PROJECT NO.	
SCALE:	NTS
ACAD FILENAME:	Water Standard
DWG. NO.	WS-17a.DWG

4. ALL SKIDS WILL BE SECURELY FASTENED TO PIPE WITH STAINLESS STEEL STRAPS.

PAVEMENT AND OPEN TRENCH ON REMAINDER,


5. ROAD SHALL BE BORED UNDER EXISTING

UNLESS OTHERWISE SPECIFIED.


NAVAJO TRIBAL UTILITY AUTHORITY TYPICAL ROAD CROSSING FOR NTUA WATERLINES

No. Date Brief By 11 04/08 Revised L.H. 12 03 04 05 05 06 06 06 06 06 06 06 06 06 06 06 06 06	l(REVISIONS	
02 03 04 05	No.	Date	Brief	Ву
03 04 05	01	04/08	Revised	L.H.
04 05	02			
05	03			
	04			
ne l	05			
(00)	06			



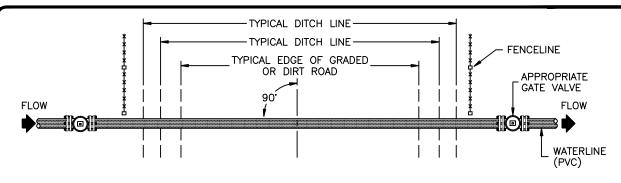

DUCTILE-IRON CROSSING PLAN VIEW

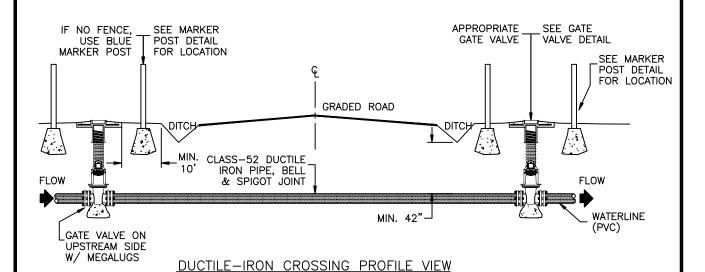

NOTES:

- 1. ALL CASINGS WILL TYPICALLY RUN FROM ROW TO ROW, UNLESS OTHERWISE SPECIFIED.
- 2. BACKFILL SHALL BE 95% OF STANDARD PROCTOR DENSITY TESTED IN 6" LIFTS.
- 3. ALL WOOD SKIDS ARE TO BE REDWOOD GRADE OR APPROVED EQUAL (OAE)
- 4. ALL SKIDS WILL BE SECURELY FASTENED TO PIPE WITH STAINLESS STEEL STRAPS.
- ROAD SHALL BE BORED UNDER EXISTING PAVEMENT AND OPEN TRENCH ON REMAINDER, UNLESS OTHERWISE SPECIFIED.
- 6. IF SYSTEM IS LOOPED FOR A ROAD BORING APPLICATION, INSTALL GATE VALVE ON UPSTREAM AND DOWNSTREAM SIDES OF THE ROADWAY.
- 7. DUCTILE IRON SHALL BE CLASS 52.
- 8. DUCTILE IRON ROAD CROSSING IN B.I.A. RURAL AREAS SHALL BE FROM 10' BEYOND DITCH LINE UNLESS OTHERWISE SPECIFIED.


SHEET 2 OF 2


DESIGNED BY:	NTUA
SURVEYED BY:	
DRAWN BY:	NTUA
APPROVED BY:	NTUA
DATE:	04/08
PROJECT NO.	
SCALE:	NTS
ACAD FILENAME:	Water Standard
DWG. NO.	WS-17b.DWG

TYPICAL ROAD CROSSING FOR NTUA WATERLINES

\bigcap		REVISIONS	
No.	Date	Brief	Ву
01	04/08	Revised	L.H.
02			
03			
04			
05			
06			



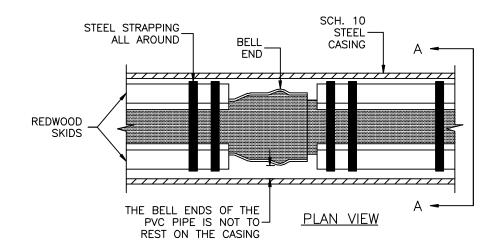

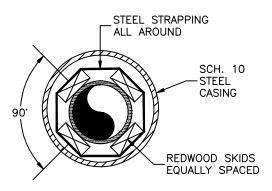

SECTION A-A

NOTES:

- 1. ALL SKIDS SHALL RUN THE LENGTH OF THE PVC PIPE, BELL TO BELL.
- 2. ALL SKIDS TO BE REDWOOD LUMBER, OR APPROVED EQUAL.
- 3. BELL AND SPIGOT DUCTILE IRON PIPE MAY BE INSTALLED DIRECTLY WITHIN THE CASING.
- 4. TYPICAL ROAD BORES BY NAVAJO ENGINEERING AND CONSTRUCTION AUTHORITY ARE 8" AND 14" CASING SIZES.
- 5. ALL STRAPPING MUST BE STAINLESS STEEL AND BE SECURELY FASTENED TO THE PVC CARRIER PIPE FOR PROPER SUPPORT OF PIPE DURING INSTALLATION.
- SEAL ENDS OF CASING W/ PLASTIC POLY SHEET AND STAINLESS STEEL STRAPS OR AN APPROVED RUBBER BOOT.

MINIMUM C	ASING SIZE
PIPE SIZE (O.D.)	CASING SIZE (I.D.)
4"	12"
6"	14"
8"	16"
10"	18"
12"	20"
14"	22"

DESIGNED BY:	NTUA
SURVEYED BY:	
DRAWN BY:	NTUA
APPROVED BY:	NTUA
DATE:	04/08
PROJECT NO.	
SCALE:	NTS
ACAD FILENAME:	Water Standard
DWG. NO.	WS-18.DWG

NAVAJO TRIBAL UTILITY AUTHORITY

INSTALLATION OF SKIDS


INSIDE CASING

Q-ENGINEERING

PT.DEFFANCE, AZ


\cap		REVISIONS	
No.	Date	Brief	Ву
01	04/08	Revised	L.H.
02			
03			
04			
05			
06			



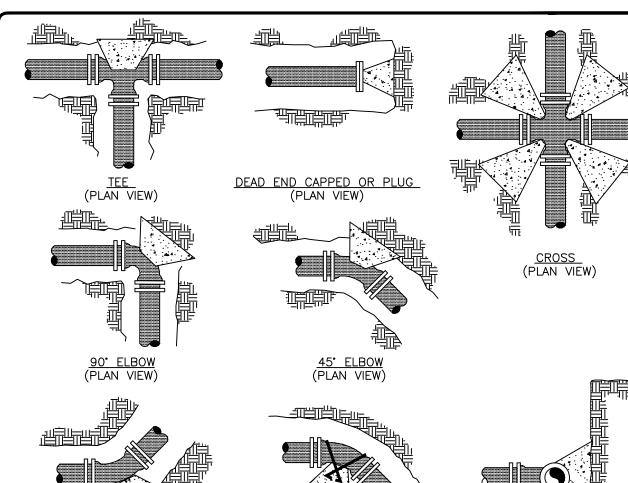

VERTICAL BENDS (SECTION VIEW)

VERTICAL GRAVITY THRUST BLOCK (SECTION VIEW)

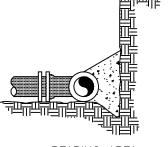

BEARING AREA (SECTION VIEW)

NOTES:

1. DO NOT COVER GASKETED JOINTS AND NUTS/BOLTS.

	MINIMUM BEA	ARING AREAS	S IN SQUARE FEET	
PIPE SIZE	TEE & PLUG	90° ELBOW	45° OR 22 1/2° ELBOW	CROSS
2"	0.5	0.5	0.5	0.5
4"	1.5	2.0	1.5	1.0
6"	3.0	4.5	2.5	2.0
8"	5.0	7.5	4.0	4.0
10"	8.0	11.0	6.5	5.5
12"	11.0	15.5	9.0	8.0
14"	15.0	21.0	12.0	10.5
16"	19.0	27.0	15.5	13.5
18"	24.0	34.0	19.0	17.0

SHEET 1 OF 2

	_
DESIGNED BY:	NTUA
SURVEYED BY:	
DRAWN BY:	NTUA
APPROVED BY:	NTUA
DATE:	04/08
PROJECT NO.	
SCALE:	NTS
ACAD FILENAME:	Water Standard
DWG. NO.	WS-19.DWG

NAVAJO TRIBAL UTILITY AUTHORITY **GRAVITY/THRUST** BLOCK DETAILS

		REVISIONS	$\overline{}$
No.	Date	Brief	Ву
01	04/08	Revised	L.H.
02			
03			
04			
05			
06			oxdot



GRAVITY THRUST BLOCK

(ALSO TO BE USED IN UNSTABLE TRENCH CONDITIONS)
RESULTANT THRUST IN POUNDS OF FITTINGS AT 100 PSI WATER PRESSURE

		TO	TAL POUNDS		
PIPE SIZE	DEAD END	90° ELBOW	45° ELBOW	22 1/2° ELBOW	11 1/4 ELBOW
3"	1,232	1,742	943	481	241
4"	1,810	2,559	1,385	706	355
6"	3,739	5,288	2,862	1,459	733
8"	6,433	9,097	4,923	2,510	1,261
10"	9,677	13,685	7,406	3,776	1,897
12"	13,685	19,353	10,474	5,340	2,683
14"	18,385	26,001	14,072	7,174	3,604
16"	23,799	33,628	18,199	9,278	4,661
18"	29,865	42,235	22,858	11,653	5,855
20"	36,644	51,822	28,046	14,298	7,183
24"	52,279	73,934	40,013	20,398	10,249
30"	80,425	113,738	61,554	31,380	15,766
36"	115,209	162,931	88,177	44,952	22,585
42"	155,528	219,950	119,036	60,684	30,489
48"	202,683	286,637	155,127	79,083	39,733
54"	260,214	367,999	199,160	101,531	51,011
60"	298,121	421,606	228,172	116,321	58,442
64"	338,707	479,004	259,235	132,157	66,398

NOTES:

- 1. THE THRUST (IN TOTAL POUNDS) IN THE CHART IS BASED ON DUCTILE IRON OUTSIDE DIAMETER PIPE DIMENSION. SURGES SHOULD BE CONSIDERED AT TWICE THE NORMAL OPERATING PRESSURE. THE VOLUME OF THE GRAVITY THRUST BLOCK IS BASED ON CONCRETE AT 150 LBS./FT3.
- 2. TO OBTAIN VOLUME OF CONCRETE REQUIRED, USE: VOLUME OF CONRETE(FT3)= THRUST(LBS.) x SYSTEM PRESSURE(PSI)/100 PSI // 150 LBS./FT3.

E.G.: CALCULATE THE VOLUME OF THE GRAVITY THRUST BLOCK FOR AN 8" x 45" BEND AT AN OPERATING PRESSURE OF 80 PSI.

ANSWER: 4923 LBS. \times 160 PSI/100 PSI DIVIDED BY 150 LBS./CUBIC FT. = 52.5 CUBIC FEET OR 2 CUBIC YARDS.

SHEET 2 OF 2

DESIGNED BY: NTUA SURVEYED BY: DRAWN BY: NTUA
DRAWN DV: NTUA
DICAMIN BI. NIOA
APPROVED BY: NTUA
DATE: 04/08
PROJECT NO.
SCALE: NTS
ACAD FILENAME: Water Standard
DWG. NO. WS-19a.DWG

NAVAJO TRIBAL UTILITY AUTHORITY

GRAVITY/THRUST


BLOCK CHART


Q-ENGINEERING

PT.DEFIANCE, A2


		REVISIONS	\neg
No.	Date	Brief	Ву
01	04/08	Revised	L.H.
02			
03 04			
05			
06			oxdot



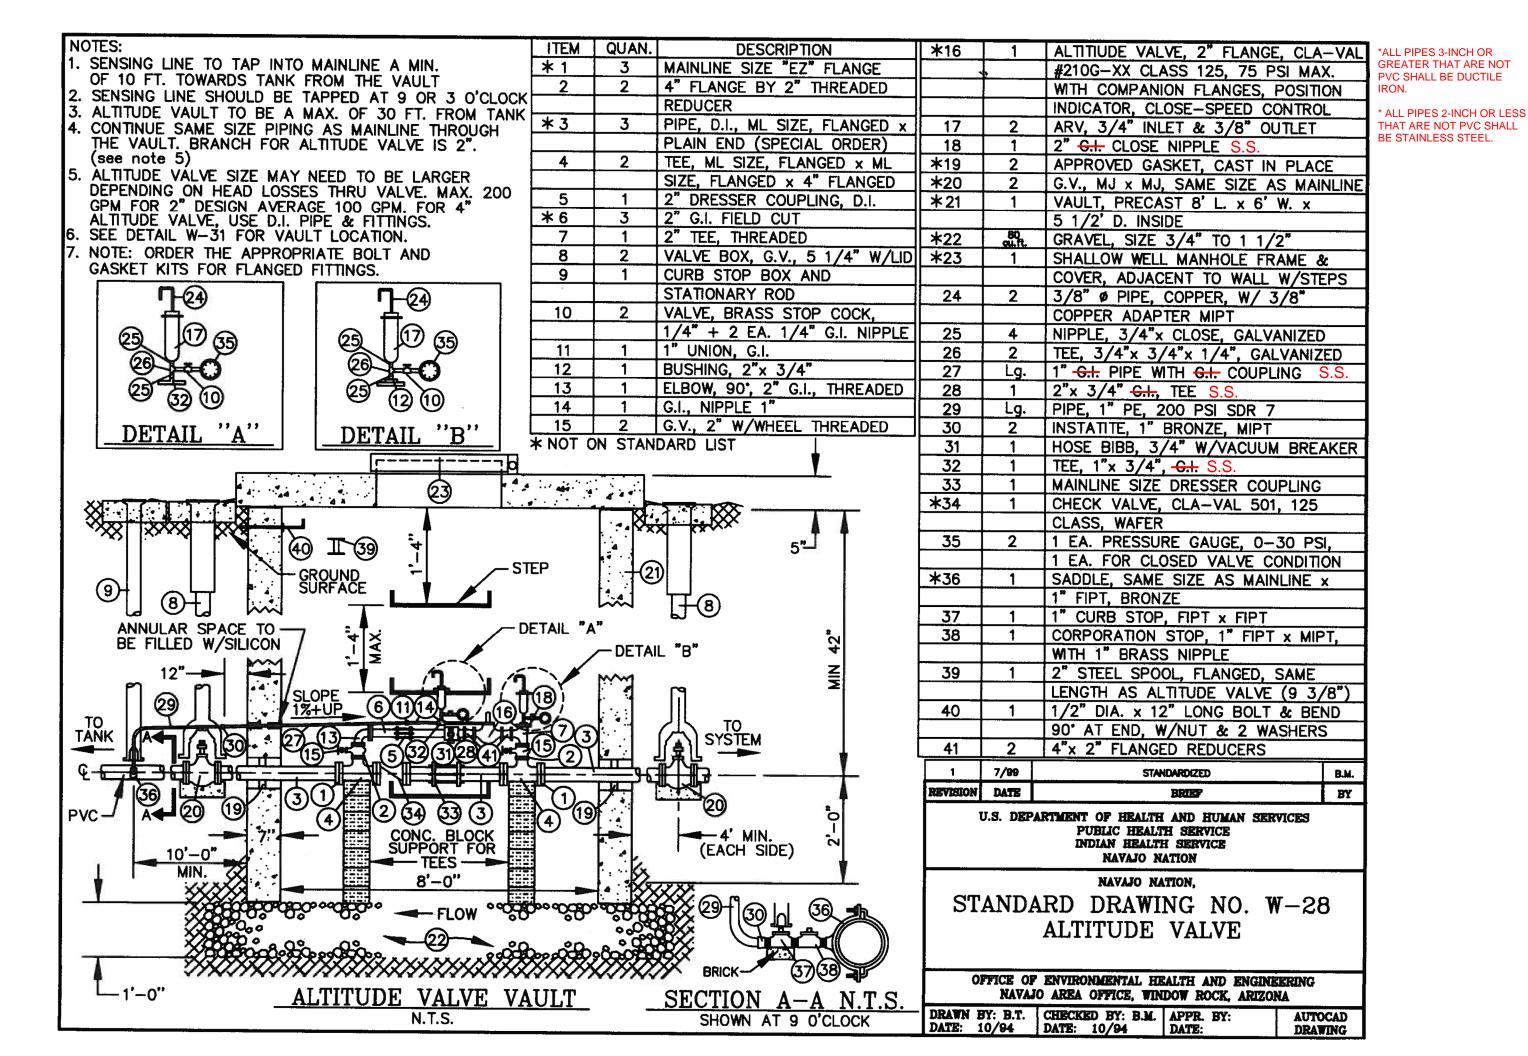

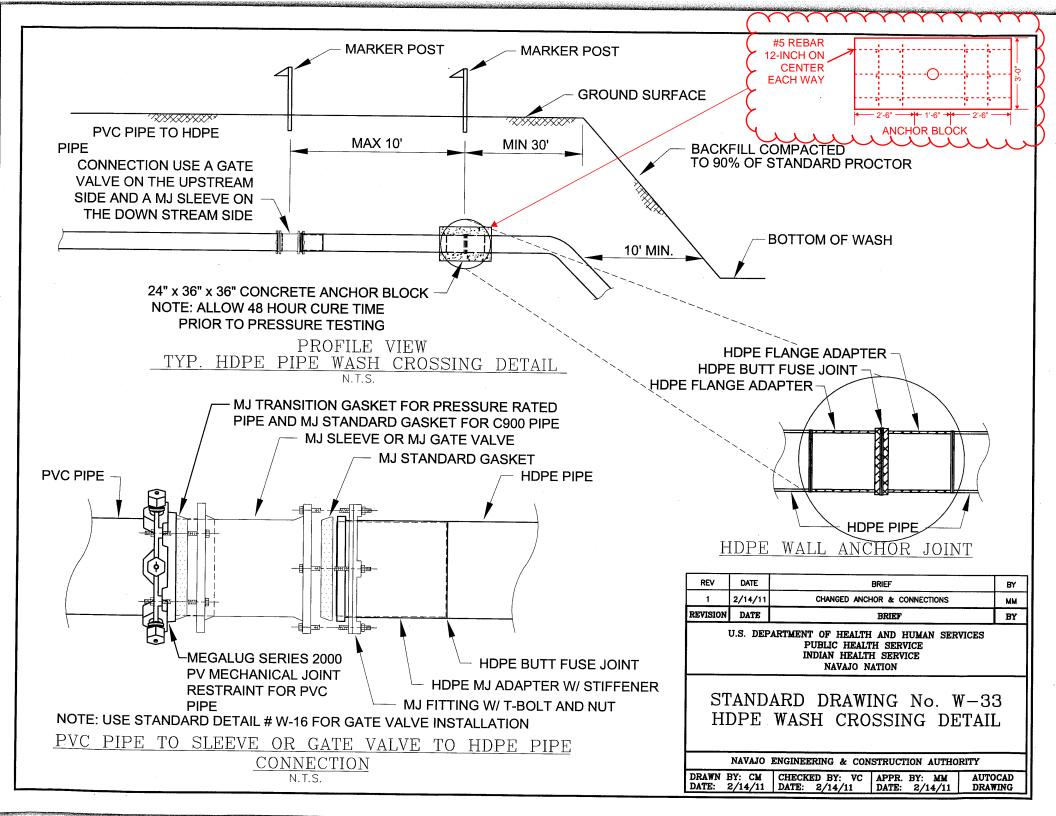


SILT FENCE DETAILS

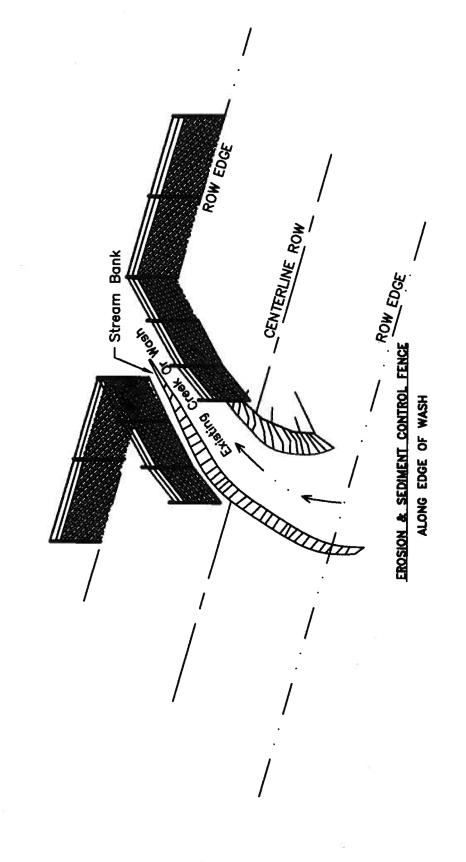


INSTALLATION NOTES

1. THE SILT FENCING CONSISTS OF 3' SEDIMENT CONTROL FABRIC CLOTH WITH BURIED-TOE AND WOODEN OR STEEL POSTS (TEE OR U TYPE) 10' AND SHALL COMPLY WITH AASHTO M-288.


2. WHEN TWO SECTIONS OF FILTER CLOTH ADJOIN EACH OTHER THEY SHALL BE OVERLAPPED BY 6" AND FOLDED. MAINTENANCE SHALL BE PERFORMED AS NEEDED AND MATERIAL REMOVED WHEN "BULGES" DEVELOP IN THE SILT FENCE.

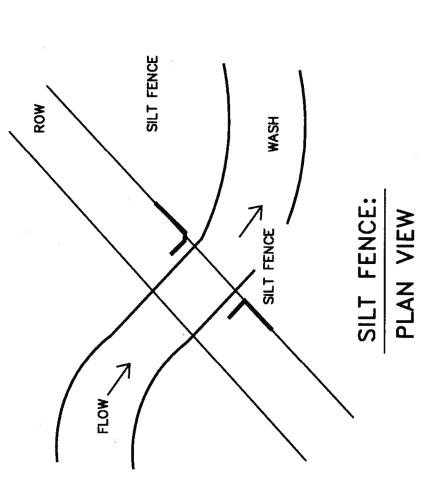


REMSION	DATE		8667	E
图	PARTMENT U.	C OF HEAL S. PUBLIC	DEPARTMENT OF HEALTH AND HUMAN SERVICES U.S. PUBLIC HEATH SERVICE	
	258	INDIAN HE	NDIAN HEALTH SERVICE MAVAJO NATION	Ø.
		HAVAJ	NAVAJO NATION	
™	[ANDA]	RD DRA	STANDARD DRAWING NO. W-39 SILT FENCE	39
	•	DRAWI	DRAWING 1 OF 2	
		PUBLIC	PUBLIC LAW 86-121	
OFFICE NA	E OF ENVI	RONMENTA EA OFFICE,	OFFICE OF ENVIRONMENTAL HEALTH AND ENGINEERING NAVALO AREA OFFICE, WINDOW ROCK, ARIZONA	ERUNG
DELATE BY IL. DATE 9/01		CERCIE STR RG	METE STR BE	ACTOCAD

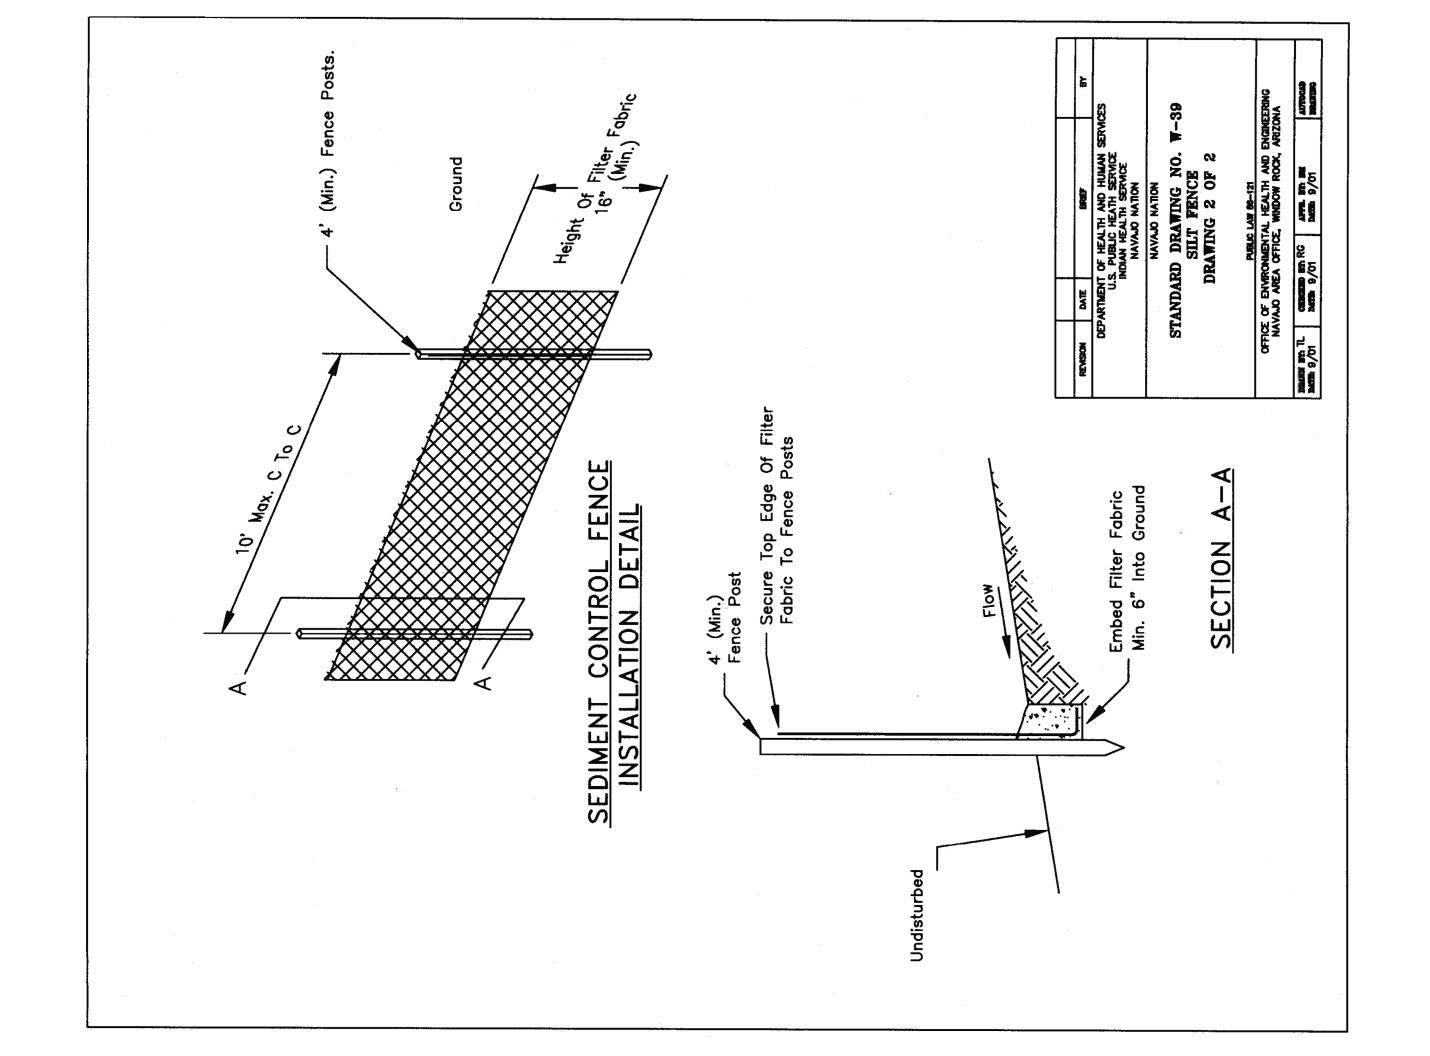

Sediment) and Water **DETAILS** BALE D Retain STRAW Dams Check (For

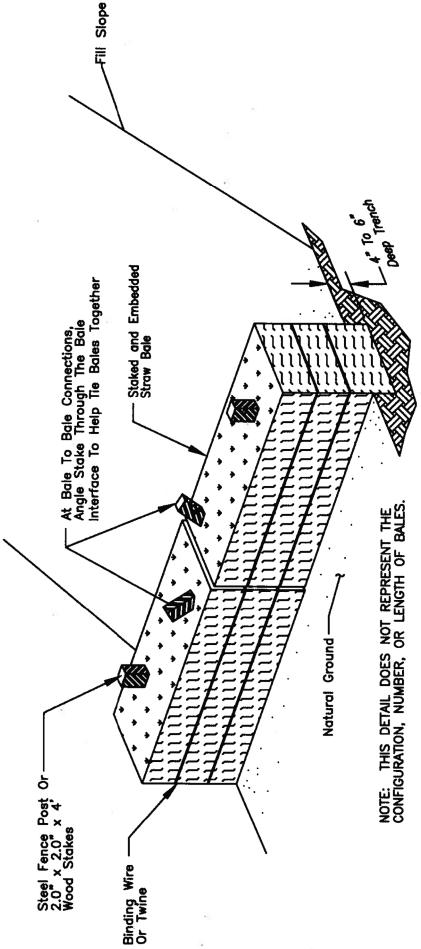

TYPICAL STRAW BALE STAKING AND TRENCHING DETAIL

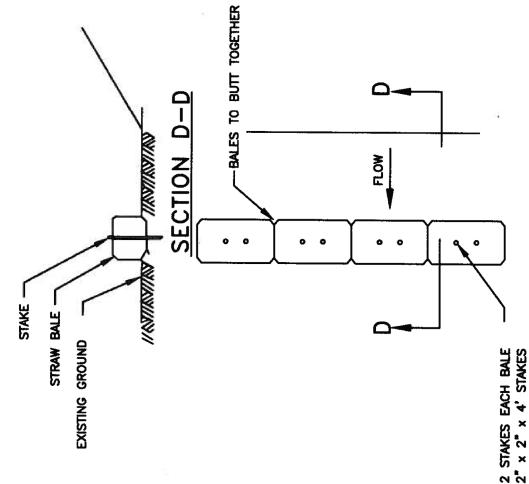

STRAW BALE SILT BARRIER

PLAN

INSTALLATION NOTES

1. STRAW BALES MAY BE USED FOR DIKES PROVIDED THEY ARE PROPERLY ANCHORED WITH STEEL FENCE POSTS OR 2" X 2" X 4" WOOD STAKES (TWO PER BALE) ANCHORED 1.5' INTO THE NATURAL GROUND. STRAW BALES SHALL BE CERTIFIED 0.5% WEED FIRE. DO NOT USE STRAW BALES IN AREAS OF CONCENTRATED FLOW AND CUT DITCHES.

GENERAL NOTES

- 1. THE CONTRACTOR SHALL HAVE ON-SITE A COPY OF THE STORM WATER POLLUTION PREVENTION PLAN (SWPPP) WITH PROJECT SPECIFIC COVER SHEET.
- 2. CONSTRUCT CHECK DAMS AND/OR FILTERS IN STRATEGIC LOCATIONS ON THE PROJECT TO FILTER STORM RUNOFF BEFORE IT LEAVES THE PROJECT CONSTRUCTION LIMITS OR ENTERS A WASH. SEE PROJECT CONSTRUCTION PLANS FOR LOCATIONS OF CHECK DAMS & FILTERS.
 - 3. CLEAN ALL SEDIMENT BASIN AND TRAPS OF ACCUMULATED SEDIMENT WHEN HALF FULL OF SEDIMENT.
- 4. THE CONTRACTOR SHALL INSPECT AND MAINTAIN ALL SWPPP MEASURES MONTHLY AND AFTER EACH SIGNIFICANT STORM EVENT (I.E. 0.5 IN. OF MOISTURE IN 24 HOURS).
- 5. THE CONTRACTOR, IN CONSULTATION WITH THE PROJECT ENGINEER SHALL ADJUST THE DIMENSIONS AND/OR LOCATIONS OF TEMPORARY SEDIMENT AND EROSION CONTROL DEVICES TO FIT ACTUAL FIELD CONDITIONS. ALL ADJUSTMENTS WILL BE DOCUMENTED ON THE INSPECTION FORMS INCLUDED WITH THE SWPPP.
 - 6. REMOVE AND DISPOSE OF EROSION CONTROL MEASURES WHEN THE PERMANENT EROSION CONTROL MEASURES ARE SATISFACTORILY ESTABLISHED.

È	Э×				
	 ස	2		ERING TA	AUTOCAN
1308	DEPARTMENT OF HEALTH AND HUMAN SERVICES U.S. PUBLIC HEATH SERVICE INDIAN HEALTH SERVICE NAVAJO NATION	NAVAJO NATION STANDARD DRAWING NO. W-40 STRAW BALES	PUBLIC LAW 88-121	OFFICE OF ENVIRONMENTAL HEALTH AND ENGINEERING NAVAJO AREA OFFICE, WINDOW ROCK, ARIZONA	en RG AFFE en sec Of Bern 9/Of
DATE		ANDAF		OFFICE OF ENVE NAVAJO ARE	DATE 9/01
REVISION		S			Determ with TL Determ 9/01