DRAWING INDEX

SHEET 1: SPECIFICATIONS AND CONDITIONS

SHEET 2: FLOOR PLAN, PLUMBING LEGEND, STRUCTURAL LEGEND, WINDOW AND DOOR SCHDULE, AND

PLUMBING SCHEMATICS

SHEET 3: ELECTRICAL PLAN, ELECTRICAL LEGEND,

ELECTRICAL PANEL LEGEND

Additional Roof Items Included in Quoted Price: Item 1: LUS28 joist hangars @ Modlines Only

SHEET 4: REFLECTED CEILING PLAN, HVAC PLAN, HVAC

SHEET 5: BUILDING CROSS-SECTION, MISC. DETAILS

SHEET 6: ELEVATIONS

DEALER:

DESIGN MODULARS

PROJECT:

TUBA CITY PHYSICIAN BUILDING 36' X 60' PMI-5338-3660

FRAME / CHA	ASSIS:	FINISHES:	
Frame Type:	Basement (CH2)	FLOOR COVERING:	
Quantity:	(3) EA	Type 1:	1/8" V.C.T. Tile to be 50% OFFSET.
Size:	11'-10" X 60'-0"		Hold back tile (5 <u>1/2"</u>) at each side of the matelines.
Туре:	Outrigger @ 48" O.C.		Location: (Throughout)
.,,,,,,,,,,,,,,,,,,,,,,,,,,,,,,,,,,,,,,	Crossmember @ 96" O.C.	2405	Color to be: ()
	Module line Clips @ 96" O.C.	BASE:	
	Main Rails @ 99 1/2" O.C.	Cove Base 1 :	4" Vinyl cove.
Beam Size:	12" Jr. I-beam		Location: (<u>Throughout</u>)
Axles:	12 di.i-bealii		Color to be: ()
	Oty: Ouad 6000# rated with (All) brake	WALLS:	
Module 1:	Qty: Quad 6000# rated with (All) brake	Covering 1:	1/2" vinyl covered gypsum
Madulas 0.0	Offset: 4" (Toward sidewall / See detail 5/5)		Location: (<u>Throughout</u>)
Modules 2,3:	Qty: Quad 6000# rated with (All) brake		Covering height: 8'
115.1	Offset: None		Color to be: ().
Hitch:	Detachable with Standard Hitch	Covering 2:	Standard FRP panels (per code)
Tires:	8x14.5 14 ply rated		Location: (Restrooms and mop sink)
			Covering height: 4'
Additional Frame /	Chassis Items Included in Quoted Price:		Color: (White)
Item 1: No	ne	TRIM:	
FLOOR CONS	STRUCTION:	Wall Trim 1:	Vinyl Covered trim
			Color to be: (To match VCG)
Floor Joist:	2X8 #2 HF equal or better	CEILING:	
Joist Length:	135-7/8"	Type 1:	2'x4' T-Grid
Joist Spacing:	16" O.C.		(Armstrong Tile #769A or Equal)
Floor:	Single layer 3/4" T&G Plywood.		Height: 7'-10"
Insulation:	R-30 unfaced fiberglass batt (2-layer of R-15)	Installed at factory, held	d back at module lines.
Bottom:	Reinforced Plastic	Completion of ceiling in	nstallation on-site by others; not in PMI's scope.
A -l -liki	Instituted in Occated Drive.		
	Included in Quoted Price:	EXTERIOR	
Item 1: No	ne	Siding body:	Color: () 8' sheets
EXTERIOR W	ALL CONSTRUCTION:	Hood:	Color: ()
		Corner trim:	Color: ()
Framing:		Door & window trim:	Color: ()
	Top Plate: Double 2X6 #2 HF equal or better	Bottom horizontal trim:	Color: ()
	Bottom Plate: Single 2X6 #2 HF or better	Intermediate horizontal	trim: Color: () separates hood & body
	Header: (3) 2x4 header with (2) 1/2" shim at all exterior openings (UNO)	Top horizontal trim:	Color: ()
Insulation:	R-21 Kraft back fiberglass batt	Module line trim:	Color: (Match hood above intermediate horizontal trim & match body below)
Siding Type:	3/8" LP Smart-panel vertical siding (8" grooves) with barricade wrap underlayment.	All paint to be:	Satin Finish (Glidden)
Sidewall Height:	See cross section for heights		
Additional Exterior	Wall Itama Included in Quated Price:	EXTERIOR/INTE	ERIOR DOORS: (SEE DOOR SCHEDULE)
Item 1: No	Wall Items Included in Quoted Price:		
nem i. No			(SEE WINDOW SCHEDULE)
INTERIOR WA	ALL CONSTRUCTION:	WINDOWS.	OLE WINDOW GOTTEBOLE)
	Stud: 2X4 #2 HF equal or better @ 16" O.C.		
Framing:	,	CLOSEUP:	
	Top plate: Single 2X4 #2 HF equal or better (Double as needed)	Type: Me	edium
	Bottom plate: Single 2X4 #2 HF or better bottom plate		odule <u>WILL</u> exceed 12'-0" (Including door hardware)
	Stud length: 92-5/8" (Ceiling Ht.)		
Insulation:	NONE PROVIDED		
		APPLIANCES:	
Additional Interior V	Wall Items Included in Quoted Price:		
Item 1: No	ne	None provided	
DOOF 00110			
ROOF CONS	IRUCTION:		
Roof Type:	Complex	ACCESSORIES	;
Roof Slope:	1/4 in 12	Base Cabinets: 5	L.F.
Rafter size:	2X10 #2 HF equal or better	_	olor: Pre-Finish (Maple Rye)
	(Roof diaphragm chord strap 'ST2215' at rafters installed on-site, see 4/5)		LF of 25-1/2" wide Laminate Countertop
Rafter Length:	Mod 1,3: 135 1/8"	_	acksplash: 4"
J	Mod 2: 131 1/4"		dge Type: Rolled
Spacing:	24". O.C. (Sheathing clips required)		olor: (TBD)
Mate Beam:	Steel clearspan web truss with (wood) columns at each end)(or. (1997)
Height:	22 1/2" to 30" to 22 1/2"		
•	60'		
Length:			
No. of Beams:	6		
Insulation:	R-38C unfaced fiberglass batt with support netting		
Sheathing:	5/8" 24/0 Sheathing		
Roofing:	45 mil single ply EPDM over 1/2" Gypsum		
	Color: White		

STATE REQUIRED INFORMATION ON USE AND LOCATION OF FACTORY-BUILT BUILDING

. PROPOSED ADDRESS <u>167 MAIN STREET</u>

AND/OR LOCATION OF UNIT. TUBA CITY, AZ, 86045 EXPLANATION OF

BUILDING USE.

. SET TYPE

PAD/PIER ABOVE GRADE ASSUMED F.F. TO BE 36" A.F.G

MANUFACTURER: MANUFACTURER & ADDRESS

PHOENIX MODULAR 5301 W. MADISON ST. PHOENIX, AZ. 85043 SEE WEBSITE FOR WARRANTY INFORMATION) PHOENIXMODULAR.COM

DESIGN CRITERIA / LOADS:

BUILDING SQ.FT. YPE OF CONSTRUCTION. OCCUPANCY USE GROUP. OCCUPANCY LOAD. FLOOR LIVE LOAD. 50 psf. (2000 lb concentrated (100 psf. @ corridor) ROOF LIVE LOAD. ROOF DEAD LOAD. 12 psf.

OCCUPANCY/RISK CATG. SEISMIC

ROOF SNOW LOAD.

WIND LOAD.

NO OF MODULES.

Ss=0.4, S1=0.12 Site Class 'D' Design Category 'C'

2018 IBC - 115 MPH, EXP. (

PERMISSIBLE GAS TYPE. CLIMATE ZONE.

NAME AND DATE OF CODES; AZ: 2018 IBC, 2018 IPC, 2018 IMC, 2017 NEC, 2018 IECC, AND ICC A117.1-2009

MODUL

B

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DEALER: DESIGN MODULARS

PROJECT: TUBA CITY PHYSICIAN BUILDING

SPECIAL CONDITIONS AND OR **LIMITATIONS:**

SPRINKLERS REQUIRED. NO

MODEL NUMBER:

STATES: ΑZ

RED TAG:

SERIAL NUMBERS: PMI-5338-3660

DRAWN BY:

CK/MM

PLOT DATE:

NOT INCLUDED IN SCOPE OF WORK

PORCHES, STEPS, AND RAMPS TO BE SUPPLIED AND INSTALLED BY OTHERS IN ACCORDANCE WITH THE LOCAL BUILDING DEPARTMENT

PORTABLE FIRE EXTINGUISHERS TO BE SUPPLIED AND INSTALLED ON SITE BY OWNER IN ACCORDANCE WITH LOCAL BUILDING DEPARTMENT

ACCESSIBLE DRINKING FOUNTAIN TO BE PROVIDED ON SITE BY OWNER LOCATED WITHIN 500 FEET ON AN ACCESSIBLE ROUTE

ADDITIONAL HANDICAP TOILET FACILITIES PROVIDED IN ADJACENT BUILDING ON THE SAME PROPERTY

LOCATED WITHIN 500 FEET ON AN ACCESSIBLE ROUTE ANY REQUIRED FIRE/SMOKE DETECTION AND/OR SUPPRESSION TO BE INSTALLED BY OTHERS ON SITE

IN ACCORDANCE WITH THE LOCAL BUILDING DEPARTMENT THE BUILDING OWNER IS RESPONSIBLE FOR THE DEVELOPMENT & DESIGN OF ALL SITE REQUIRED ACCESSIBILITY ELEMENTS. THESE ELEMENTS ARE

NOT INCLUDED IN THE SCOPE OF THIS DESIGN. SUBMITTALS ARE REQUIRED BY OWNER THROUGH THEIR DESIGN PROFESSIONAL

2/11/2022

REV # / DATE:

IDENTIFICATION:

DATA PLATE AND STATE DECAL TO BE LOCATED ON LOWER RIGHT HAND CORNER OF THE ENDWALL OPPOSITE THE HITCH END OF THE MODULE.

NOTES:

- SITE PLAN NOT AVAILABLE AT THIS TIME. BUILDING DESIGNED TO HAVE FIRE SEPARATION DISTANCE GREATER THAN 10 FT. TO PROPERTY LINES AS PER LOCAL BUILDING DEPARTMENT REQUIREMENTS.
- THIS PLAN MAY BE REVERSED AND/OR MIRRORED. SEE STRUCTURAL PACKAGE FOR ALL STRUCTURAL STANDARDS AND DETAILS. APPROVAL # F8073-2


R. MARK STEELE, P.E. **CORPORATE ENGINEER** SUNBELT MODULAR, INC 5301 W. MADISON ST. PHOENIX, AZ. 85043 (602) 327-4769

☐ APPROVED	SHEET:
☐ APPROVED EXCEPT AS NOTED	
☐ REVISE AND RESUBMIT	

_ DATE:_ "PLEASE REVIEW DRAWINGS AND SPECIFICATIONS CAREFULLY. WHILE EVERY EFFORT IS MADE TO ASSURE THE DRAWINGS REFLECT THE


EXPECTATIONS AND QUOTATION, THE FINAL CONSTRUCTION WILL BE BASED SOLELY ON THE SPECIFICATIONS AND DRAWINGS APPROVED."

OF

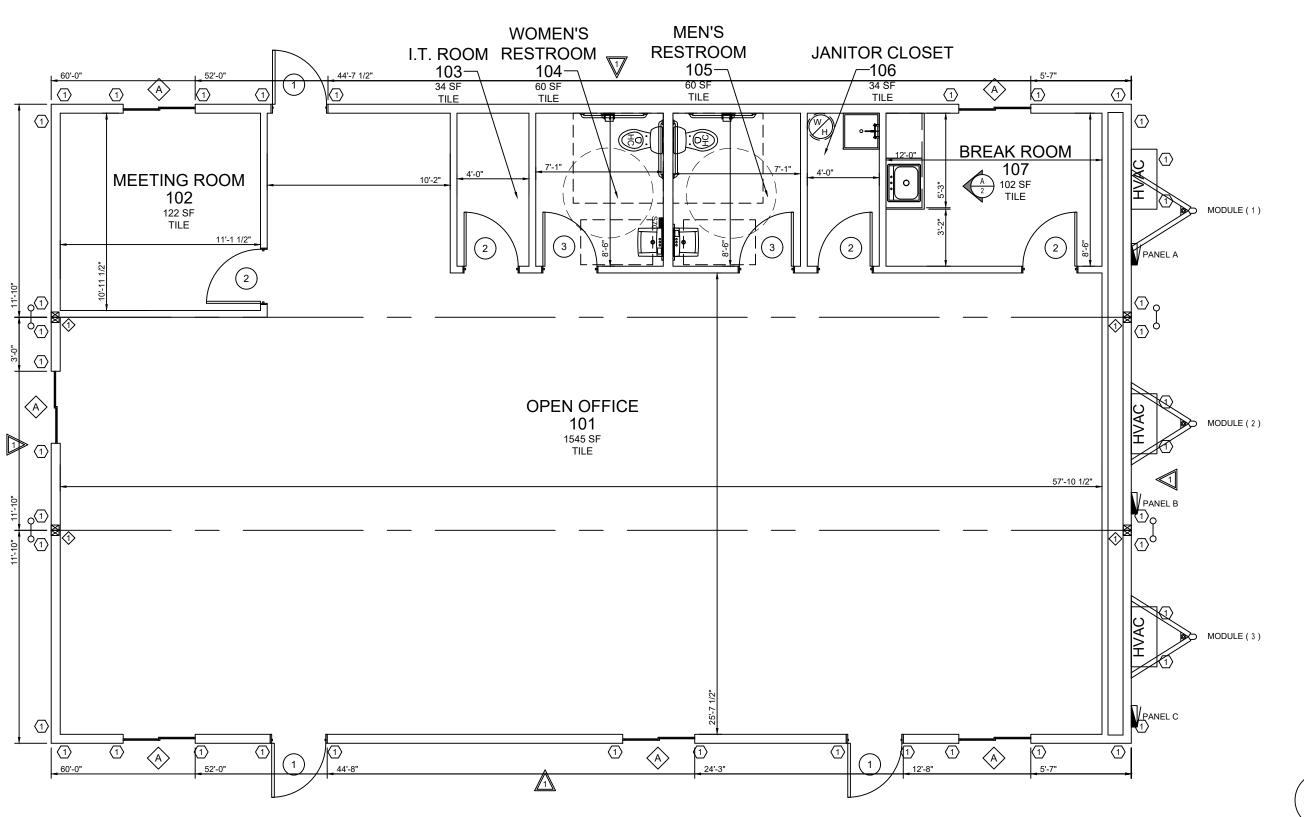


ALL INTERIOR DIMENSIONS ARE FROM FINISH TO FINISH & ALL EXTRIOR DIMENSIONS ARE FROM STUD TO STUD								
Symbol Description								
\triangle	SHEARWALL TAG (SEE STRUCTURAL PACKAGE FOR DESCRIPTION, SEE SHEET 24)	TYP @ 4 LOCATIONS						
$\langle X \rangle$	HOLD DOWN TAG (SEE STRUCTURAL PACKAGE FOR DESCRIPTION, SEE SHEET 24)	TYP @ 44 LOCATIONS						
$\overline{\smile}$	DIAPHRAGM CHORD TIE SIMPSON 'ST2215' (SEE DETAIL 4/5)	TYP @ 4 LOCATIONS						
1	(1) 3.5"x5.25" LVL 2.0 E GRADE ON EACH SIDE OF MOD-LINE (TYP. #3 HOLDOWN STRAP @ BOTTOM & BOLTED @ TOP)	TYP @ 4 LOCATIONS						

Symbol	Туре	Qty	Note	Description
	Water Closet	2		Floor mtd. ADA elongated tank type with shut off valve / flush handle to be on open side of r.r. (Factory standard)
	Grab Bars	2		Set(s) with (1) each 42", 36" horizontal, and 18" vertical
	Paper Holder	2		Single roll wall mount toilet paper holder mtd. ADA height (Factory standard)
•	Lavatory	2		19" X 17" White vitreous wall hung with ADA handles and shut off valves. (Factory standard)
Ö	Sink	1		25" X 22" Stainless steel single bowl sink with single faucet, ADA handle, and shut off valves (Factory standard)
Ţ	Sink	1		24x24 Floor mounted mop sink with wall mounted faucet (Factory standard)
	Mirror	2		24"x36" w/ clips mtd. 38" to bottom edge (Factor standard)
S70	Water Heater	1	Chronomite: S70WMD240V or equal	Insta-Hot Chronomite S-70 (Electric - 240V)
	Water Heater	1	6 Gallon w/ seismic straps	120v Electric with relief valve, water tight drain pan (3/4" drain), and pipe insulated first 8' (non-simulataneous operation) (Factory standard
	In-line Strainer	1	1"	Strainer at supply entrance
	Supply	1	Copper Inlet	Type M copper or Pex
	DWV System	1		ABS Schedule 40 (Manifold is by others)
	R.R. Sign	1	Door Mtd	Women's ADA restroom sign w/ braille mtd. 59" a.f.f. to center
	R.R. Sign	1	Door Mtd	Men's ADA restroom sign w/ braille mtd. 59" a.f.f. to center

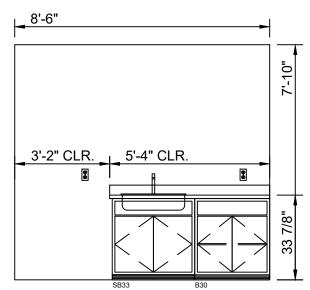

CABINET ELEVATION



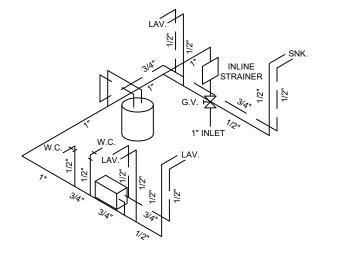

	COLD & HOT SCHEMATIC
SYM	DESCRIPTION
	COLD WATER LINE
	HOT WATER LINE
	MAX PRESSURE RANGE @ CONNECTION: 30-39 (IPC) MAX DEVELOPED LENGTH: 100'
NOTE	E:


MOP SINK 1 3
TOTAL FIXTURE UNITS: 20 = 1" INLET

DESCRIPTION WATER CLOSET

HOT / COLD SUPPLY
N.T.S.

W	IND	OWS:							
Qty	NO.	Туре	Glazing	Size	Rough Opening	U-Factor	SHGC	Mini-Blind	Notes
6	А	WHITE VINYL HORIZONTAL SLIDER	CLEAR, DUAL GLAZED, LOW-E	4/0X3/0	48" x 36"	0.31	0.22	NONE	HEADER AT 81" AFF

DO	OOR	RS:													
Qty	NO.	Туре	Jamb	Wall Thickness	Glazing	Size	Rough Opening	U-Factor	Color	Closer	Deadbolt	Hardware	Fire Rating	Keying	Notes
3	1	STEEL, INSULATED 18 GA.	TELL 16 GA. BRONZE	6 3/8"	NONE	3/0X6/8	38" x 81"	0.31	T.B.D. (SAME BOTH SIDES)	HYDRAULIC	SINGLE CYLINDER TELL GRADE 2	PASSAGE LEVER, TELL GRADE 2	NONE	ALIKE	DRIP CAP, (2) STD & (1) NRP HINGES, WEATHERSTRIPPING, THRESHOLD, DOOR SWEEP
4	2	PREFINISHED WOOD HOLLOW CORE	TIMELY METAL JAMB BROWNTONE	4 1/2"	NONE	3/0X6/8	37 1/2" x 80 3/4"	N/A	LEGACY OAK	NONE	NONE	PASSAGE LEVER, TELL GRADE 3	NONE	N/A	HINGES & WALL MOUNT STOPS
2	3	PREFINISHED WOOD HOLLOW CORE	TIMELY METAL JAMB BROWNTONE	4 1/2"	NONE	3/0X6/8	37 1/2" x 80 3/4"	N/A	LEGACY OAK	NONE	NONE	PRIVACY LEVER, TELL GRADE 3	NONE	N/A	HINGES & WALL MOUNT STOPS

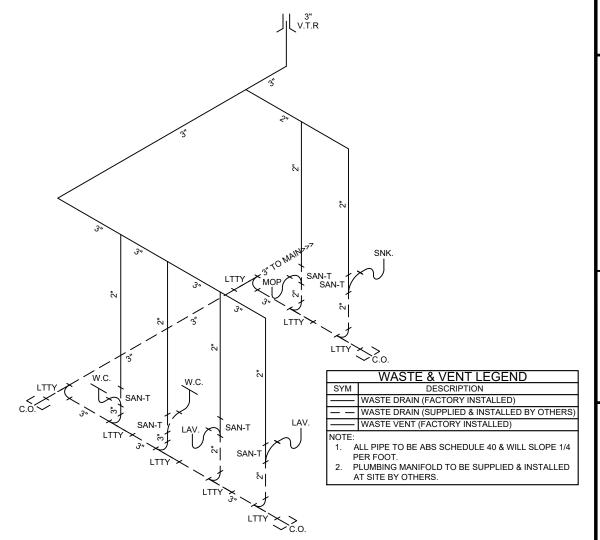

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DEALER: **DESIGN MODULARS**

PROJECT: TUBA CITY PHYSICIAN BUILDING

MODEL NUMBER:

STATES: ΑZ

SERIAL NUMBERS: PMI-5338-3660

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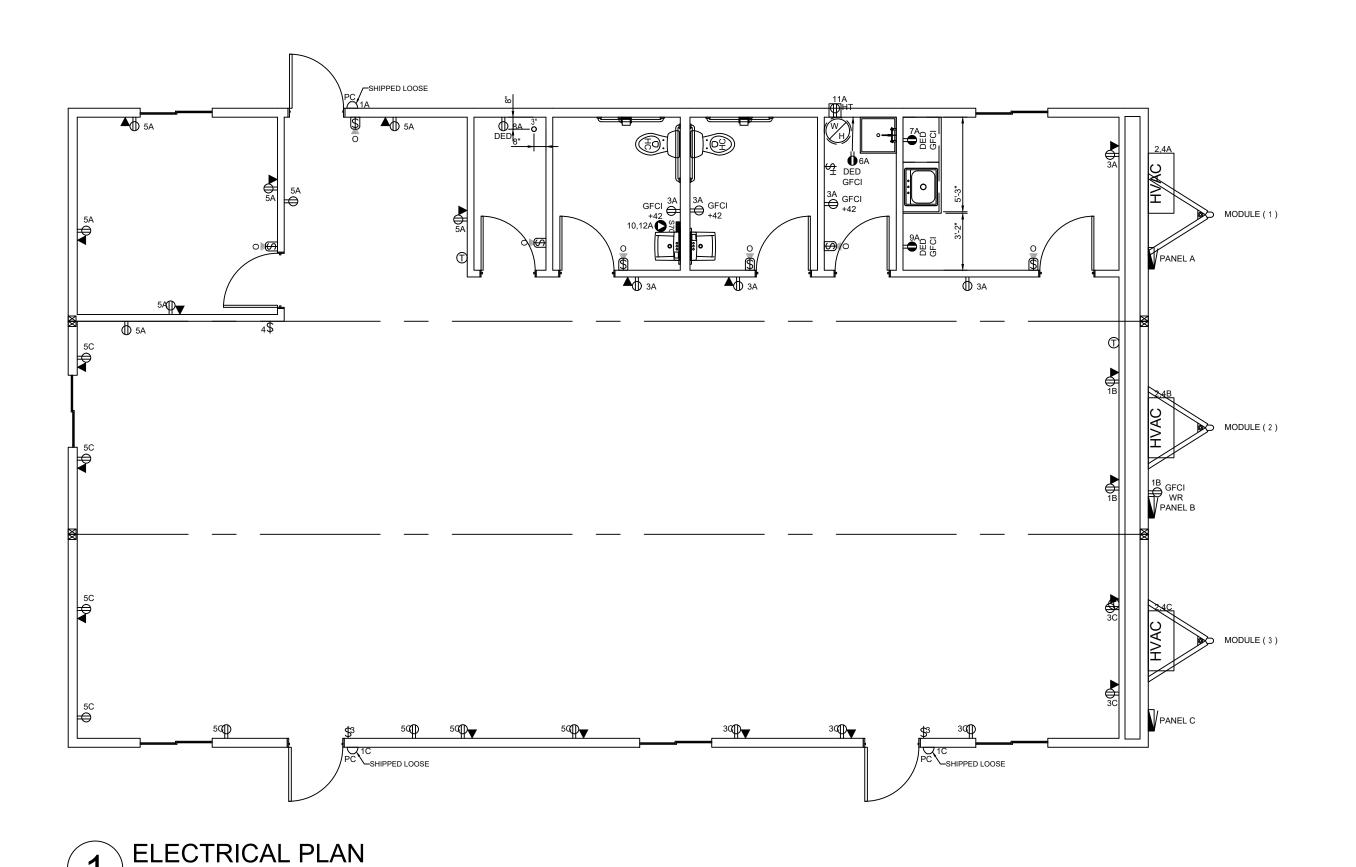
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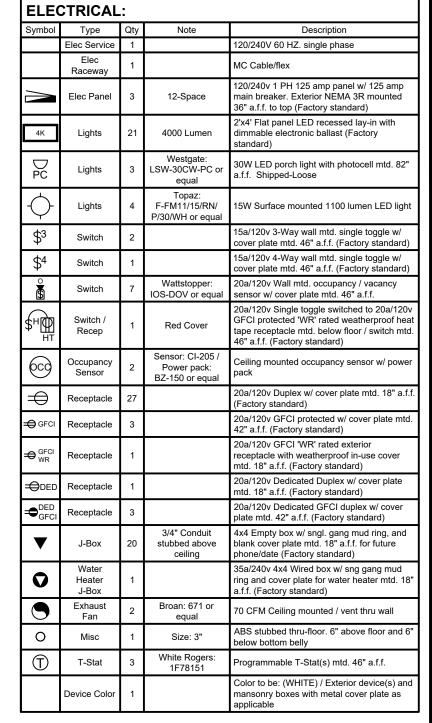
REV # / DATE:

R. MARK STEELE, P.E. CORPORATE ENGINEER SUNBELT MODULAR, INC 5301 W. MADISON ST. PHOENIX, AZ. 85043 (602) 327-4769

SHEET:

OF





NOTE:

1. ALL A.F.F. DIMENSIONS ARE TO THE CENTER OF THE DEVICE

OF THE DEVICE AND BOX UNLESS NOTED OTHERWISE (REFER TO SCHEDULE AND PLANS FOR HEIGHTS).

2. ALL ELECTRICAL ITEMS ARE FACTORY STANDARD UNLESS NOTED OTHERWISE.

3. BLANK COVERS WILL BE PROVIDED ON J-BOXES UNLESS NOTED OTHERWISE.

4. ALL EXTERIOR ELECTRICAL DEVICES TO BE WEATHERPROOF.

PANEL C

Main	Breaker: 22kAIC		125	AMP 1	20/240\	/ 1 PH	IASE	EXTERIOR: NEM	A 3R
Bran	ch Breakers: 10kAIC	PANEL '	WITH	125	AMP N	IAIN E	BREAKER	}	
ws	Description	Circuit	BRK	Α	В	BRK	Circuit	Description	ws
12	Lighto	1	20	486		\c0		3 Ton AC Unit w/ 10KW	-
12	Lights		20	6960		<i>/</i> 60	2	3 TOH AC OHL W/ TURVV	6
12	Pagantagles	3	20		1440	2			
12	Receptacles		20		6960		4		
12	Pagantagles	5	20	1440		20		6 Gal Water Heater	10
12	Receptacles		20	2500		30	6	o Gai Water Heater	10
12	Ded. Receptacle	7	20		1800	20		Ded. Receptacle	12
12	Deu. Receptacie		1 20		1800	20	8	Deu. Receptacie	12
12	Ded. Receptacle	9	20	1800		35		M-70 Tankless Water	10
12	Deu. Receptacie		20	3500		93	10	Heater	10
12	Heat Tape	11	20		600	2			
12	neat tape		20		3500		12		
				16686	16100	Tota			
	ELECTRICAL CALCUI	LATION:						PANEL A	
	GENERAL LIGHTING:	<u> </u>							
	196 LICHTS v 125%	- 608	watte		TVD	E OE	PANEI ·	I OAD CENTER	

12	Ded. Receptacle		20	3500		35	10	-	Heater	╢.
12	Heat Tape	11	20		600 3500	2	12			
			<u> </u>	16686	16100	Tota				_
	ELECTRICAL CALCULA	TION:				ı			PANEL A	
	GENERAL LIGHTING:									
	486 LIGHTS x 125% =	608	watts		TYPE	E OF	PANEL:	LOAD C	ENTER	
	16 RECEPTACLES =	2880	watts							
	1 HVAC UNITS =	13920	watts							
	2 W.H. x 125% =	9500	watts							
	1 Heat Tape =	600	watts							
										_
		27508	watts	d	ivide by	240	volts=	115	AMPS TOTAL	

Main	Breaker: 22kAIC		125	AMP 1	20/240\	/ 1 PH	IASE	EXTERIOR: NEM	A 3F
Brand	ch Breakers: 10kAlC	PANEL '	WITH	125	AMP N	IAIN E	BREAKER	र	
ws	Description	Circuit	BRK	Α	В	BRK	Circuit	Description	WS
12	Receptacles	1	20	540 6960		60	2	3 Ton AC Unit w/ 10KW	6
	Space	3			6960	2	4		
	Space	5					6	Space	
	Space	7					8	Space	
	Space	9					10	Space	
	Space	11					12	Space	
	ELECTRICAL CALCULA GENERAL LIGHTING:			7500	6960	Tota		PANEL B	
	•	= 540 = 13920	watts watts		TYP	E OF	PANEL:	LOAD CENTER	
								60 AMPS TOTAL	

3rano	ch Breakers: 10kAlC	PANEL V	WITH	125	AMP N	IAIN E	BREAKER	3	
ws	Description	Circuit	BRK	Α	В	BRK	Circuit	Description	ws
12	Lights	1	20	960 6960		60	2	3 Ton AC Unit w/ 10KW	6
12	Receptacles	3	20		900 6960	2	4		
12	Receptacles	5	20	1440			6	Space	
	Space	7					8	Space	
	Space	9					10	Space	
	Space	11					12	Space	
	<u> </u>	1	1	9360	7860	Tota			

ELECTRICAL CALCULATION:

GENERAL LIGHTING:

960 LIGHTS x 125% = 1200 watts

13 RECEPTACLES = 2340 watts

1 HVAC UNITS = 13920 watts

17460 watts divide by 240 volts= 73 AMPS TOTAL

TYPE OF PANEL: LOAD CENTER

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B

Modul

MODEL NUMBER:

STATES:

SERIAL NUMBERS: PMI-5338-3660


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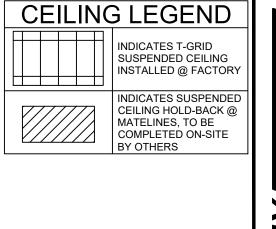
PLOT DATE: 2/11/2022

REV # / DATE:

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SHEET:



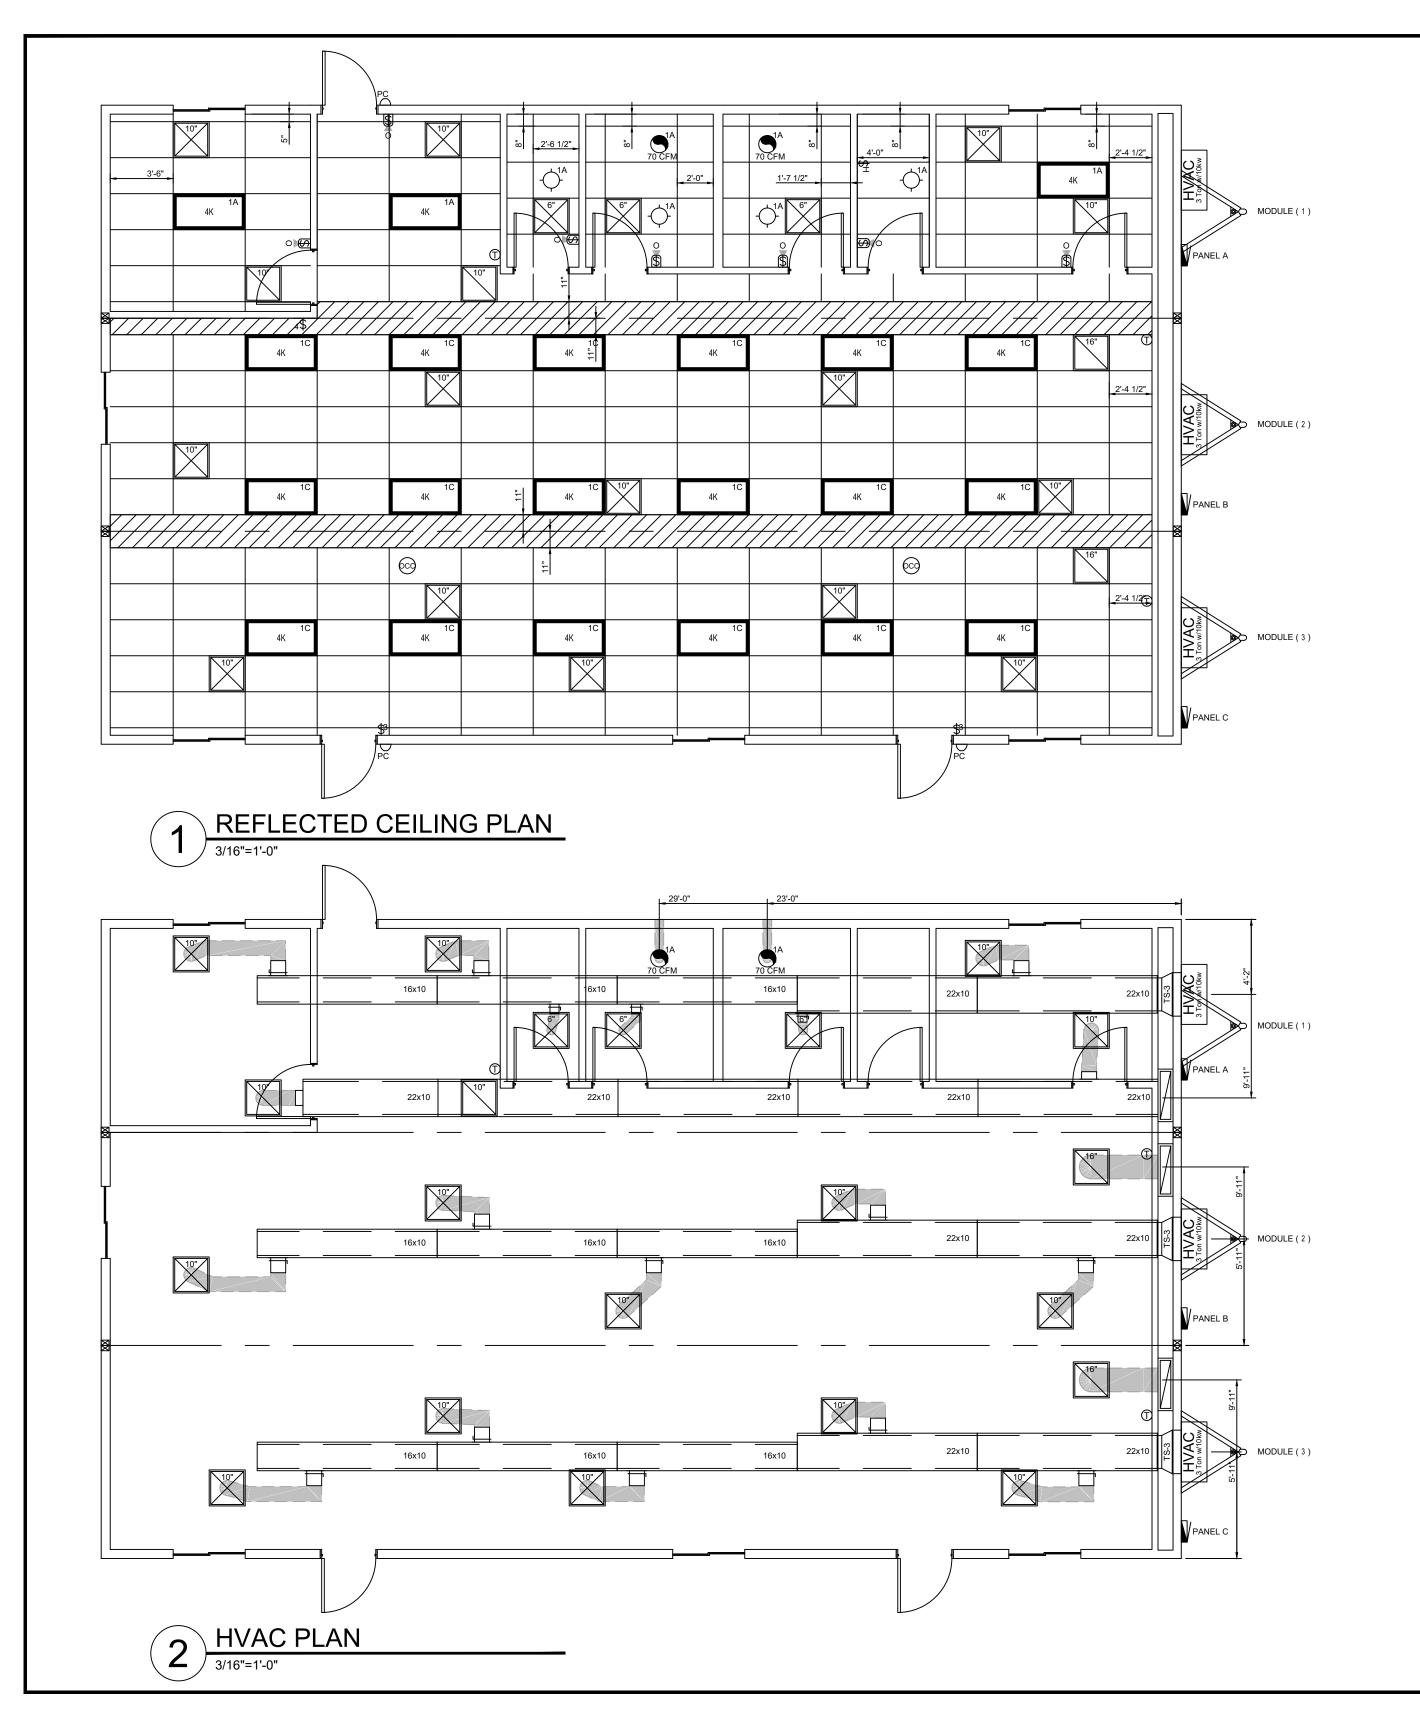

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DEALER:
DESIGN MODULARS

PROJECT:
TUBA CITY PHYSICIAN
BUILDING

MODEL NUMBER:

STATES:

AZ

SERIAL NUMBERS: PMI-5338-3660

DRAWN BY: CK/MM

PLOT DATE: 2/11/2022

REV # / DATE:

HVAC:

HVAC

 $\overline{\boxtimes}$

 \square

Symbol Type Qty

HVAC Unit

Sleeve Return Air

Fiberglass

Duct Fiberglass Duct

Fiberglass Duct

Supply Diffusers

Supply Diffusers

R/A Grille

R/A Grille

Duct type 1

Description
3 TON AC with 10kw heat strip 11 EER end mount unit / Model: W36AB-A10 or equal

29"x9" To 22"x10" Galvanized sleeve, 16" long

32"x7" Return air plenum w/ 28"x14"x6" tap-in

24" x 24" 4-way throw diffuser with start collar, collar w/ scoop and damper, and flex (Factory standard)
24" x 24" 4-way throw diffuser with start collar, collar w/ scoop and damper, and flex (Factory standard)

24" x 24" Perforated lay-in with start collar, collar, and

24" x 24" Perforated lay-in with start collar, collar, and

R-6 Fiberglass insulation. Flex duct not to exceed 14'

16"x10"x10'-0" Fiberglass

22"x10"x10'-0" Fiberglass

22"x10"x7'-6" Fiberglass

flex (Factory standard)


flex (Factory standard)

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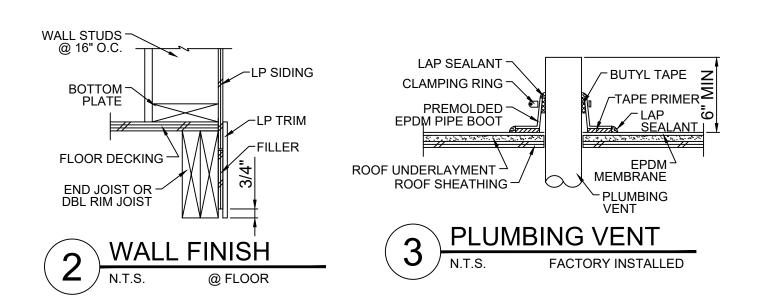
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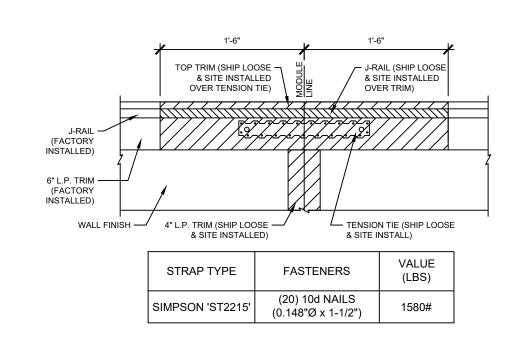
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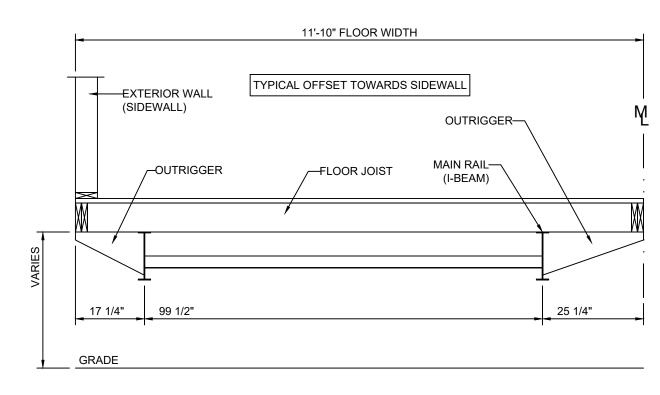


BUILDING CROSS SECTION 1/4"=1'-0"



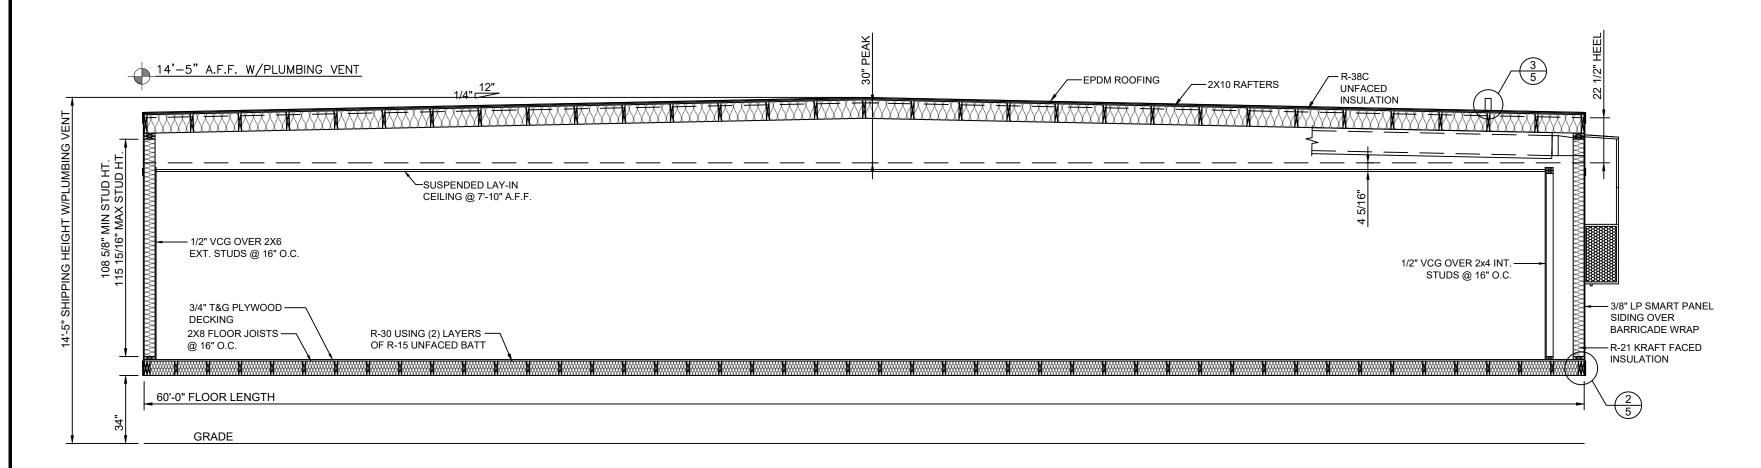

ROOF DIAPHRAGM MODLINE CHORD TIE N.T.S.



5 AXLE OFFSET N.T.S.

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DEALER:
DESIGN MODULARS

PROJECT:
TUBA CITY PHYSICIAN
BUILDING

MODEL NUMBER:

STATES: AZ

SERIAL NUMBERS: PMI-5338-3660

DRAWN BY: CK/MM


PLOT DATE: 2/11/2022

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SHEET:

6



ELEVATION 'A'
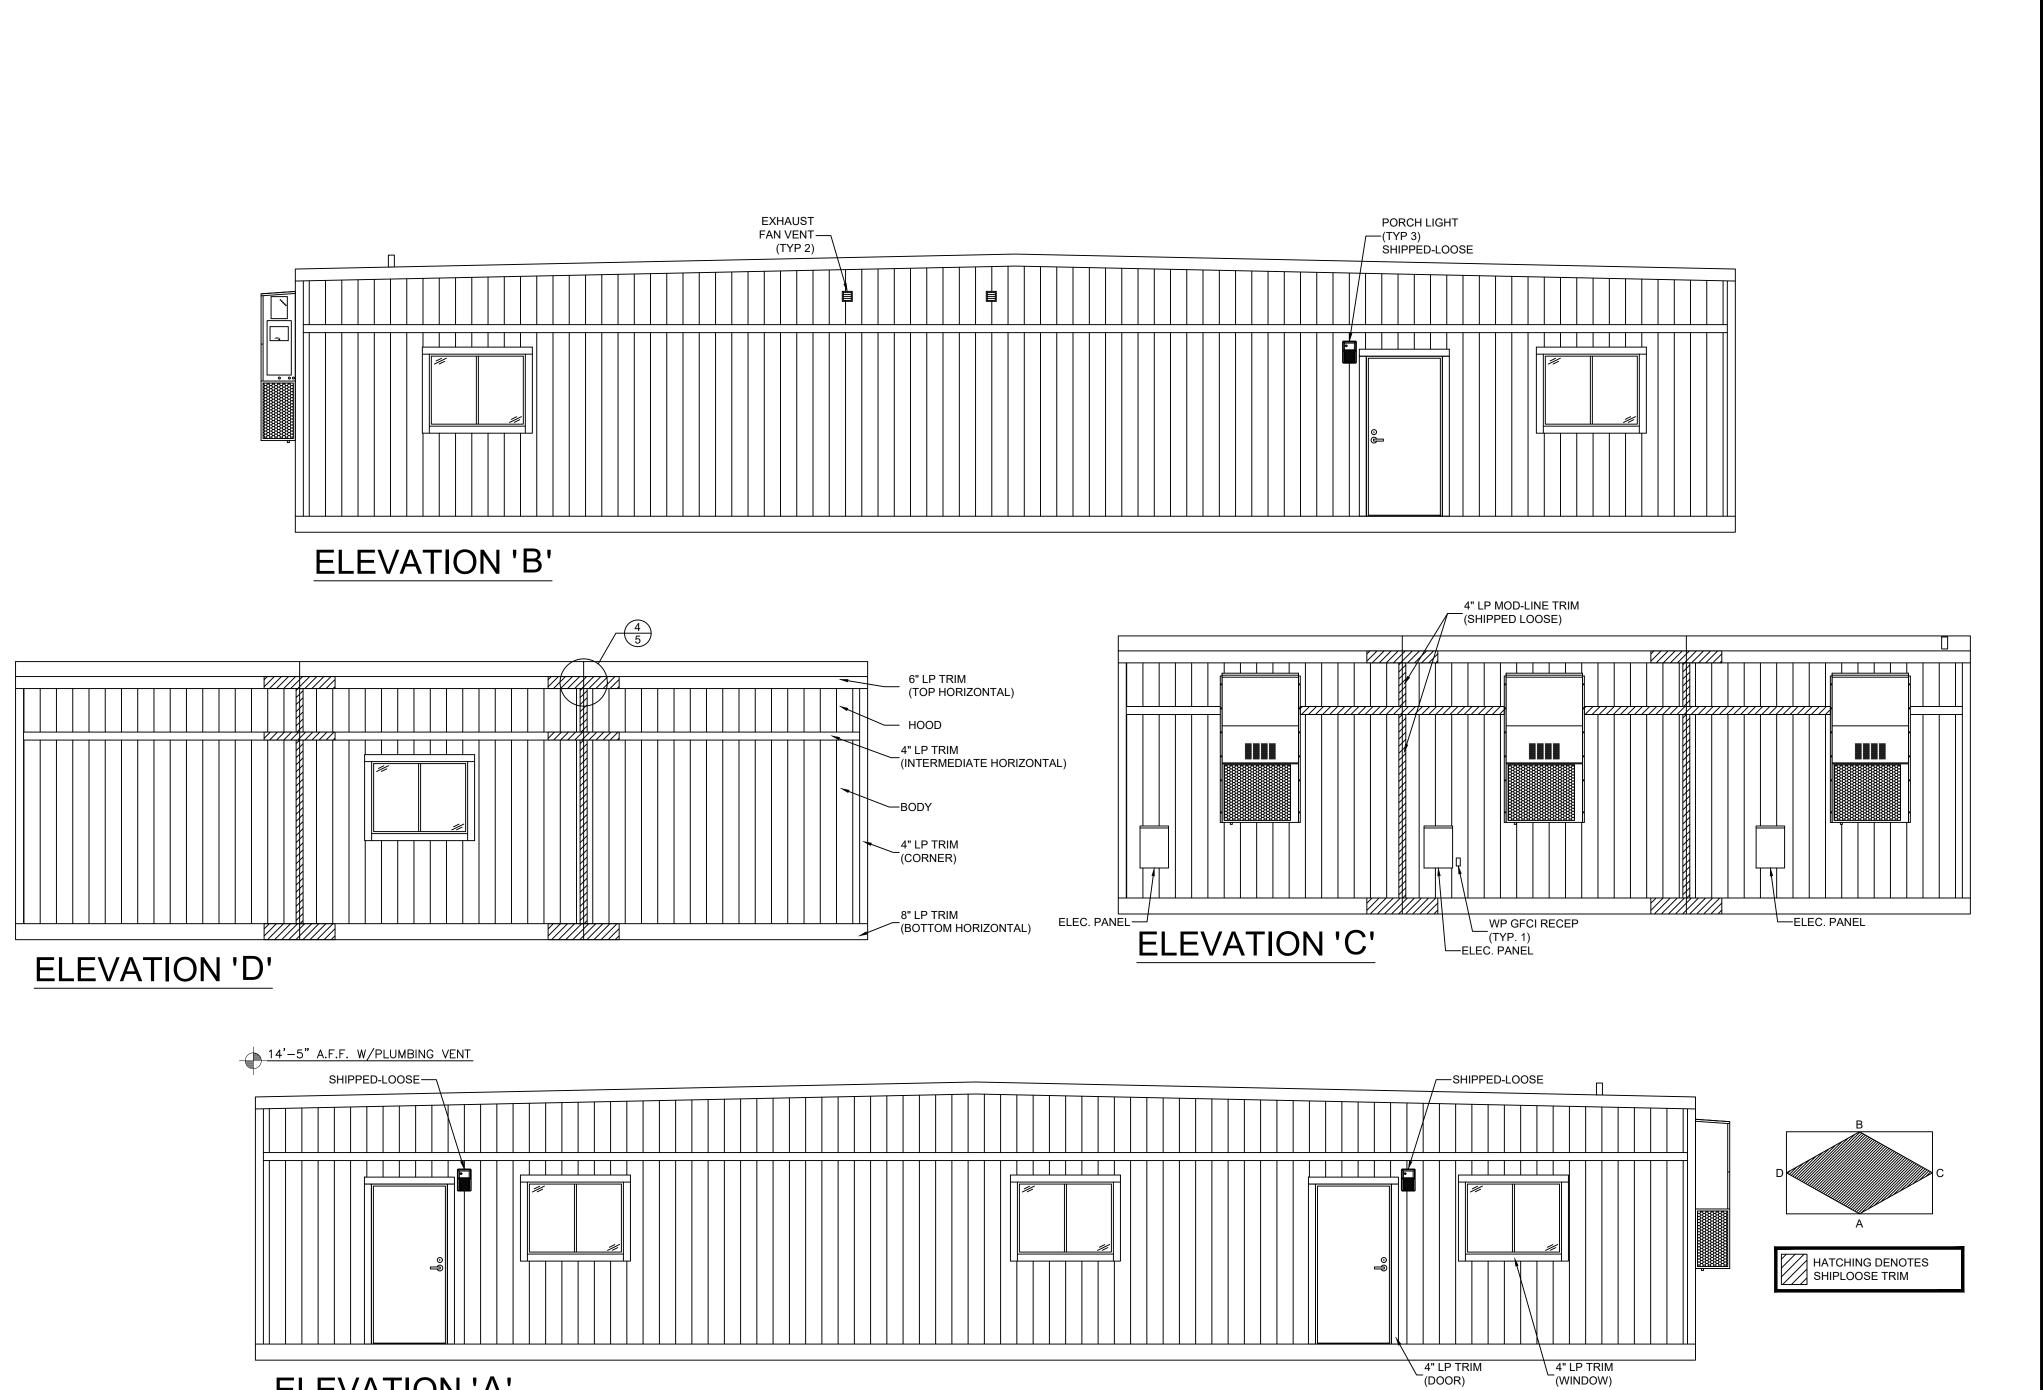
#MODULAR

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DEALER: DESIGN MODULARS

PROJECT: TUBA CITY PHYSICIAN BUILDING

MODEL NUMBER:

STATES:

ΑZ

SERIAL NUMBERS: PMI-5338-3660

DRAWN BY: CK/MM

PLOT DATE: 2/11/2022

REV # / DATE:

R. MARK STEELE, P.E. CORPORATE ENGINEER SUNBELT MODULAR, INC 5301 W. MADISON ST. PHOENIX, AZ. 85043 (602) 327-4769

SHEET:

(WINDOW)

OF